GENERAL NOTES:

- 1. CONTRACTOR SHALL NOTIFY THE COUNTY DESIGNEE AND/OR COUNTY INSPECTOR 48 HOURS PRIOR TO INITIATION OF CONSTRUCTION.
 2. IT IS THE RESPONSIBILITY OF THE CONTRACTOR TO WIPE OUT OR ADJUST THE CROWN WHERE SO NOTED BY THE ENGINEER AND/OR REQUIRED FOR POSITIVE DRAINAGE.
- 3. PROPERTY OBSTRUCTIONS WHICH ARE TO REMAIN IN PLACE, SUCH AS BUILDINGS, SEWERS, DRAINS, WATER, OR GAS PIPES, CONDUITS, RAILROAD TRACK, POLES, WALLS, POSTS, BRIDGES, ETC., ARE TO BE CAREFULLY PROTECTED AND ARE NOT TO BE DISPLACED, UNLESS NOTED.
- 4. THE CONTRACTOR SHALL NOTIFY THE SUPERINTENDENTS OF THE WATER, GAS, SEWER, TELEPHONE, AND POWER COMPANIES 10 DAYS IN ADVANCE, THAT HE INTENDS TO START WORK IN A SPECIFIC AREA. THE OWNER DISCLAIMS ANY RESPONSIBILITY FOR THE SUPPORT AND PROTECTION OF SEWERS, DRAINS, WATER PIPES, GAS PIPES, CONDUITS OF ANY KIND, UTILITIES OR OTHER STRUCTURES OWNED BY THE CITY, COUNTY, STATE OR BY PRIVATE OR PUBLIC UTILITIES LEGALLY OCCUPYING ANY STREET, ALLEY, PUBLIC PLACE, OR RIGHT—OF—WAY.

5. LOCATION OF EXISTING UTILITIES SHOWN ON PLANS ARE APPROXIMATE ONLY. IT SHALL BE THE RESPONSIBILITY OF THE CONTRACTOR TO VERIFY THE LOCATION BEFORE CONSTRUCTION. FAILURE OF THE PLANS TO SHOW THE EXISTENCE OF ANY UNDERGROUND UTILITIES, STRUCTURES, ETC., SHALL NOT RELIEVE THE CONTRACTOR FROM THE RESPONSIBILITY OF PRESERVING AND PROTECTING SAID UTILITY OR STRUCTURES.

6. CONTRACTOR SHALL DISPOSE OF BY HAULING AWAY ALL EXCESS MATERIAL.

7. THE DEVELOPER/ CONTRACTOR SHALL INSTALL PRIOR TO THE START OF CONSTRUCTION AND MAINTAIN DURING CONSTRUCTION ALL SEDIMENT CONTROL MEASURES AS REQUIRED TO RETAIN ALL SEDIMENTS ON THE SITE. IMPROPER SEDIMENT CONTROL MEASURES MAY RESULT IN CODE ENFORCEMENT VIOLATION. CONTROL OF SEDIMENTATION AND EROSION SHALL BE THE CONTRACTOR'S RESPONSIBILITY. AREAS OF CONTROL AND TYPICAL SECTION OF BARRIER ARE SUGGESTIONS ONLY AND DOES NOT RELIEVE THE CONTRACTOR OF ANY OF HIS RESPONSIBILITY.

8. WHERE UNSUITABLE MATERIALS ARE ENCOUNTERED IN THE PAVED AREAS, THE UNSUITABLE MATERIAL SHALL BE EXCAVATED AND THE AREA BACK FILLED WITH GOOD SAND AND SAND/CLAY MATERIALS. THE SAME SHALL APPLY WHERE THE SUB-BASE IS SUBJECT TO RISING WATER TABLE

9. CONTRACTOR SHALL BE RESPONSIBLE FOR THE STABILIZATION OF STREET AND ROAD SHOULDERS IN ACCORDANCE WITH REQUIREMENTS OF ESCAMBIA COUNTY L.D.C. AND F.D.O.T. SPECIFICATIONS FOR ROAD AND BRIDGE CONSTRUCTION, LATEST EDITION.

10. WATER SUPPLY FACILITIES, INCLUDING MAINS, SHALL BE INSTALLED, CLEANED, DISINFECTED, AND BACTERIOLOGIC ALLY CLEARED FOR SERVICE IN ACCORDANCE WITH THE LATEST APPLICABLE AWWA STANDARDS AND COORDINATED WITH LOCAL UTILITY ENGINEER/INSPECTOR IN ACCORDANCE WITH

11. CONTRACTOR SHALL BE RESPONSIBLE FOR AND COMPLY WITH ANY TESTING REQUIRED BY THE LOCAL GOVERNING AGENCY IN ADDITION TO THE TESTING REQUIREMENTS OUTLINED IN THE SPECIFICATION.

12. PROTECTED TREES CAN BE REMOVED WITHIN THE INFRASTRUCTURE AREAS ONLY UPON APPROVED CONSTRUCTION PLANS FOR THE SUBDIVISION AND POSSIBLY OTHER PERMITS (PRE—SITE THROUGH BID, ETC.). HOWEVER, THE RESIDENTIAL LOTS AND THE LAND IN GENERAL, WILL NEED TO REMAIN VEGETATED (TREES INCLUDED) AND UNDISTURBED (NO "LAND DISTURBANCE ACTIVITIES" INCLUDING FILL MATERIALS PLACED ONSITE, ETC.) UNTIL SUCH TIME AS FURTHER BUILDING PERMITS FOR THE "DWELLINGS" ALLOW FOR THEIR REMOVAL (PER CODE). GRADING AROUND TREES WHICH ARE TO REMAIN SHALL BE AWAY FROM THE TREE IN A MANNER TO CAUSE NO DAMAGE TO THE TREE. THE CRITICAL ROOT ZONE (CRZ) SHALL NOT BE DISTURBED. THE CRZ IS REPRESENTED BY A CIRCLE, CENTERED ON THE TREE TRUNK AND HAVING A RADIUS OF ONE FOOT FOR EVERY ONE INCH OF TRUNK DIAMETER. ONE HERITAGE TREE EXISTS ONSITE AND IS TO BE PROTECTED PER LDC REQUIREMENTS.

13. SOD SHALL BE PLACE IN ACCORDANCE WITH SEC. 570 F.D.O.T. SPECIFICATIONS.

- 14. PIPELINE CONTRACTOR SHALL BE RESPONSIBLE FOR INLET TOPS AND THROATS.
- 14. THELINE GOVERNOTOR STALE BE RESTONABLE FOR TREET FOR A THE THROATE
- 15. NOTIFY COUNTY ENGINEER 24 HOURS BEFORE BEGINNING EVERY PHASE OF CONSTRUCTION

16. CONTRACTOR SHALL MAINTAIN RECORD DRAWINGS DURING CONSTRUCTION WHICH SHOW ASBUILT CONDITIONS OF ALL WORK INCLUDING PIPING, DRAINAGE STRUCTURES, OUTLET STRUCTURES, DIMENSIONS, ELEVATIONS, GRADING ETC. RECORD DRAWINGS SHALL BE PROVIDED TO THE ENGINEER OF RECORD PRIOR TO REQUESTING FINAL INSPECTION.

17. ALL PROPOSED UNDERGROUND UTILITIES WITHIN THE RIGHT-OF-WAY SHALL BE INSTALLED PRIOR TO PAVING. NO STREETS UNDER THE TWO YEAR WARRANTY WILL BE ALLOWED TO BE OPEN-CUT OR JACK AND BORED. TO ACCOMPLISH THIS REQUIREMENT, COMMON TRENCHING IS REQUIRED. COMMON TRENCHING SHALL NOT TAKE PLACE UNTIL ALL ROW ROUGH GRADES HAVE BEEN ESTABLISHED TO ENSURE PROPER UTILITY DEPTHS. IF COMMON TRENCHING IS NOT A FEASIBLE OPTION, THE DEVELOPER SHALL INSTALL CONDUIT FOR THE UTILITY NOT PARTICIPATING IN THE COMMON TRENCHING FOR ALL ROAD CROSSINGS AND THE UTILITY COMPANY WILL BE REQUIRED TO USE THE CONDUIT. THIS SHALL REQUIRE PLANNING BETWEEN THE DEVELOPER AND THE UTILITY.

18. ROUGH GRADING OF RIGHT OF WAY MUST BE ESTABLISHED PRIOR TO COMMON TRENCH UTILITY INSTALLATION TO ENSURE UTILITIES ARE INSTALLED AT PROPER DEPTHS. A MINIMUM OF 30" OF COVER IS REQUIRED OVER ALL UTILITIES. THIS DIMENSION SHALL BE MEASURED FROM PROPOSED GRADE IF ROAD IS IN FILL AND MEASURED FROM TOP OF CURB IF ROAD IS IN CUT.

19. CONTRACTOR SHALL NOTIFY ENGINEER OF RECORD AT LEAST 2 WEEKS PRIOR TO PLACEMENT OF BASE MATERIAL TO ASSIST IN COORDINATION OF ALL OTHER UNDERGROUND UTILITIES.

20. ON SITES >1 ACRE, IF >1 CONTIGUOUS ACRE IS CLEARED, A GROUND COVER SUFFICIENT TO PREVENT EROSION SHOULD BE PLANTED OR OTHERWISE STABILIZED WITHIN 10 WORKING DAYS ON THAT PORTION OF THE SITE UPON WHICH FURTHER ACTIVE CONSTRUCTION WILL NOT BE UNDERTAKEN WITHIN 90 DAYS.

21. THE PROJECT ENGINEER (ENGINEER OF RECORD) SHALL PROVIDE TO ESCAMBIA COUNTY "ASBUILT" RECORD DRAWINGS FOR VERIFICATION AND APPROVAL BY ESCAMBIA COUNTY ONE WEEK PRIOR TO REQUEST A FINAL INSPECTION, OR PROVIDE ASBUILT CERTIFICATION THAT THE PROJECT CONSTRUCTION ADHERES TO THE PERMITTED PLANS AND SPECIFICATIONS. THE ASBUILT CERTIFICATION OR THE ASBUILT RECORD DRAWINGS MUST BE SIGNED AND SEALED AND DATED BY A REGISTERED FLORIDA PROFESSIONAL ENGINEER.

22. ALL DISTURBED AREAS WHICH ARE NOT PAVED SHALL BE STABILIZED WITH SEEDING, FERTILIZER AND MULCH, HYDROSEED AND/ OR SOD.
SEEDED AREAS SHALL INCLUDE A BAHIA MIX TO ENSURE CONTINUED GROWTH AFTER WINTER MONTHS IN ACCORDANCE WITH FDOT SECTION 570 AND

23. THE OWNER OR HIS AGENT SHALL ARRANGE/ SCHEDULE WITH HE COUNTY A FINAL INSPECTION OF THE DEVELOPMENT UPON COMPLETION AND ANY INTERMEDIATE INSPECTIONS AT (850) 595-3472. ASBUILT CERTIFICATION IS REQUIRED PRIOR TO REQUEST FOR FINAL INSPECTION/ APPROVAL.

24. ALL ASPECTS OF THE STORMWATER/ DRAINAGE COMPONENTS AND OR TRANSPORTATION COMPONENTS SHALL BE COMPLETED PRIOR TO REQUESTING A FINAL INSPECTION.

25. NO DEVIATION OR REVISIONS FROM THESE PLANS BY THE CONTRACTOR SHALL BE ALLOWED WITHOUT PRIOR APPROVAL FROM BOTH THE DESIGN ENGINEER, ESCAMBIA COUNTY, AND ECUA. ANY DEVIATIONS MAY RESULT IN DELAYS IN COUNTY ACCEPTANCE OF IMPROVEMENTS.

26. DENSITY TESTS AND CORE SAMPLES WILL BE REQUIRED TO DEMONSTRATE COMPLIANCE WITH COUNTY STANDARDS PRIOR TO FINAL ACCEPTANCE

27. TO COMPLY WITH NPDES REQUIREMENTS, ALL EROSION CONTROL MEASURES SHALL BE INSPECTED AFTER EACH 1/2" RAINFALL EVENT OR AT LEAST WEEKLY. THE CONTRACTOR SHALL DOCUMENT SUCH INSPECTIONS AND EROSION CONTROL MAINTENANCE EFFORTS; INSPECTION RECORDS

28. NOTIFY SUNSHINE UTILITIES 48 HOURS IN ADVANCE PRIOR TO DIGGING WITHIN R/W. 1-800-432-4770

29. ECUA INSPECTOR OR AUTHORIZED REPRESENTATIVE MUST OBSERVE ALL CONNECTIONS TO ECUA'S EXISTING WATER AND SANITARY SEWER

30. TYPE 1 CURB CUT DRIVEWAYS ARE TO BE USED FOR ALL UTILITY ACCESS POINTS.

SHALL BE PROVIDED TO THE NPDES PERMIT APPLICANT FOR PROPER REPORTING TO FDEP.

31. ELECTRIC/PHONE/CABLE/GAS STRUCTURES INSTALLED WITHIN DRAINAGE ACCESS EASEMENTS SHALL BE LOCATED ALONG THE BOUNDARY OF THE FASEMENT TO MAXIMIZE CLEAR ACCESS FOR MAINTENANCE EQUIPMENT.

32. THE SUBGRADE IS TO BE TESTED FOR COMPACTION AT A FREQUENCY OF NOT LESS THAN ONE TEST PER 300 LINEAR FEET IN THE PROPOSED ROADWAY AREAS. COMPLIANCE TESTS WITHIN THE FILL/BACKFILL AREAS ARE TO BE PERFORMED AT A FREQUENCY OF NOT LESS THAN ONE TEST

PER 300 LINEAR FEET.

33. ALL CONCRETE PIPE JOINTS SHALL BE WRAPPED WITH FABRIC/SOCK.

34. A HEALTHY GROWTH OF GRASS WITHIN DISTURBED RIGHT-OF-WAY AREAS IS REQUIRED PRIOR TO COUNTY APPROVAL /ACCEPTANCE. IF TIME CONTRAINTS EXIST DURING THE FINAL PLAT APPROVAL AND ACCEPTANCE PROCESS, A MINIMUM OF TWO STRIPS OF SOD (MINIMUM 2' WIDE) BEHIND THE BACK OF CURB WITH ALL OTHER DISTURBED AREAS SEEDED /MULCHED/FERTILIZED WILL BE ACCEPTABLE.

35. SAG FILTERS IN CURB THROATS ARE NOT AN ALLOWABLE SEDIMENT CONTROL METHOD.

36. A MINIMUM ONE (1) FOOT GROUND COVER IS REQUIRED FOR ALL UNDERGROUND PIPES

37. THE CONTRACTOR SHALL NOTIFY FDOT 48 HOURS IN ADVANCE PRIOR TO INITIATING ANY WORK IN THE STATE RIGHTS-OF-WAY.

38. RETENTION/DETENTION AREAS SHALL BE SUBSTANTIALLY COMPLETE PRIOR TO ANY CONSTRUCTION ACTIVITIES THAT MAY INCREASE STORMWATER RUNOFF RATES. THE CONTRACTOR SHALL CONTROL STORMWATER DURING ALL PHASES OF CONSTRUCTION AND TAKE ADEQUATE MEASURES TO PREVENT THE EXCAVATED POND FROM BLINDING DUE TO SEDIMENTS.

39. DEVELOPER/CONTRACTOR/HOME OWNERS ASSOCIATION SHALL RESHAPE PER PLAN SPECIFICATIONS, CLEAN OUT ACCUMULATED SILT, AND STABILIZE RETENTION/DETENTION POND(S) AT THE END OF CONSTRUCTION WHEN ALL DISTURBED AREAS HAVE BEEN STABILIZED AND AT THE END OF THE 2 YEAR WARRANTY PERIOD.

40. WORK PROPOSED NEXT TO THE R/W WITH EXISTING SWALE SYSTEMS MAY REQUIRE ADDITIONAL PROVISIONS TO REPAIR/RESTORE EXISTING DRAINAGE SWALES AS NEEDED TO ENSURE ADEQUATE DRAINAGE. R/W SHOULDER STABILIZATION SHOULD BE IN ACCORDANCE WITH FDOT STANDARD SPECIFICATIONS FOR ROAD AND BRIDGE CONSTRUCTION LATEST EDITION.

LEGAL DESCRIPTION

BEGIN AT THE INTERSECTION OF THE WEST LINE OF PEPPER RIDGE SUBDIVISION AS RECORDED IN PLAT BOOK 13 AT PAGE 1 OF THE PUBLIC RECORDS OF ESCAMBIA COUNTY, FLORIDA, WITH THE NORTH LINE OF SECTION 39, TOWNSHIP 1 SOUTH, RANGE 30 WEST, THENCE SOUTH 78°27'37" WEST ALONG THE NORTH LINE OF SECTION 39 FOR 1132.28 FEET; THENCE SOUTH 19°28'15" EAST FOR 586.28 FEET; THENCE SOUTH 72°41'25" EAST FOR 378.89 FEET TO THE NORTHWEST CORNER OF FOREST PINES 2ND. ADDITION AS RECORDED IN PLAT BOOK 12 AT PAGE 27; THENCE CONTINUE SOUTH 72°41'25" EAST ALONG THE NORTHERLY LINE OF FOREST PINES 2ND. ADDITION FOR 268.83 FEET; THENCE NORTH 35°42'05" EAST FOR 151.40 FEET TO THE SOUTHWEST CORNER OF LOT 1, PEPPER RIDGE SUBDIVISION; THENCE NORTH 13°43'00" EAST ALONG THE WEST LINE OF PEPPER RIDGE SUBDIVISION FOR 873.96 FEET TO THE POINT OF BEGINNING.

THE ABOVE DESCRIBED PARCEL IS SITUATED IN SECTION 39, TOWNSHIP-1-SOUTH, RANGE-30-WEST, ESCAMBIA COUNTY, FLORIDA AND CONTAINS 16.12 ACRES MORE OR LESS.


CONSTRUCTION PLANS FOR

Bellview Pointe

A 62 LOT SINGLE FAMILY RESIDENTIAL SUBDIVISION IN A PORTION OF SECTION 39, TOWNSHIP 1 SOUTH, RANGE 30, ESCAMBIA COUNTY, FLORIDA

March 2022

ZONED: MDR FLU: MU-U

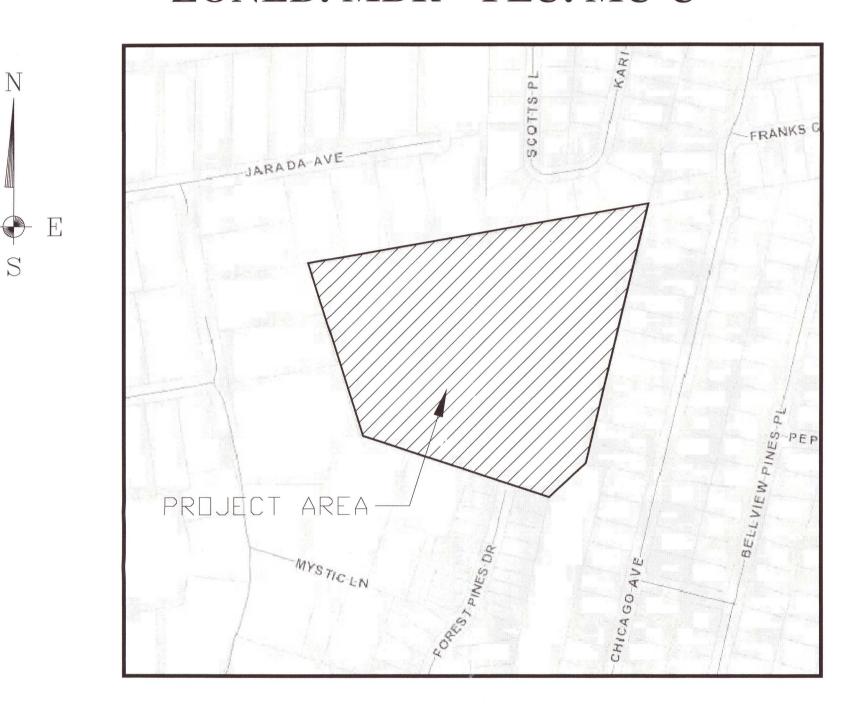

VICINITY MAP

OWNER AND DEVELOPER BELLVIEW PROPERTIES, LLC

120 E. MAIN STREET, SUITE A PENSACOLA, FL 32502 PHONE: (850) 429-8640

CONTRACTOR SHALL NOTIFY SUNSHINE 811 48 HOURS PRIOR TO

COMMENCING CONSTRUCTION 1-800-432-4770

GULF POWER CO. $\sim 429-2603$

PENSACOLA ENERGY ~ 474-5309

 $AT&T \sim 436-1489$

ECUA $\sim 969-5823$

ENGINEER-OF-RECORD

DAVID W. FITZPATRICK

PROFESSIONAL ENGINEER, PA 10250 N. PALAFOX HWY. PENSACOLA, FL 32534 PHONE: (850) 476-8677 FAX: (850) 476-7708 FITZPATRICK@FITZENG.COM SURVEYOR

MERRILL PARKER SHAW, INC. 4928 N. DAVIS HWY. PENSACOLA, FL 32503

LB#7174 P: (850)478-4923 F: (850)478-4924

DRAINAGE FEE

Imperv. Surf. 58771.0 Sq ft
Stormwater Ret. 0.46 % (F)
Total Drainage Fee \$ 3,050.00
Pond Maint. Fee: MSBU

Approved Designee Date

This document has been reviewed in accordance with requirements of applicable Escambia County Regulations and Ordinances and does not in any way relieve the submitting Architect, Engineer, Surveyor, or other signatory from responsibility of details as drawn.

ECUA Engineering Manual Reference Note* *note shall be inserted in the upper right corner of title sheet

* applicable only to ECUA infrastructure to be constructed in public ROW or in utility easement; not to be applied to private water/sewer facilities on private property (see Building Code)

A. ECUA Engineering Manual Incorporated by Reference

The ECUA Engineering Manual, dated December 18, 2014, along with Update # 1 dated September 1, 2016 (hereinafter "Manual"), located at www.ecua.fl.gov, is hereby incorporated by reference into this Project's official contract documents as if fully set forth therein. It is the Contractor's responsibility to be knowledgeable of the Manual's contents and to construct the Project in accordance with the Manual. The Contractor shall provide its employees access to the Manual at all times, via Project site or office, via digital or paper format. In the event of a conflict between the Manual and Plans, Contractor shall consult Engineer of Record for proper resolution.

B. Additional Documents (to be completed by the Engineer of Record)

Does this Project have additional technical specifications or construction details that supplement and/or supersede the Manual listed above? ☐YES NO☒. If yes, Contractor shall construct Project in accordance with said documents as listed and located below:

	Document Name	Docume	Document Type		Location	
		Specifi- cation	Detail	Plans	Project Manual*	

*Project Manuals used only with ECUA CIP Projects

C. Engineer of Record Responsibilities

The Engineers of Record (EORs) that have affixed their seals and signatures on these plans warrant their portions of the plans have been designed in accordance with the Manual (unless otherwise directed by the ECUA Project Engineer). The EORs shall be knowledgeable of the Manual's contents and shall assume responsibility for its use on this Project.


	INDEX OF DRAWINGS		
SHEET	DESCRIPTION		
1	COVER SHEET		
2	EXISITNG CONDITIONS		
3	DIMENSION PLAN		
4	UTILITY PLAN-OVERALL		
5	UTILITY PLAN-SOUTH		
6	UTILITY PLAN-NORTH		
7	DRAINAGE PLAN-OVERALL		
8	DRAINAGE PLAN-SOUTH		
9	DRAINAGE PLAN-NORTH		
10	FOREST PINES PLAN/PROFILE		
11	BELLVIEW POINTE LANE PLAN/PROFILE		
12	BELLVIEW POINTE CIR. PLAN/PROFILE		
13	NORTH SWALE PLAN/PROFILE		
14	EAST SWALE PLAN/PROFILE		
15	POND OUTFALL PLAN/PROFILE		
16	OFFSITE STORMWATER		
17	OFFSITE STORMWATER		
18	MISC. PROFILES		
19	MISC. PROFILES		
20	OFFSITE SEWER		
21	OFFSITE SEWER		
22	OFFSITE SEWER		
23	OFFSITE SEWER		
24	OFFSITE SEWER		
25	POND 1 DETAILS		
26	POND 2 DETAILS		
27	ROAD DETAILS		
28	DRAINAGE DETAILS		

THE SUBJECT PROPERTY AS SHOWN HEREON IS LOCATED IN FLOOD ZONE X (MINIMAL RISK AREAS OUTSIDE THE 1-PERCENT AND 0.2-PERCENT-ANNUAL-CHANCE FLOODPLAINS. NO BFES OR BASE FLOOD DEPTHS ARE SHOWN WITHIN THESE ZONES), AS DETERMINED FROM THE FEDERAL EMERGENCY MANAGEMENT AGENCY FLOOD INSURANCE RATE MAP OF ESCAMBIA COUNTY, FLORIDA, COMMUNITY 120080, FIRM MAP PANEL NUMBERS 12033C0360G, MAP REVISION DATED SEPTEMBER 29, 2006.

PERMIT SET

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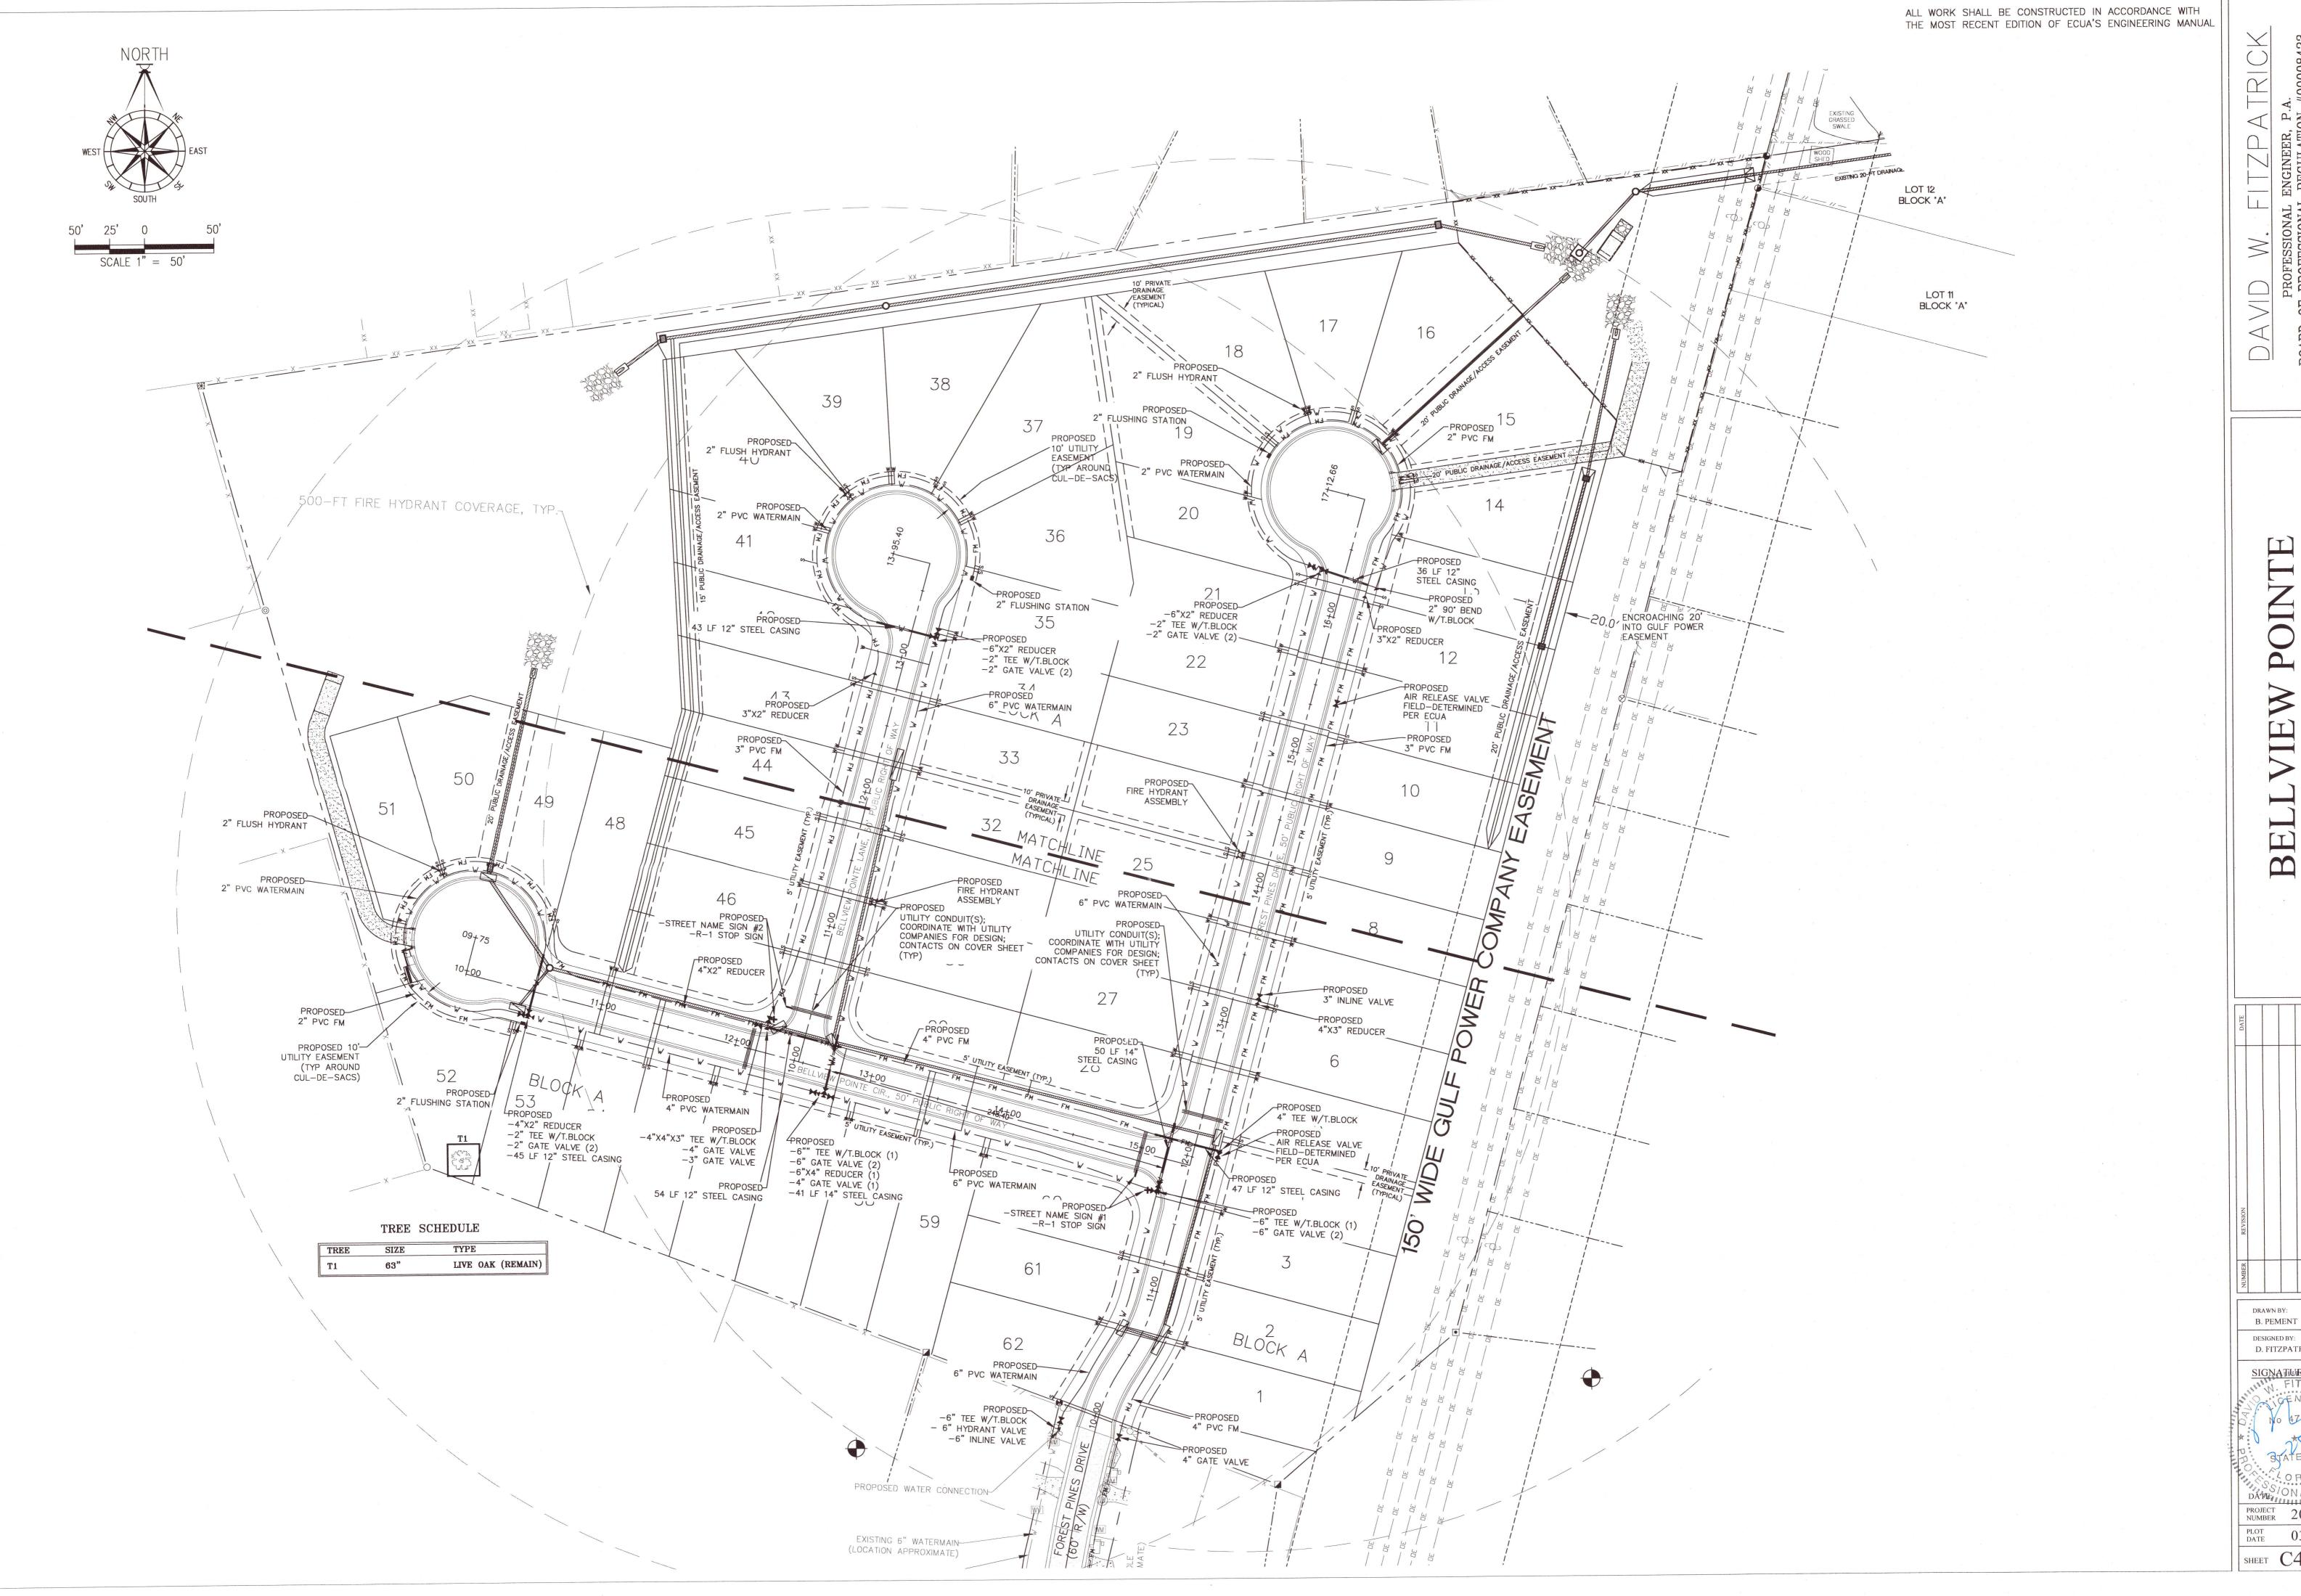




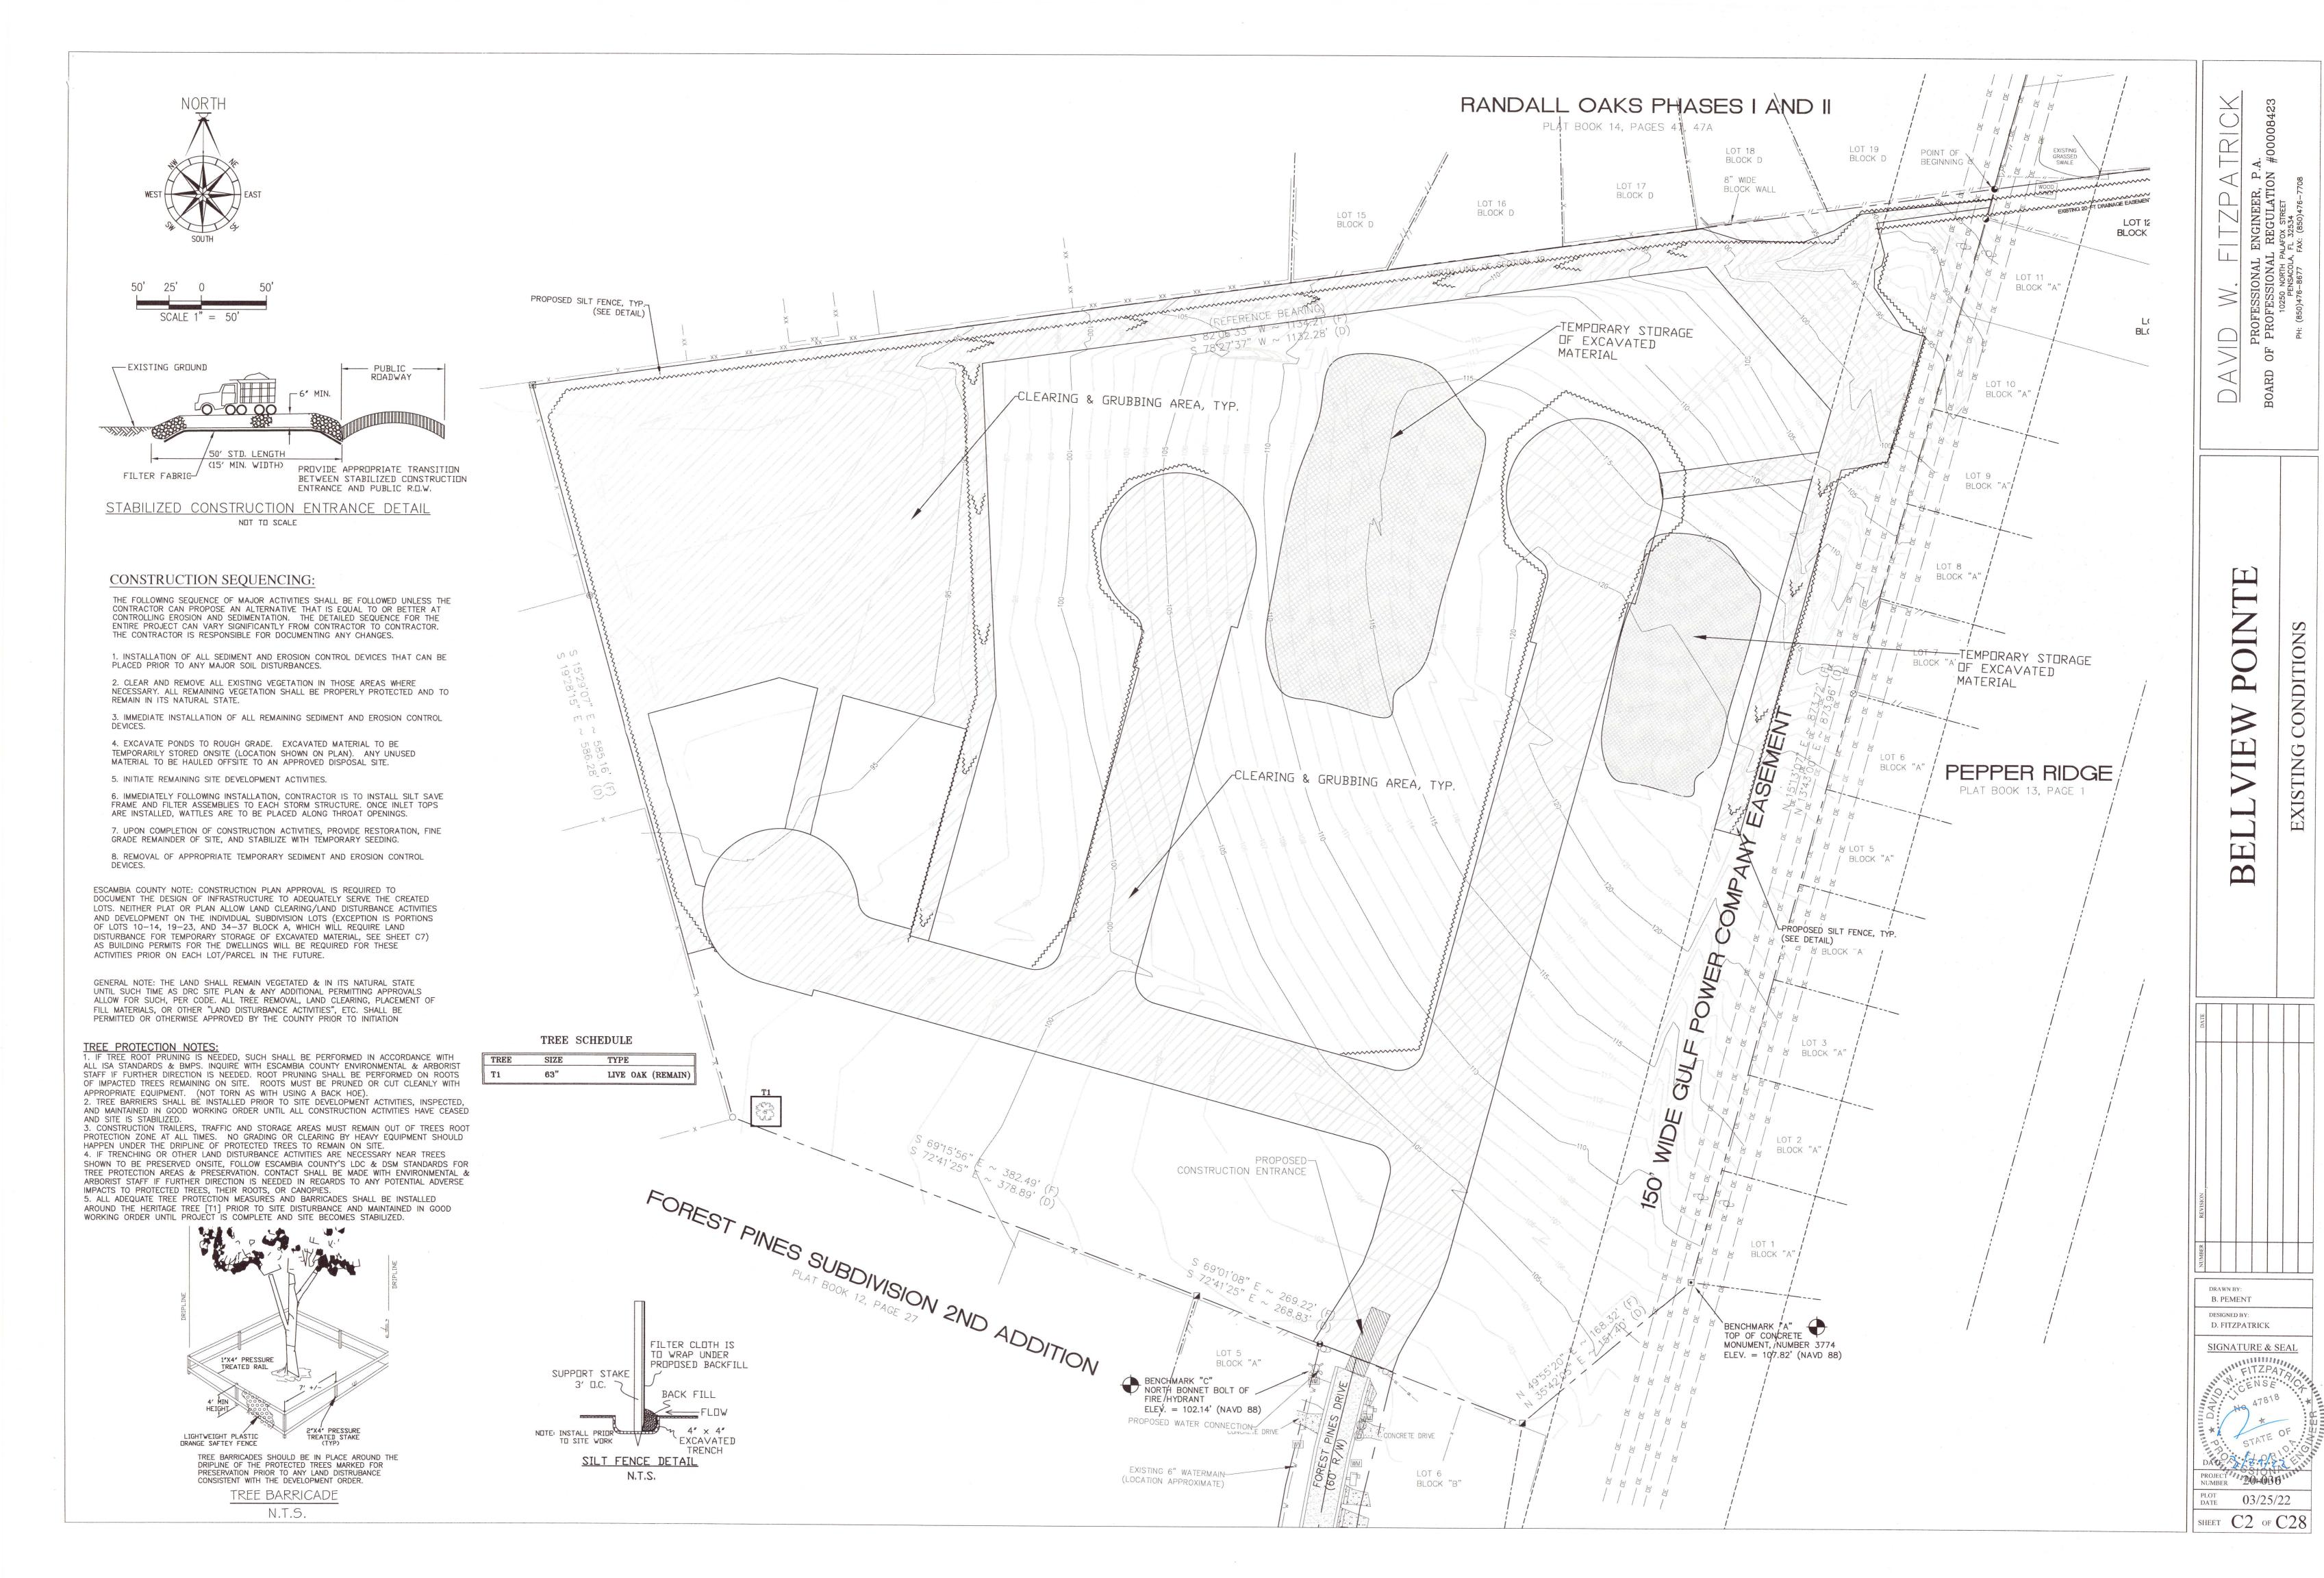

PLAN DIMENSION

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B. PEMENT


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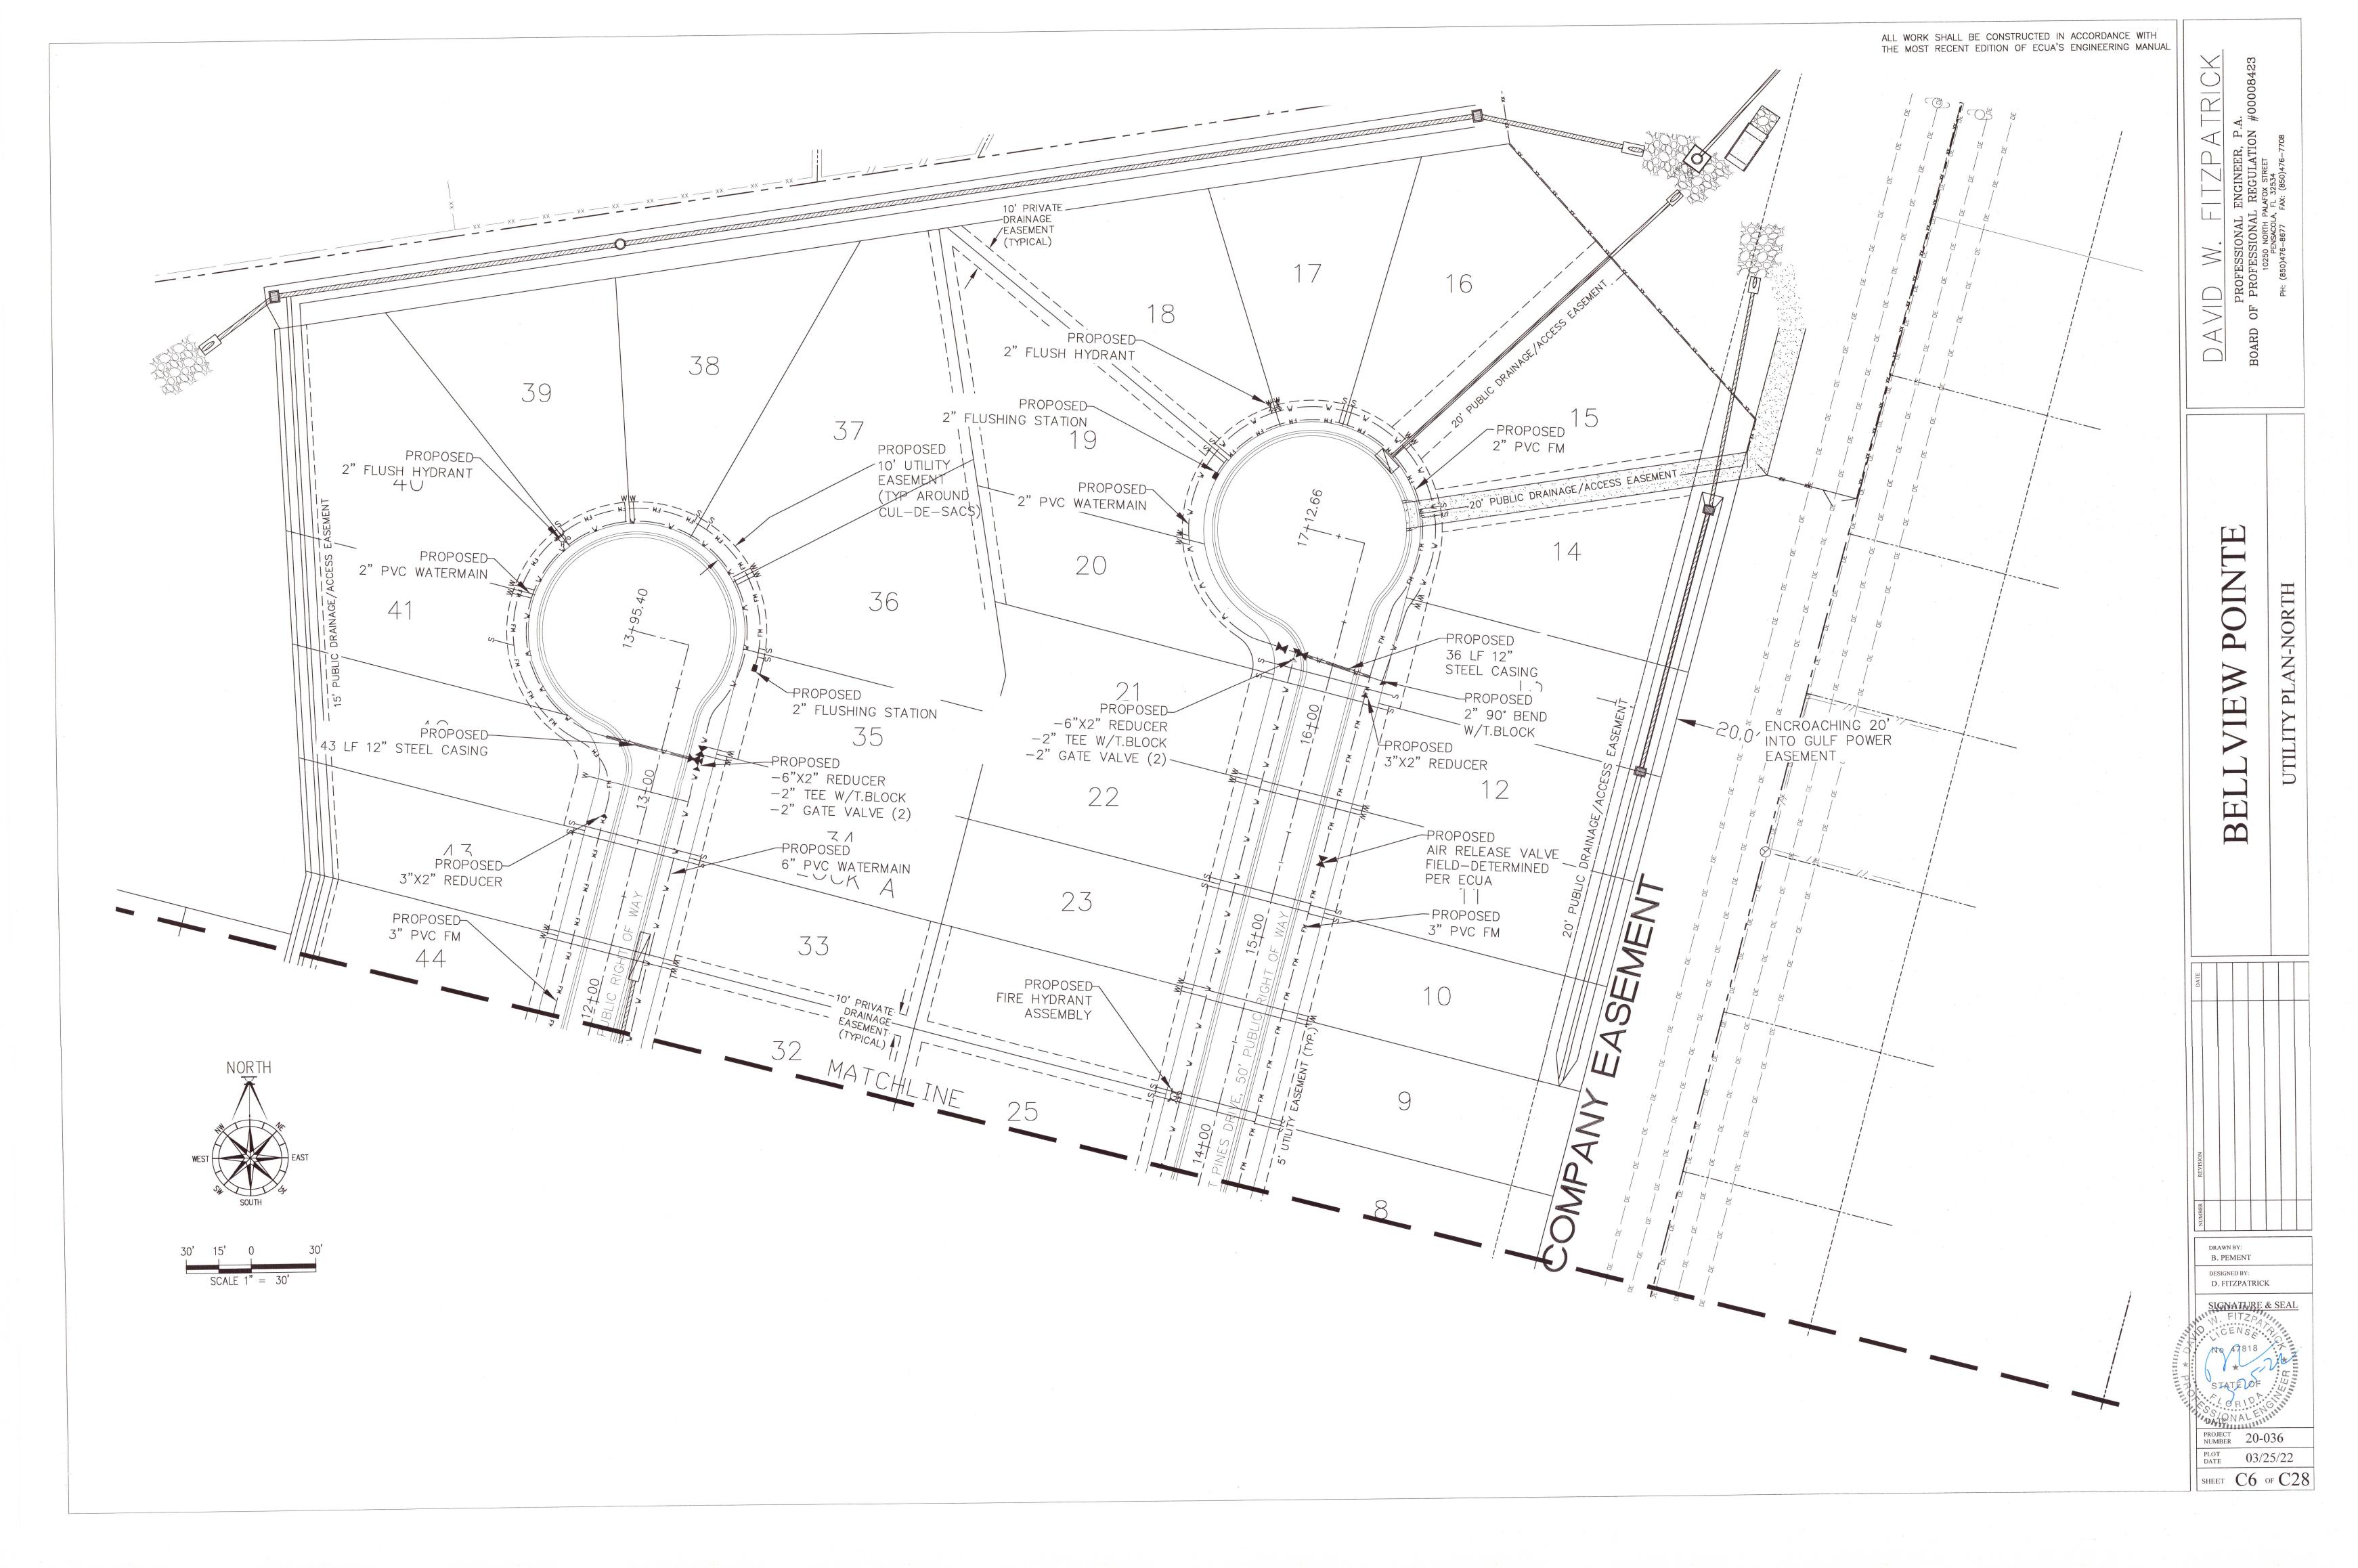
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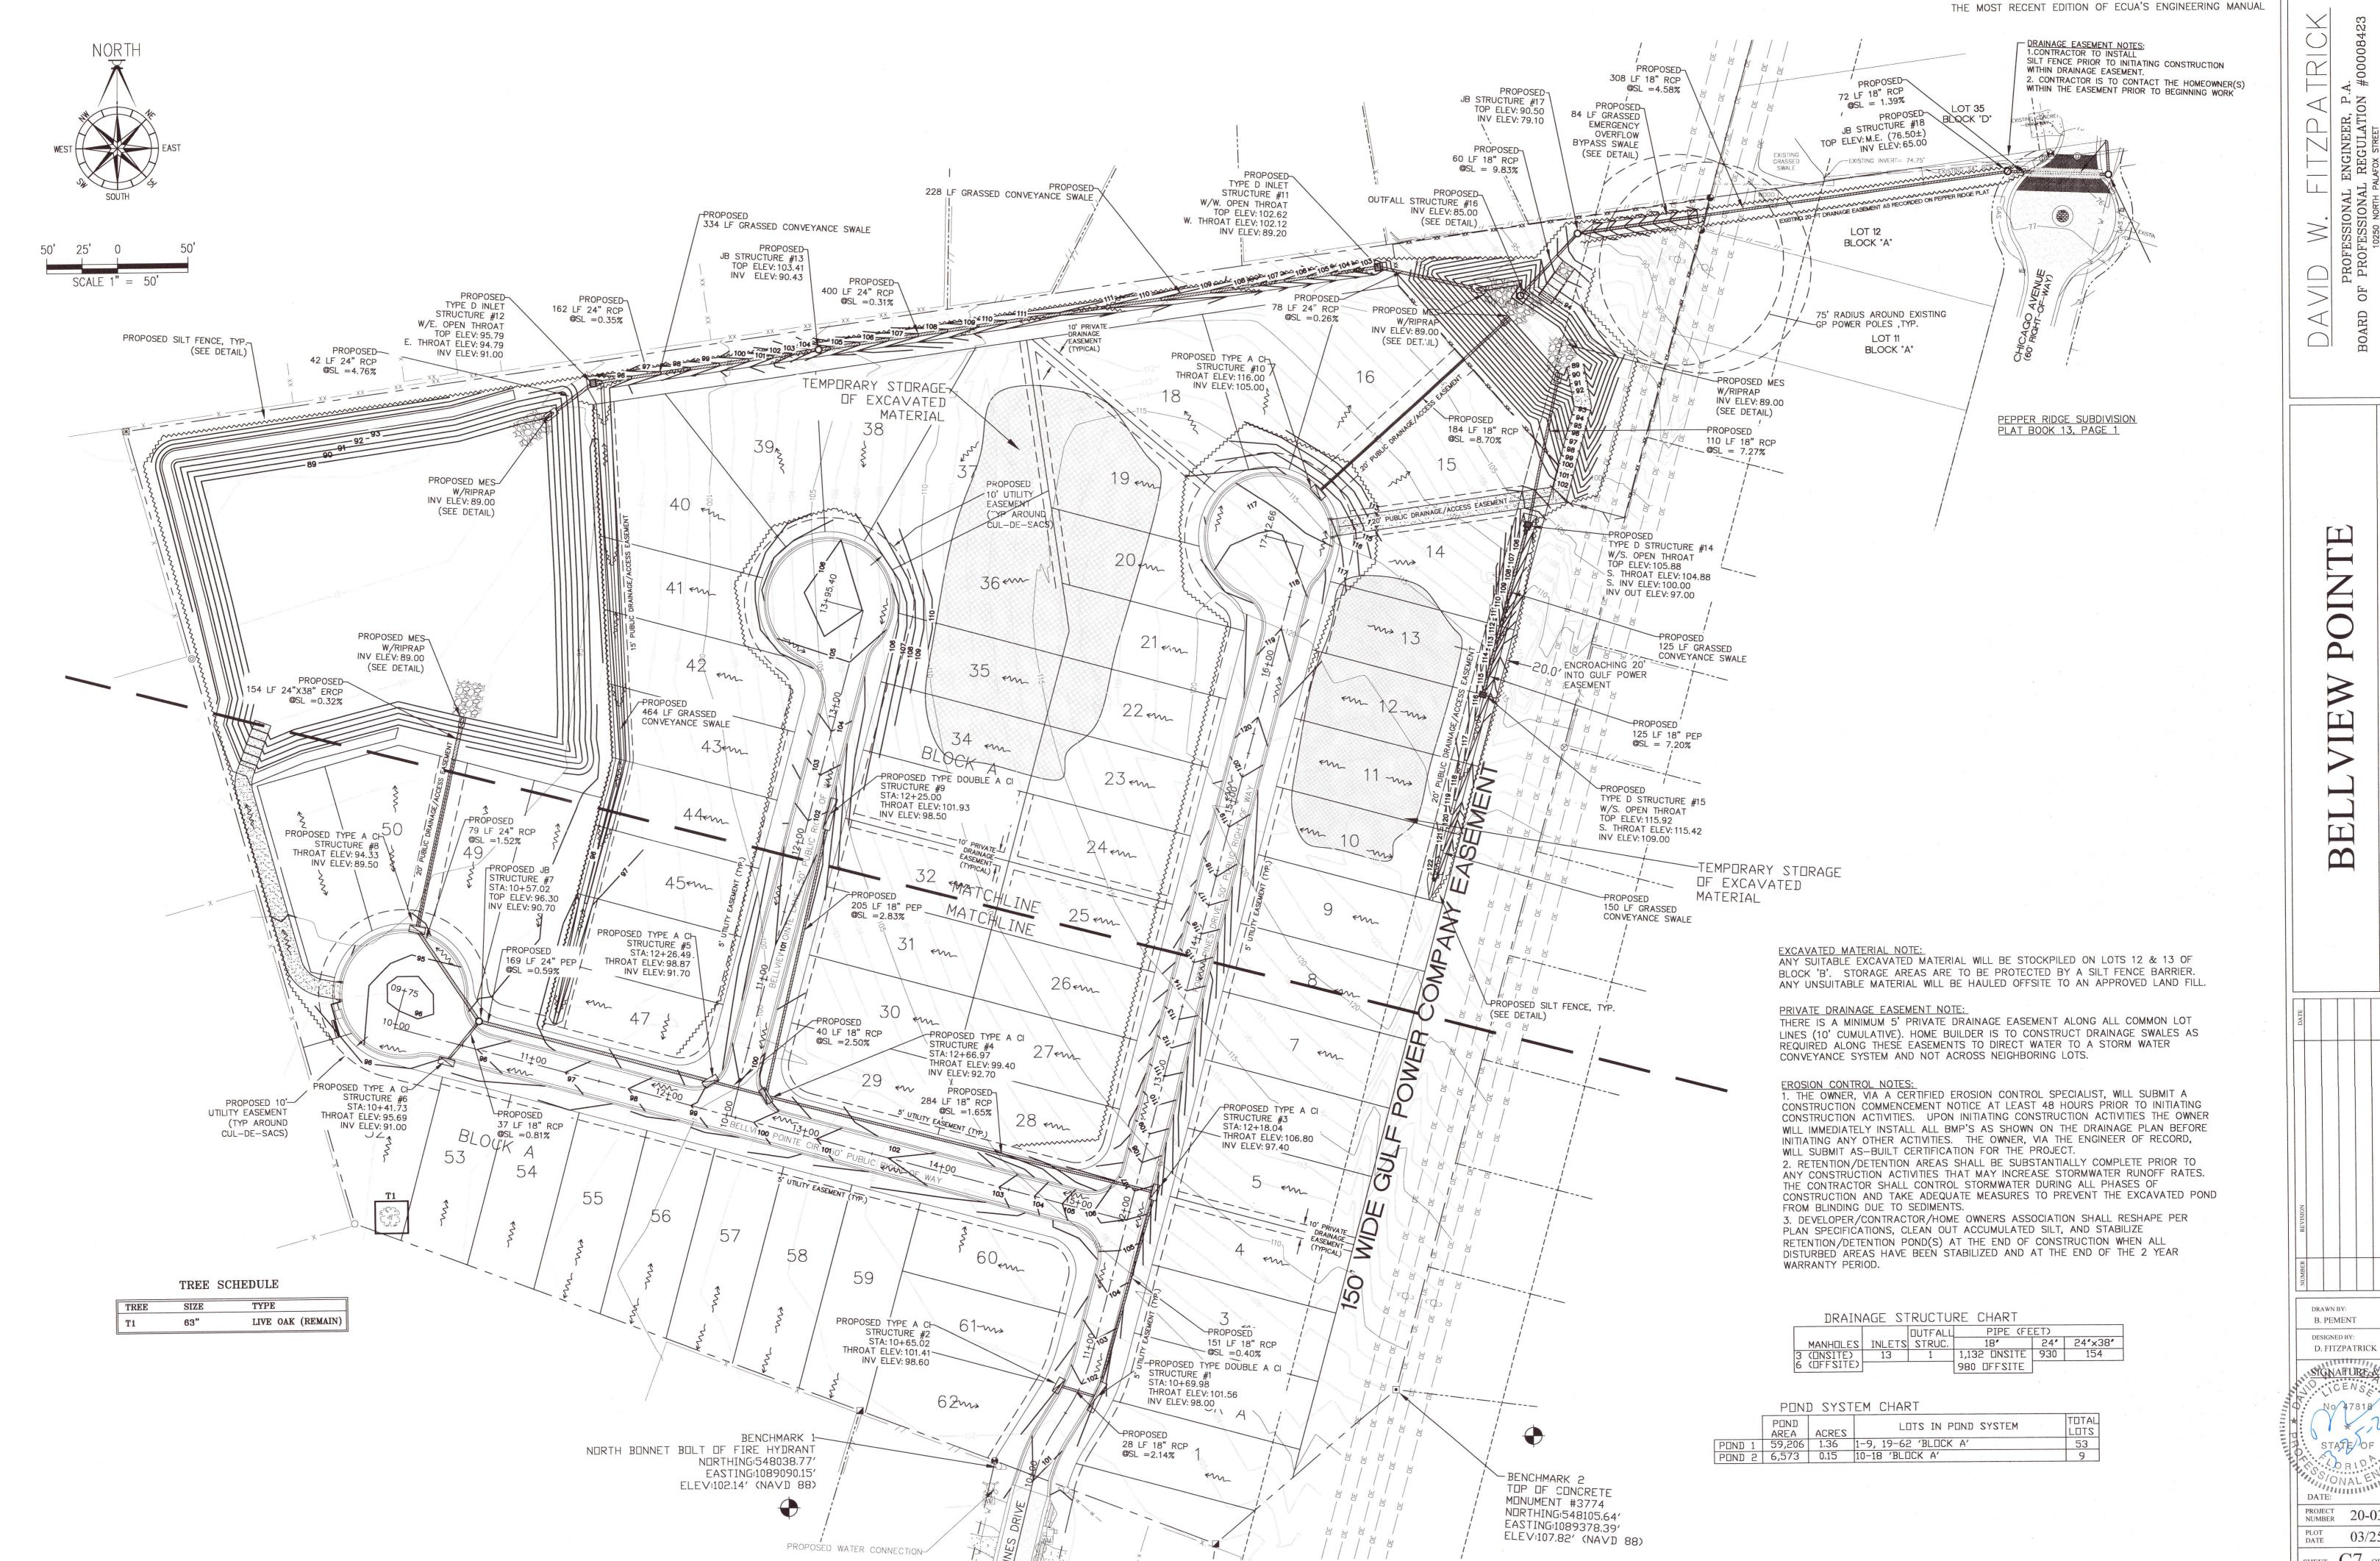
PROJECT 20-036

PLOT 03/25/22

SHEET C4 OF C28





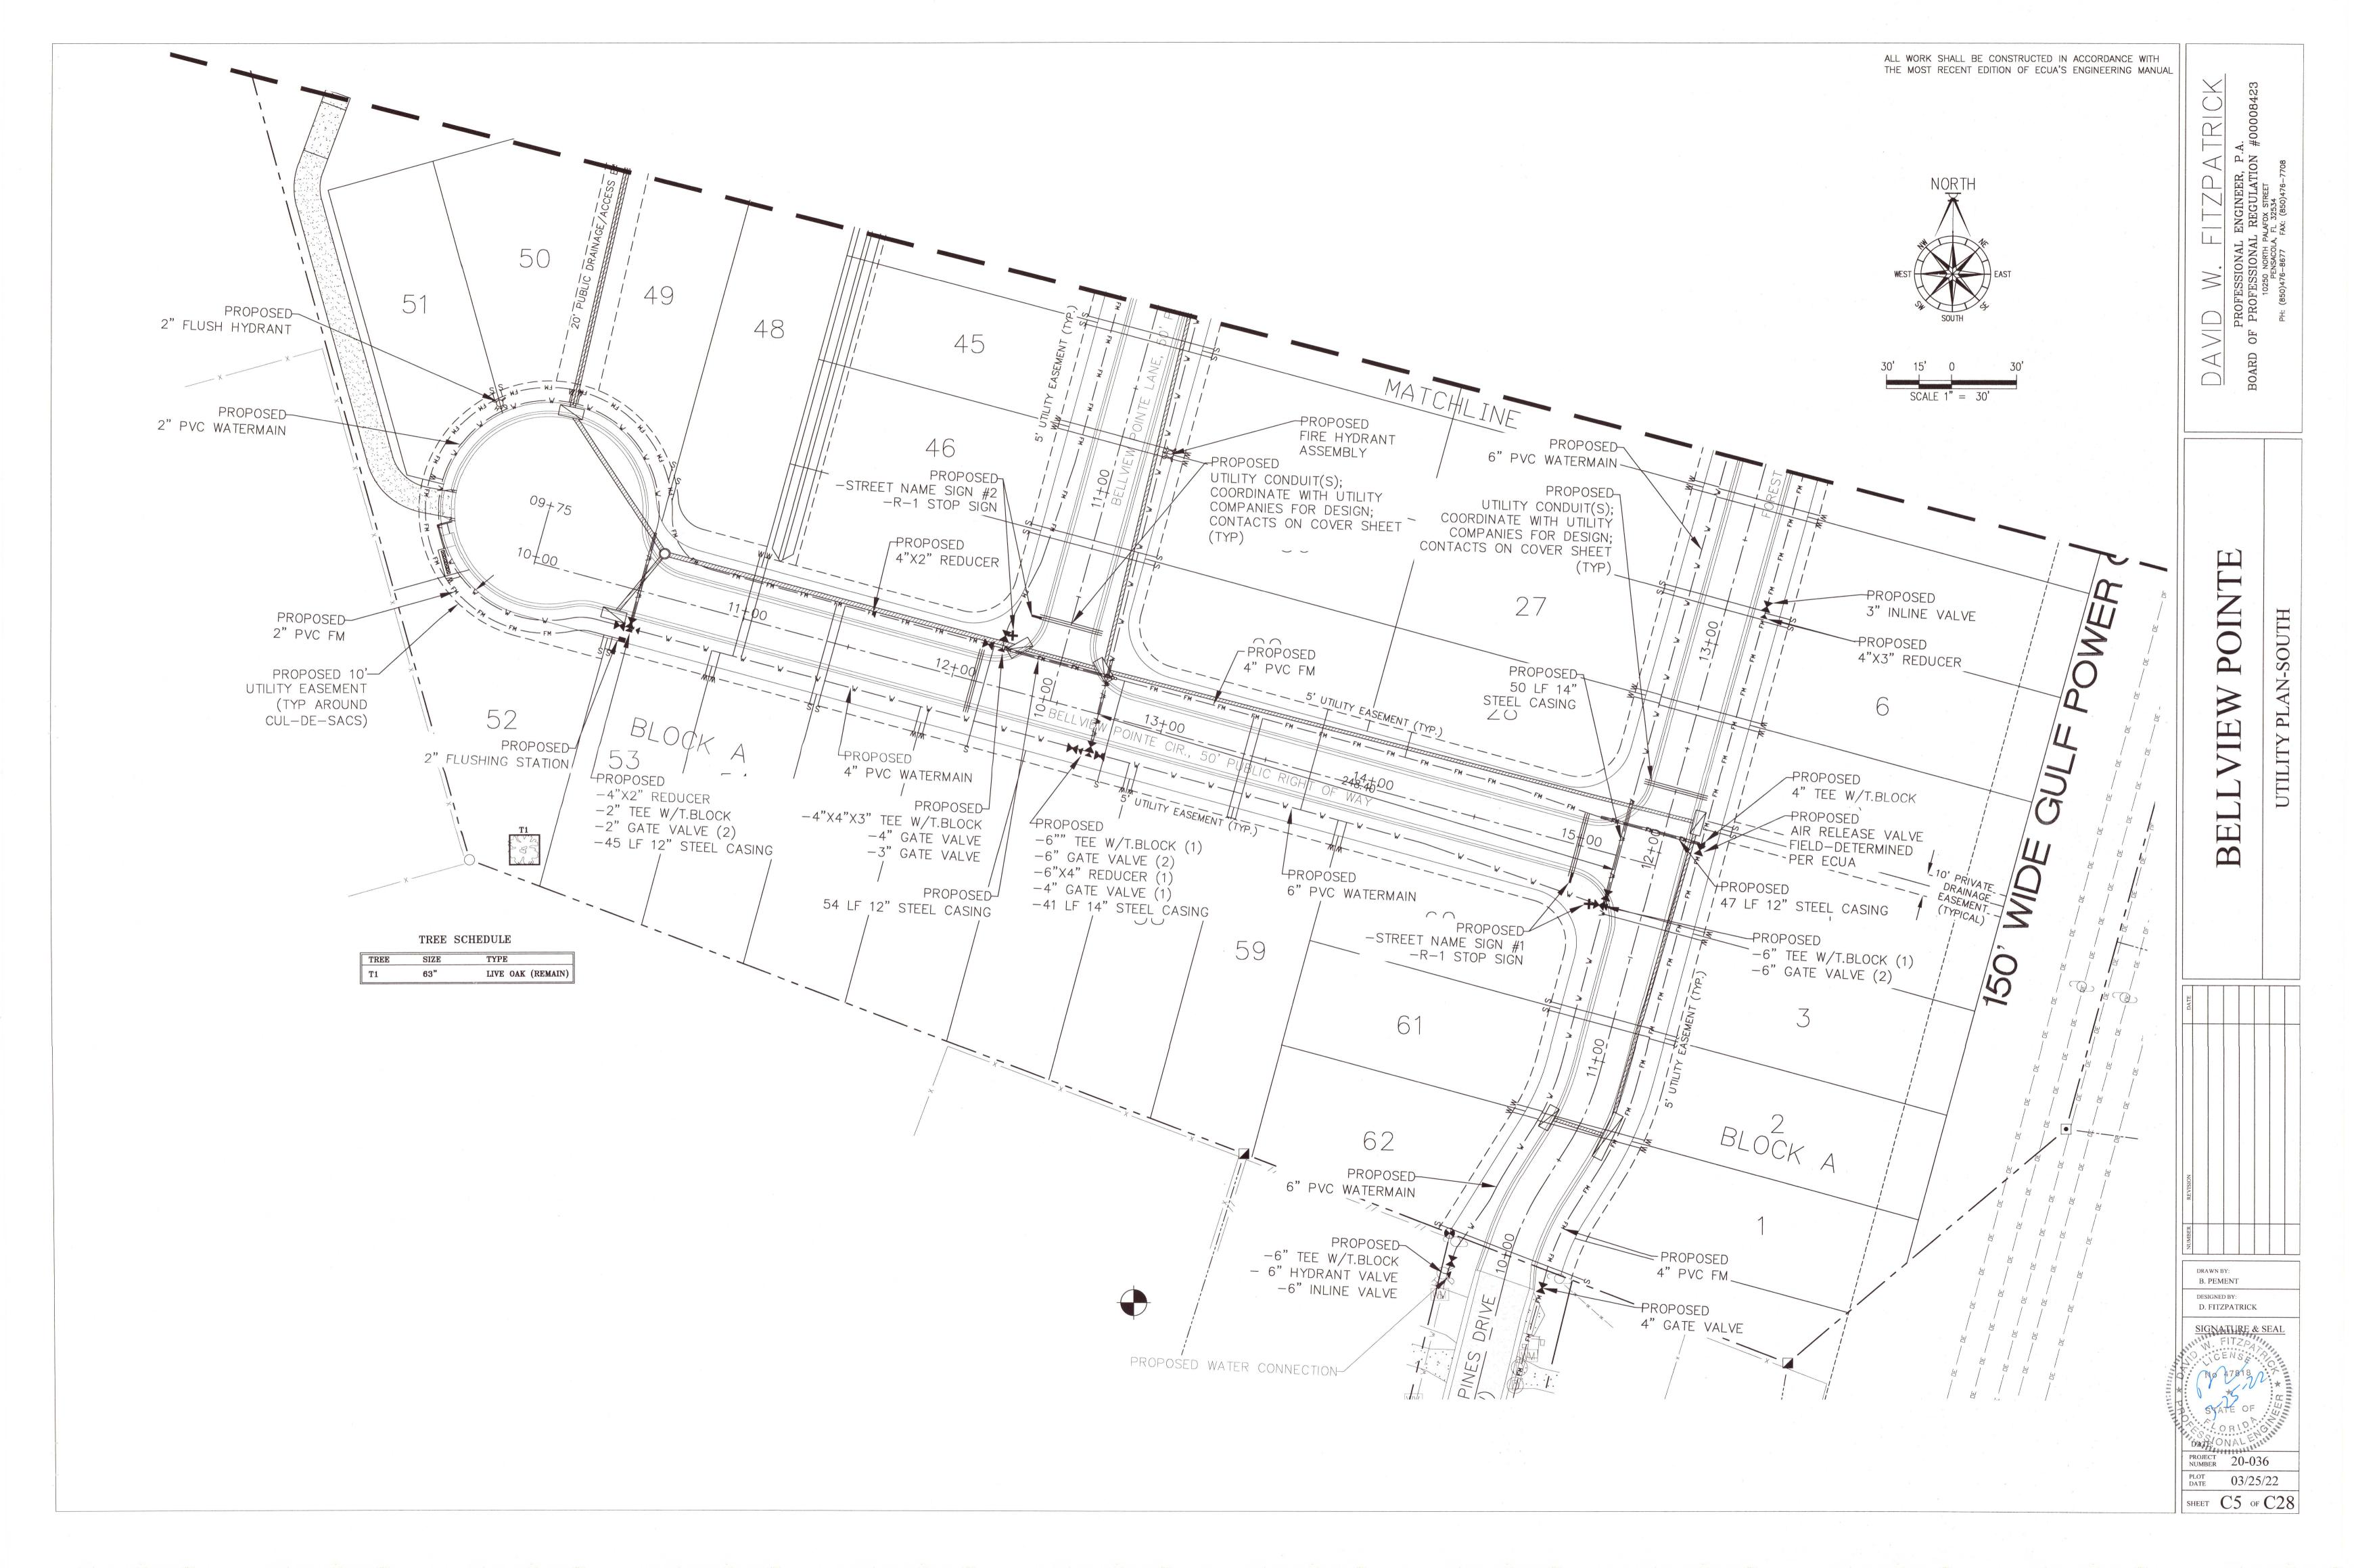


ALL WORK SHALL BE CONSTRUCTED IN ACCORDANCE WITH

D. FITZPATRICK SIGNAFURE & SEAI

PROJECT 20-036


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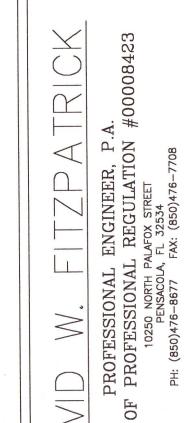


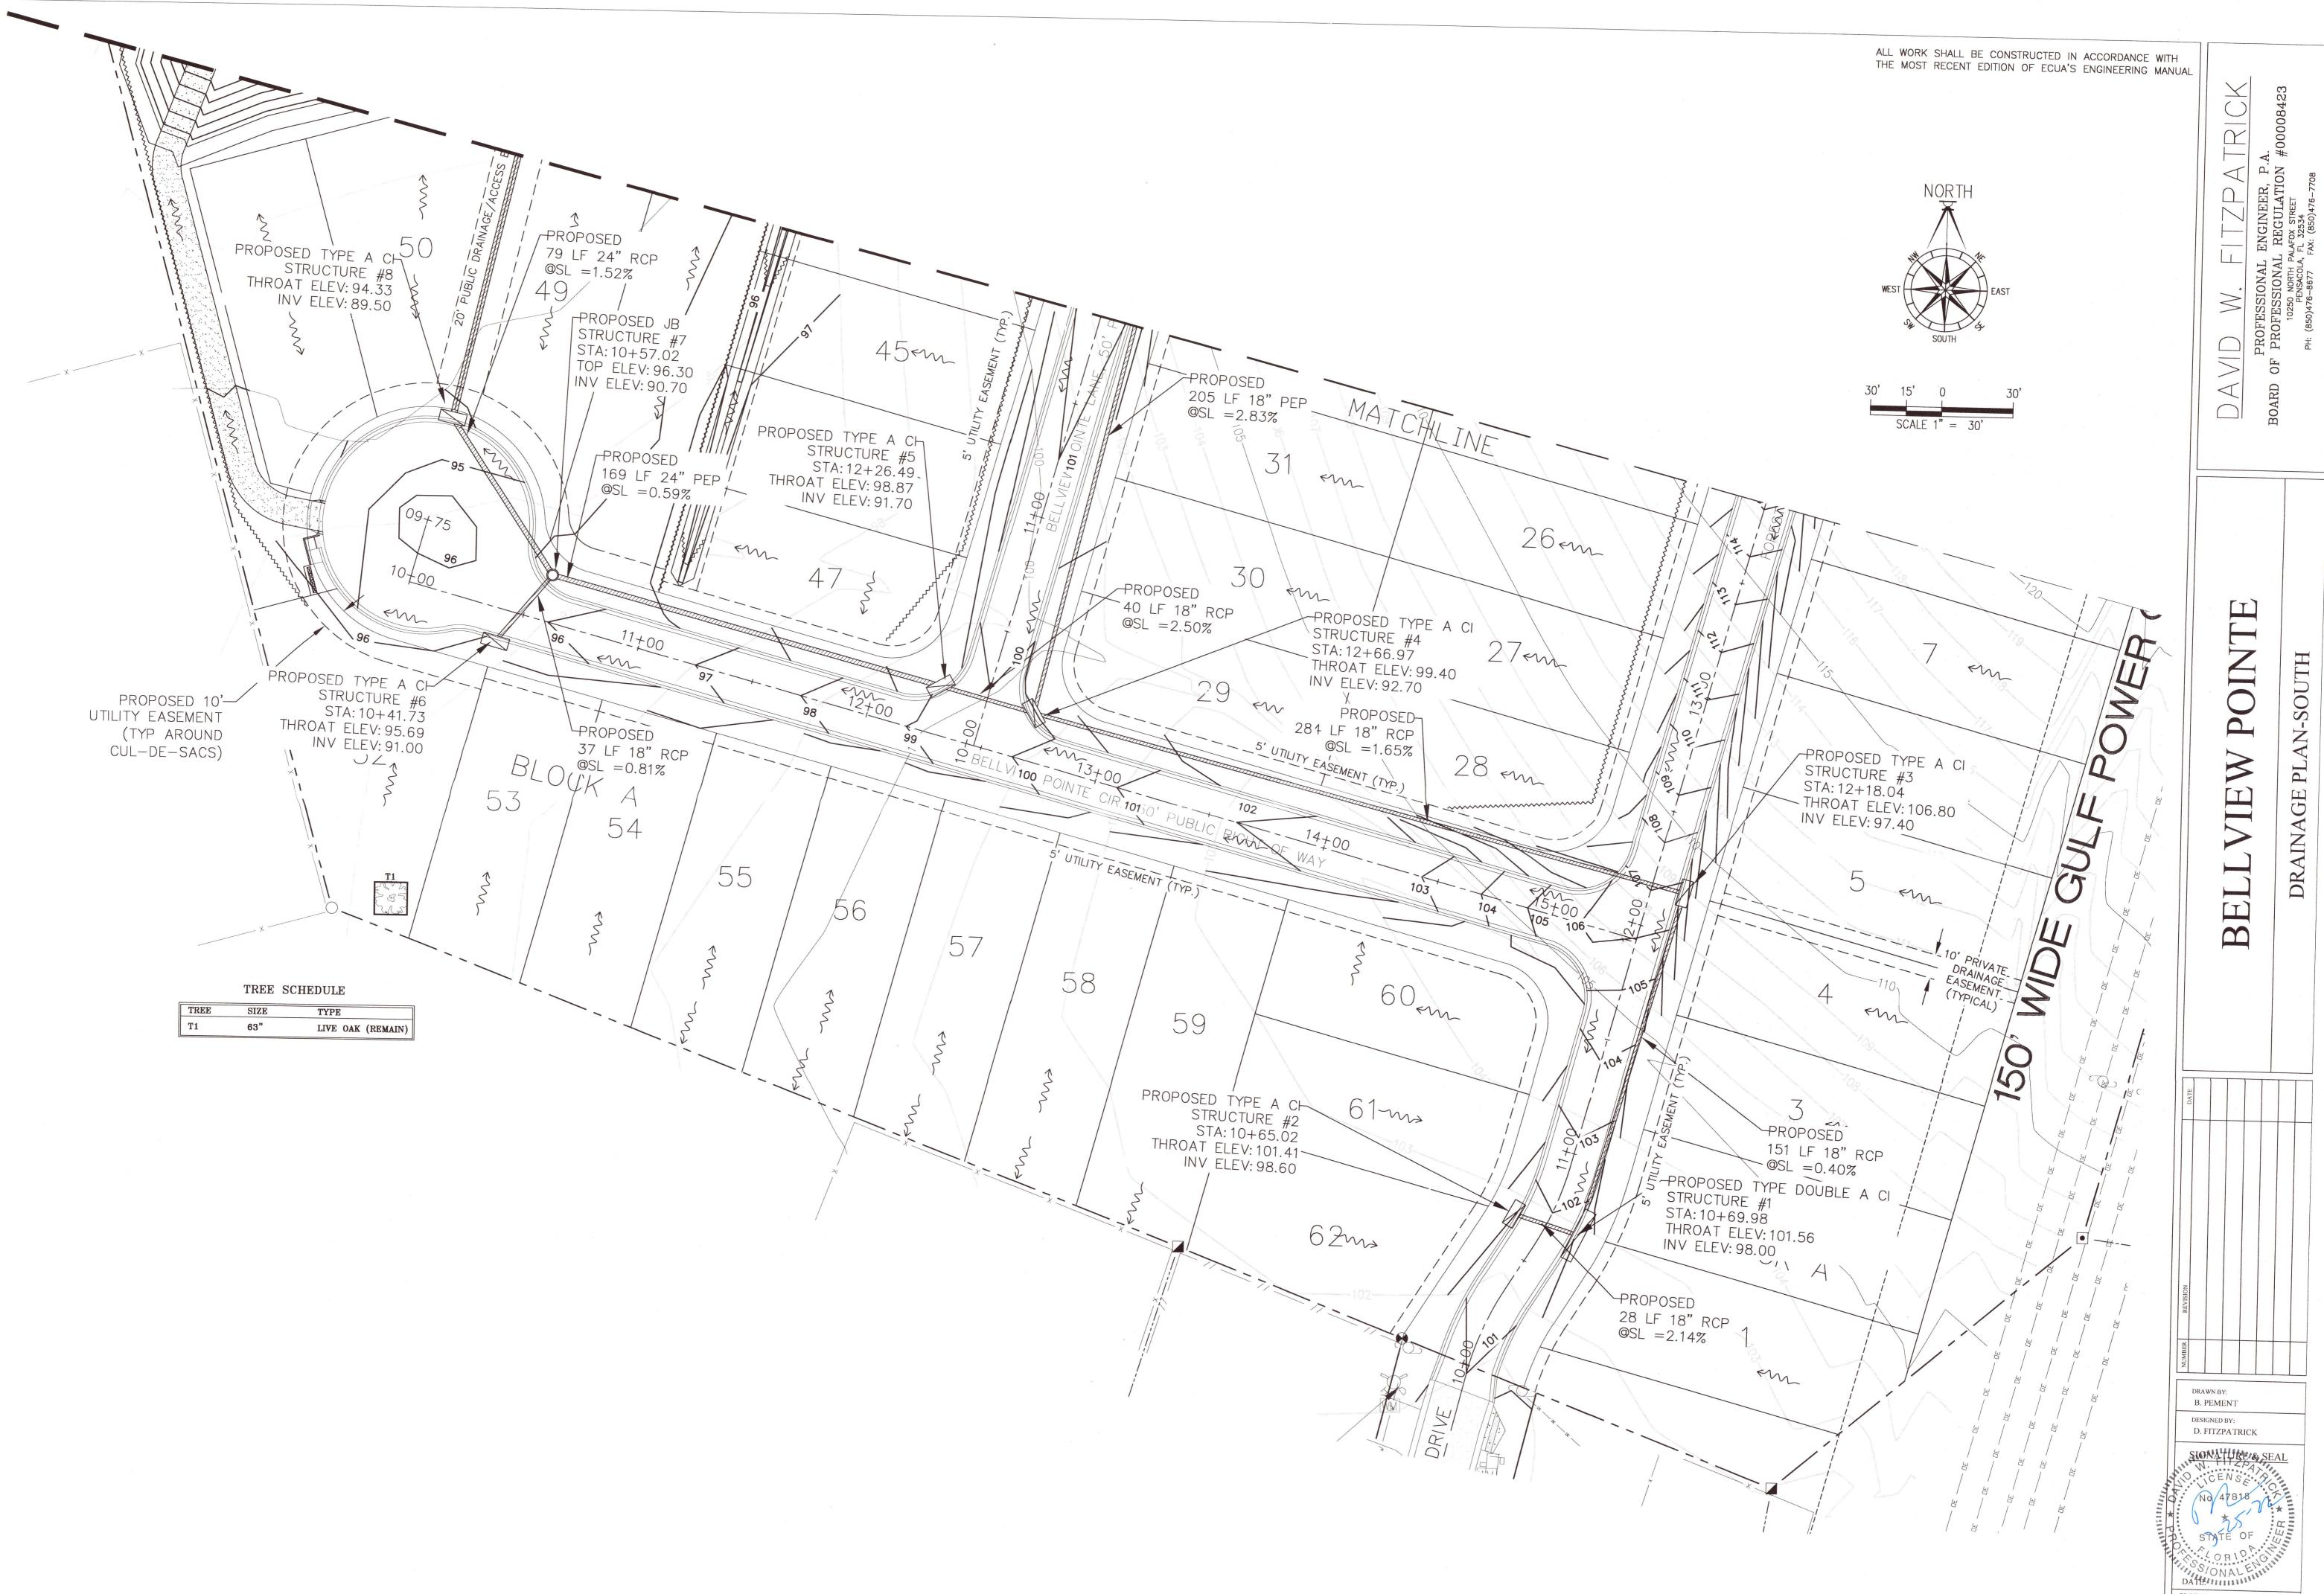PROJECT NUMBER 20-036

PLOT DATE 03/25/22

SHEET C8 OF C28



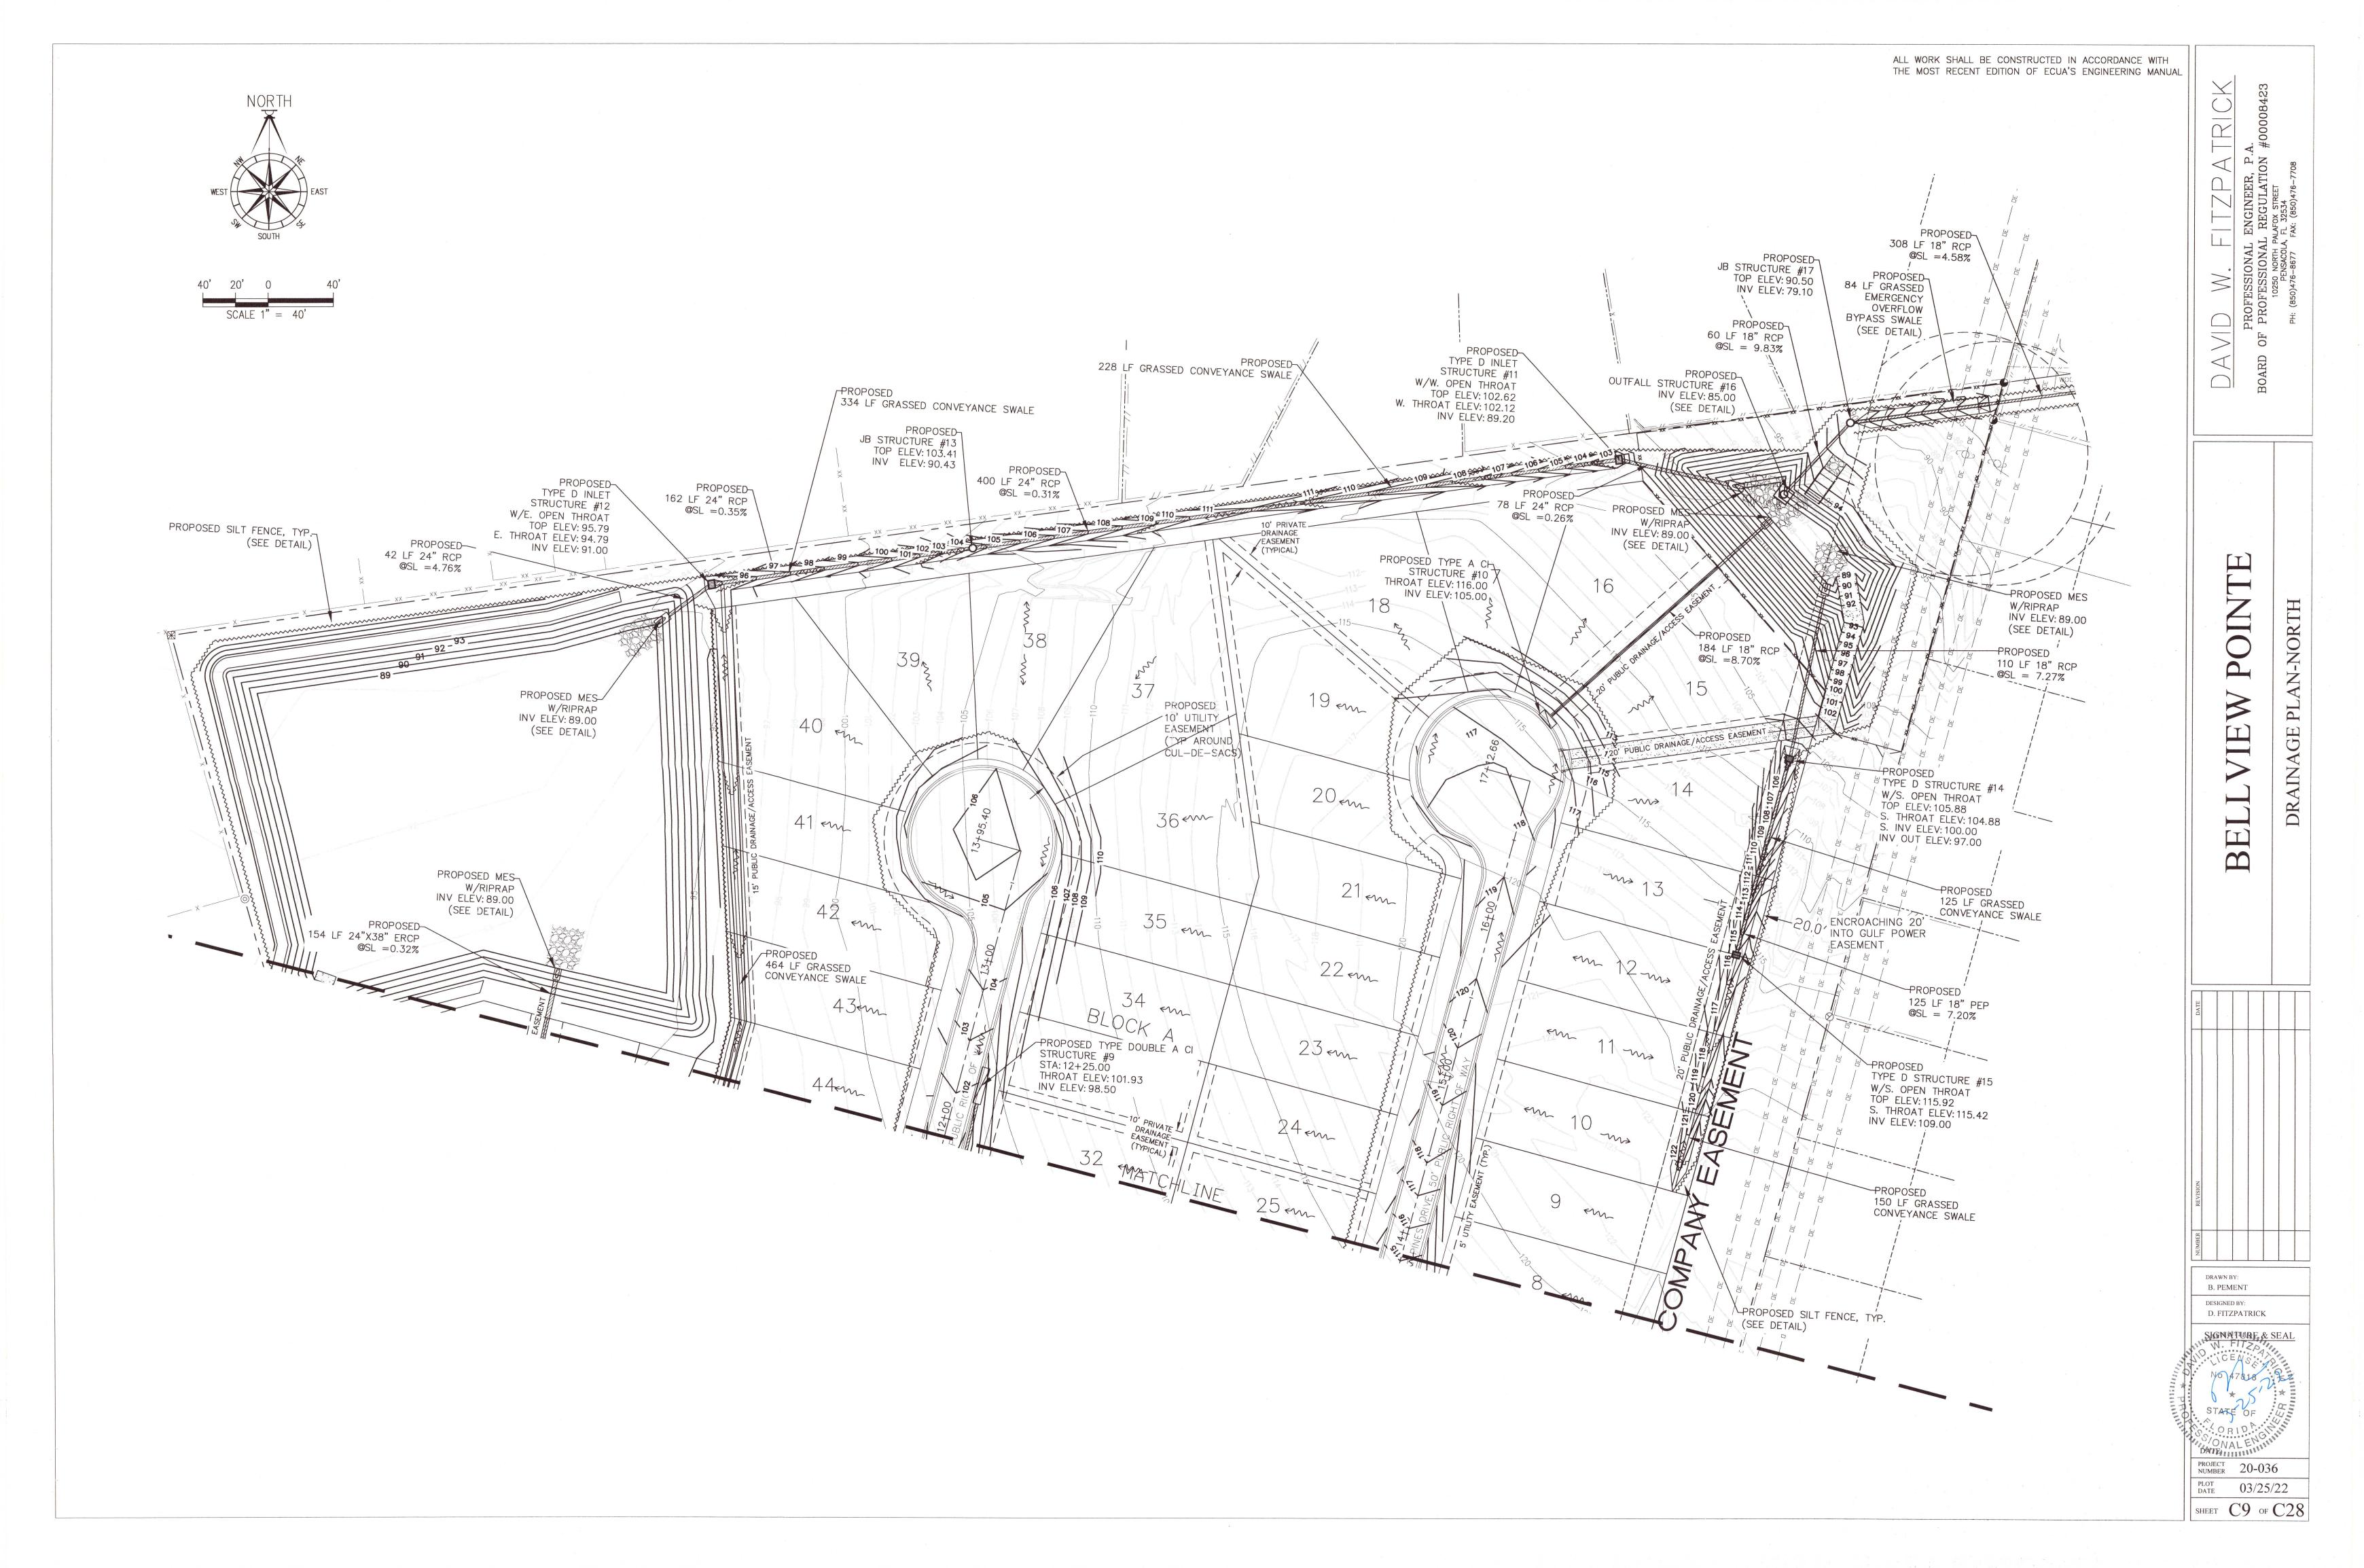



FOREST PINES PLAN/PROFILE


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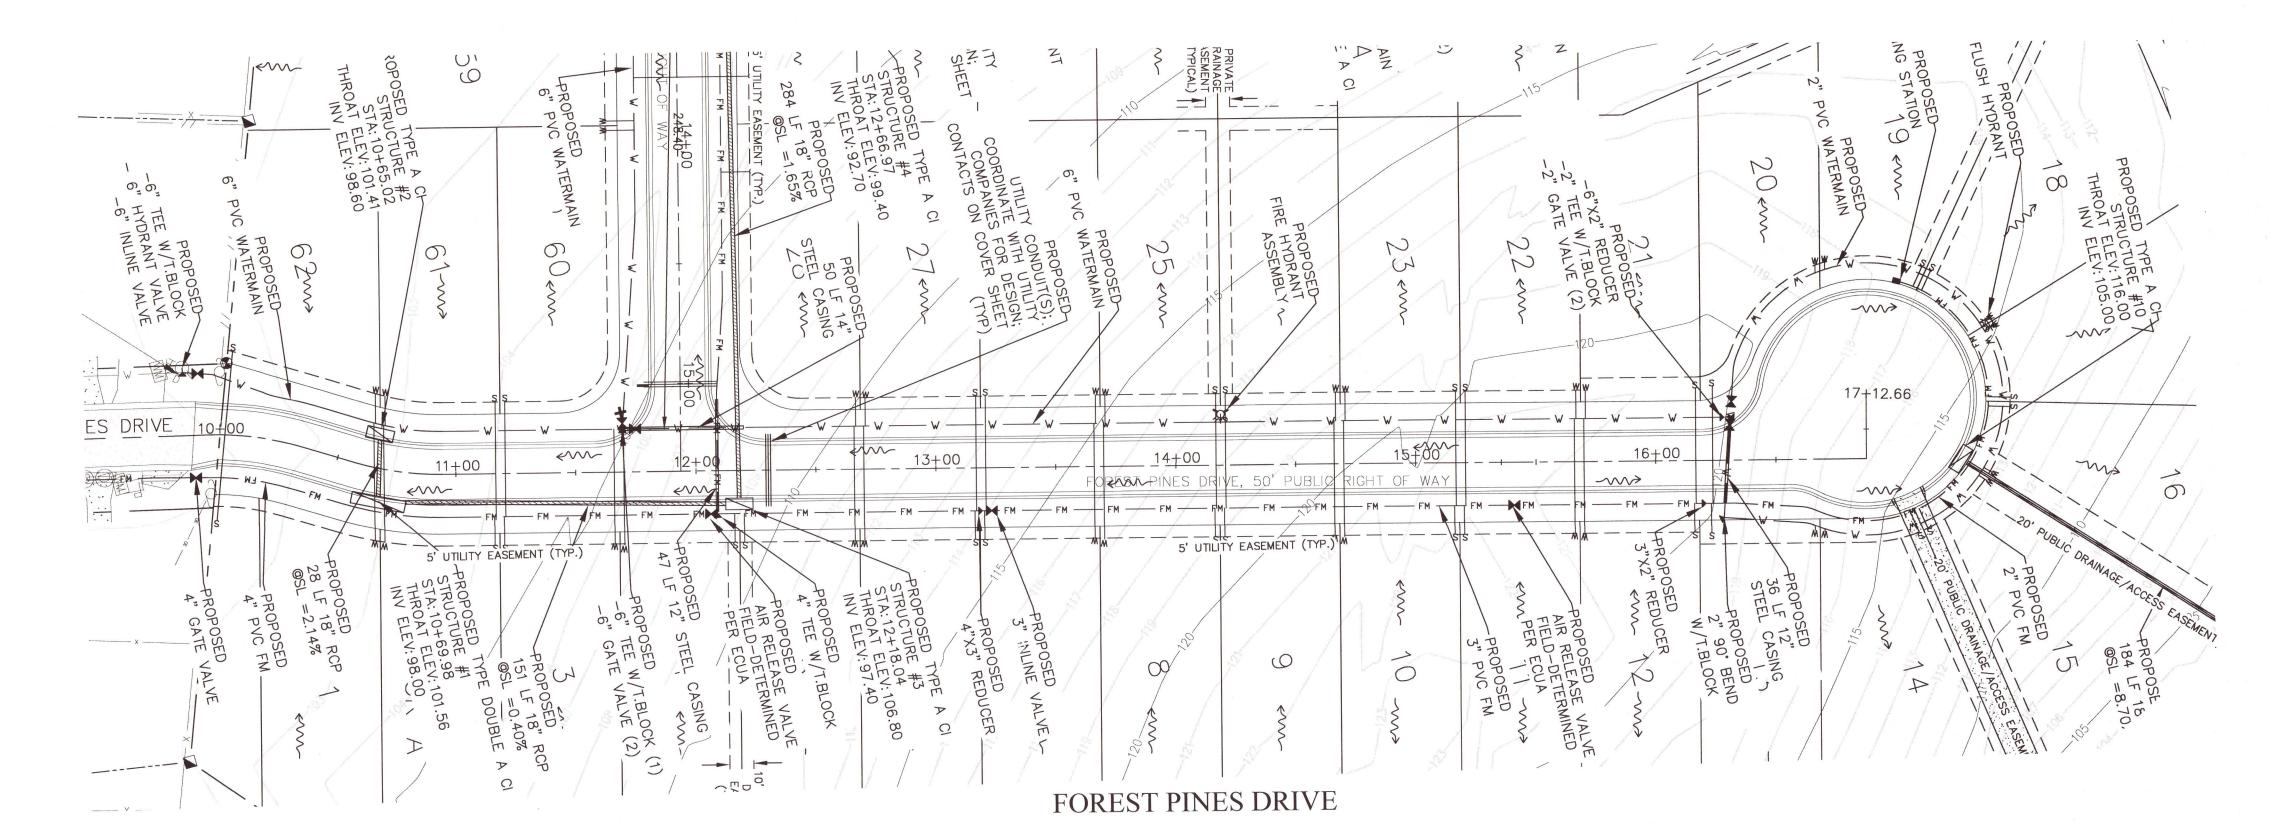
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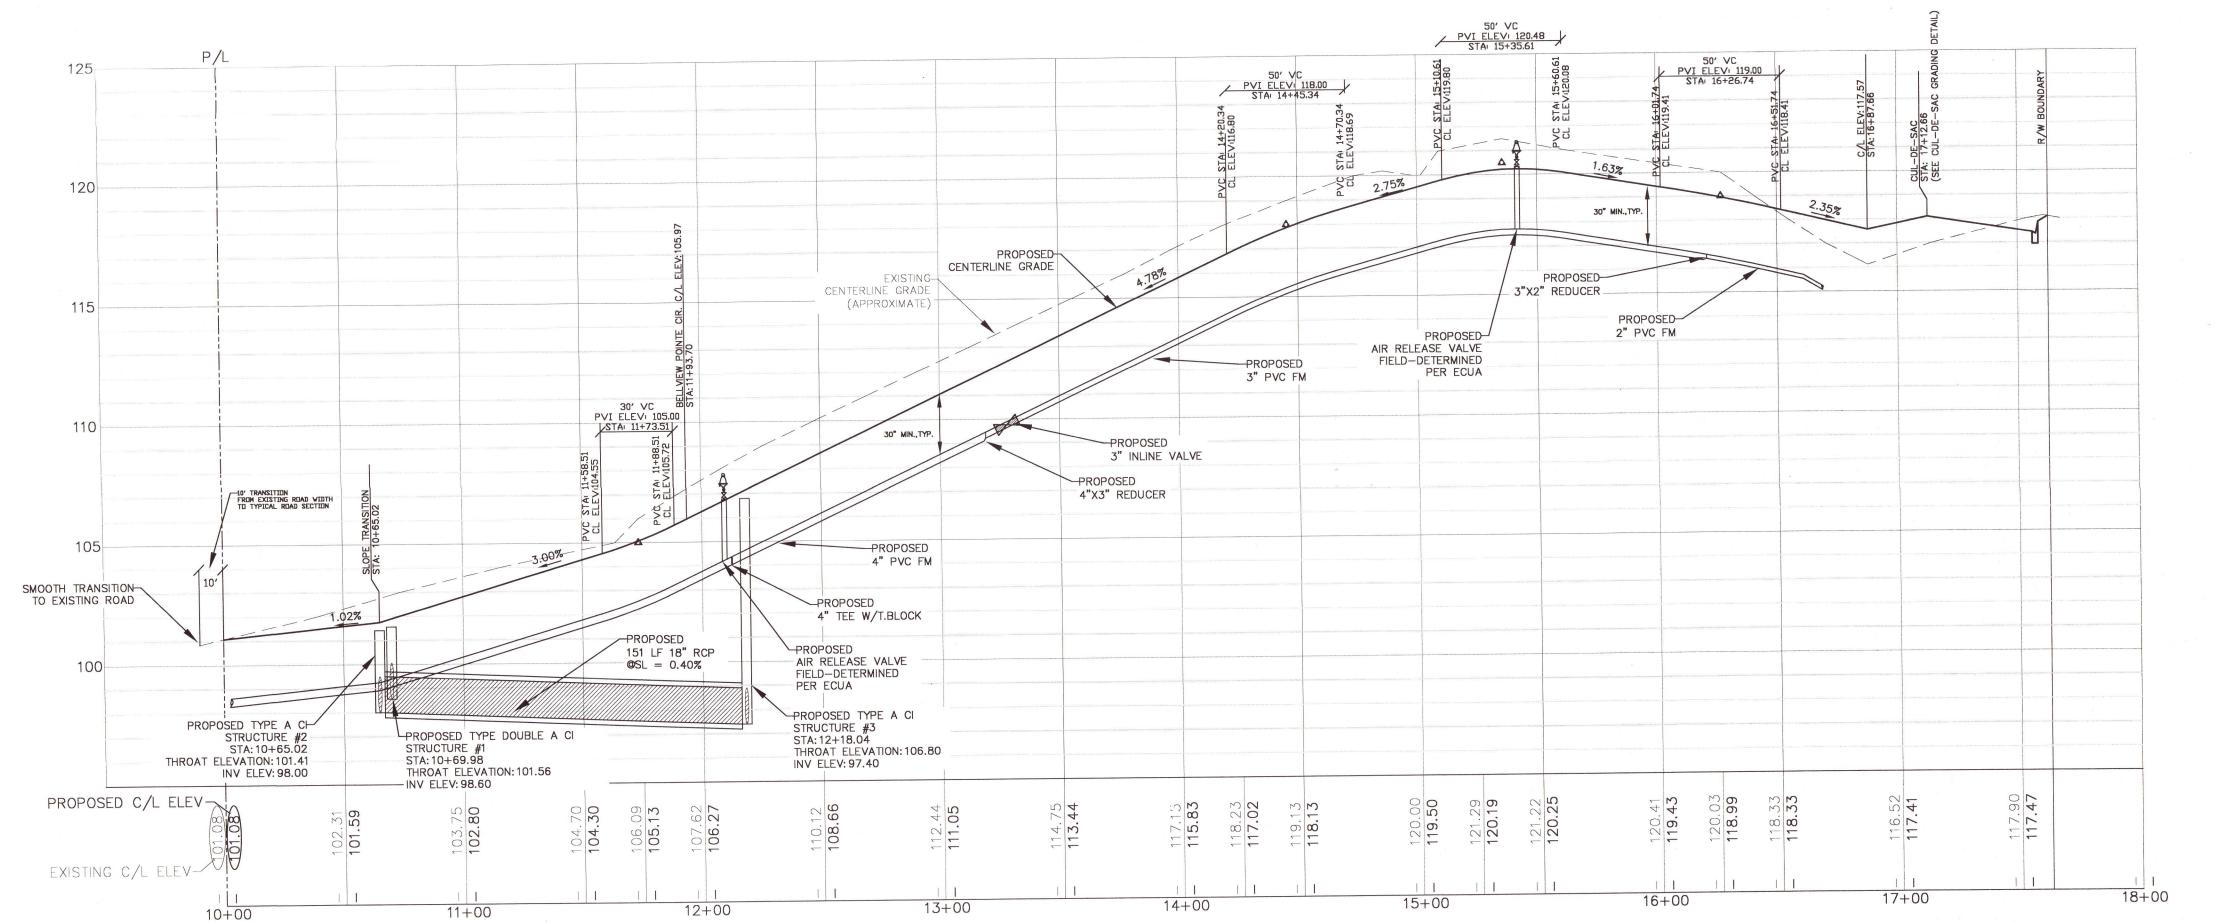




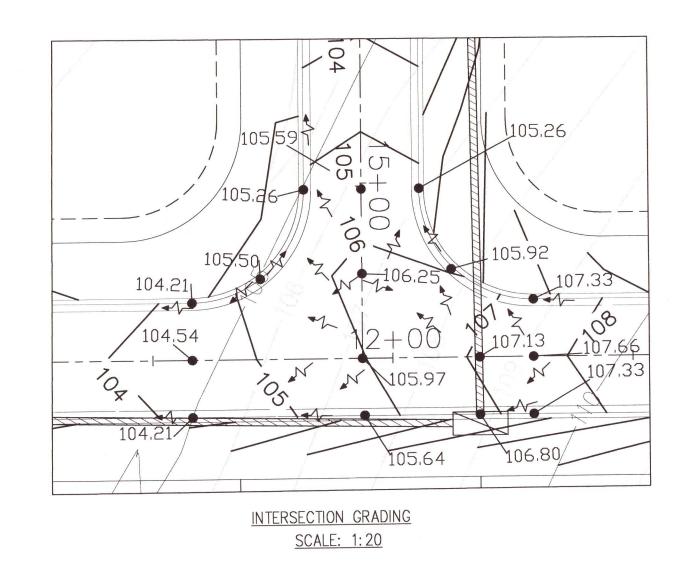

PROFILE LOCATION

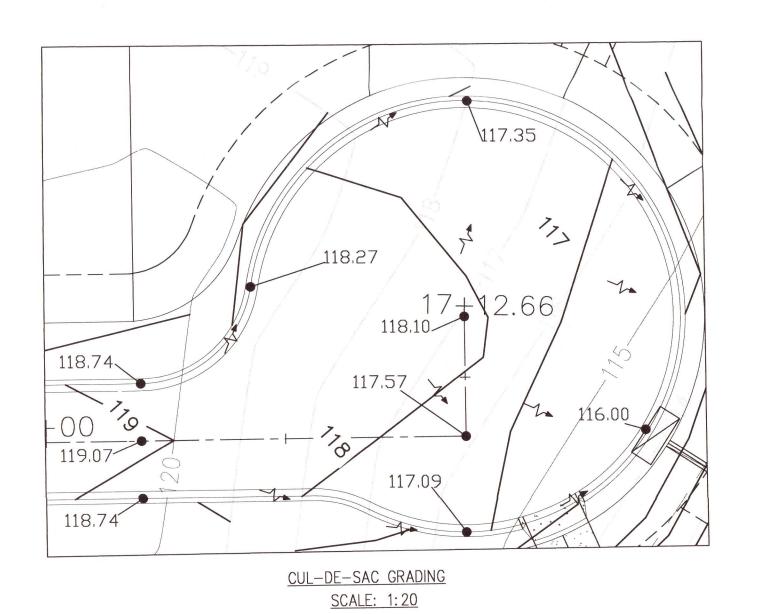

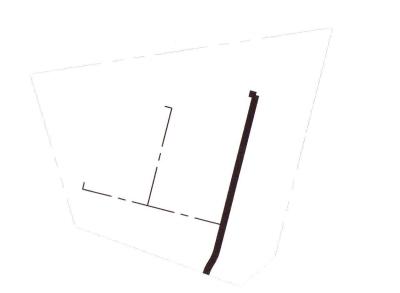

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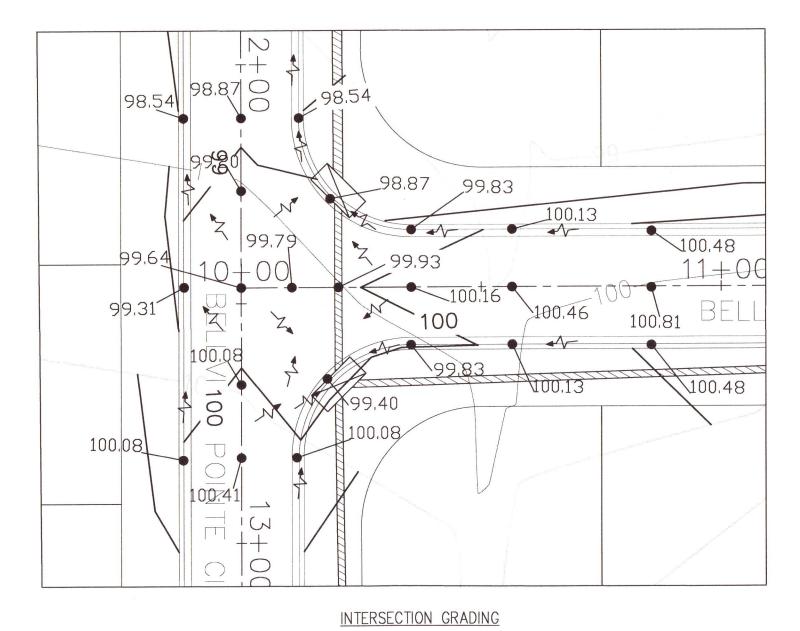
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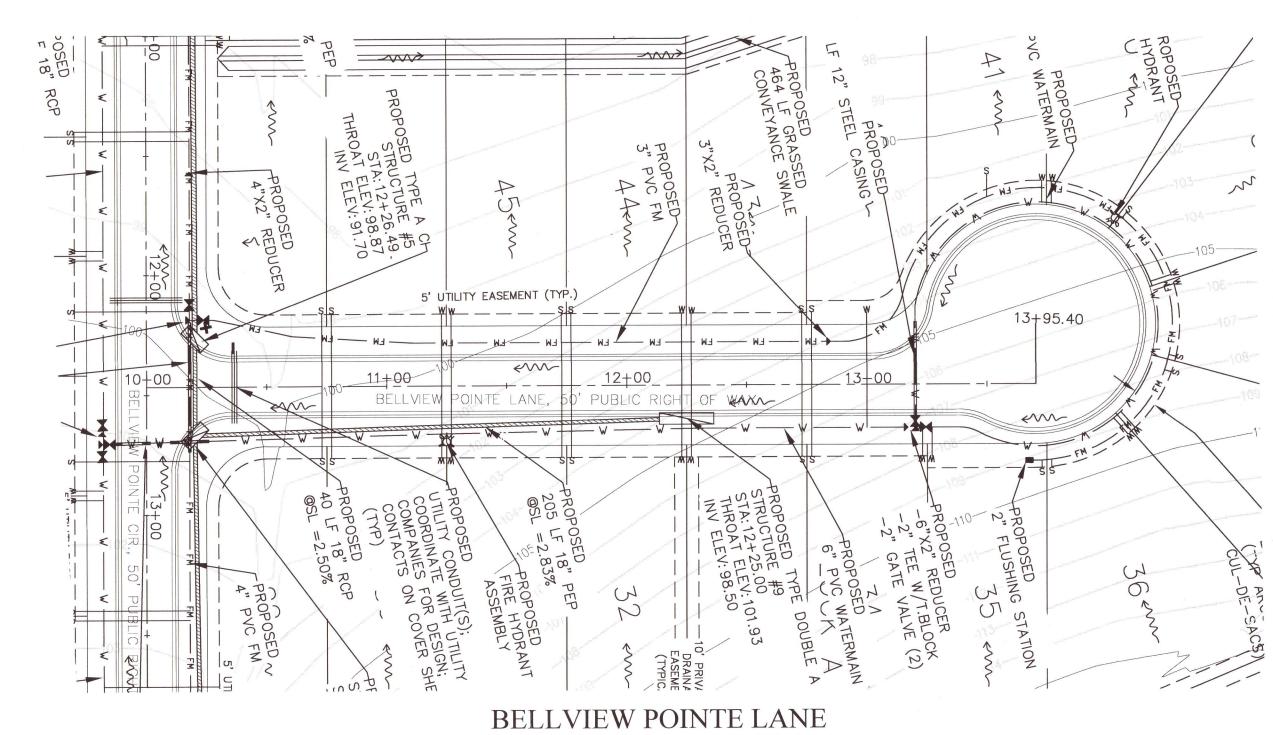
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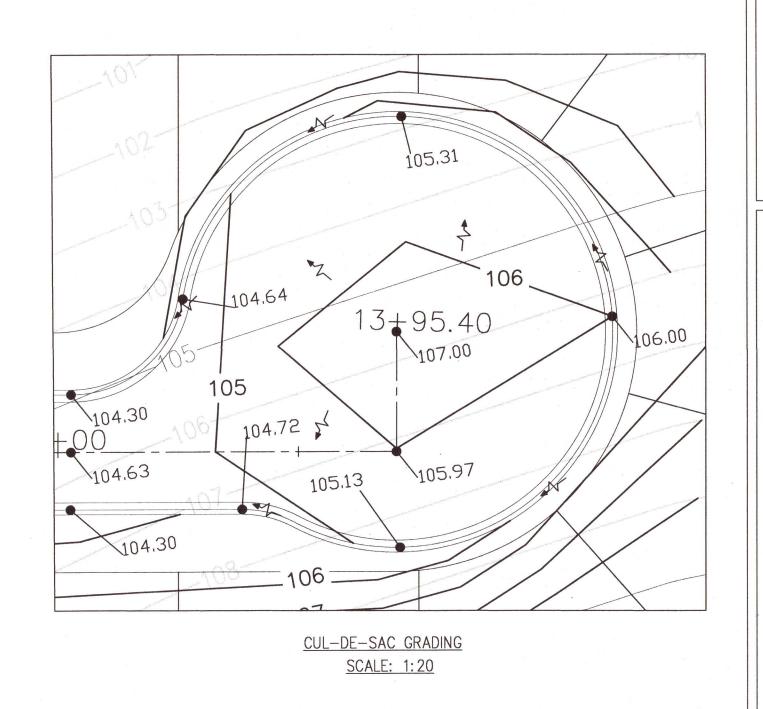
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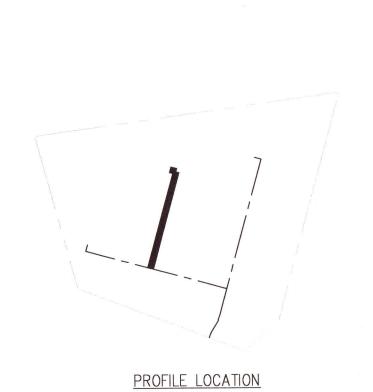
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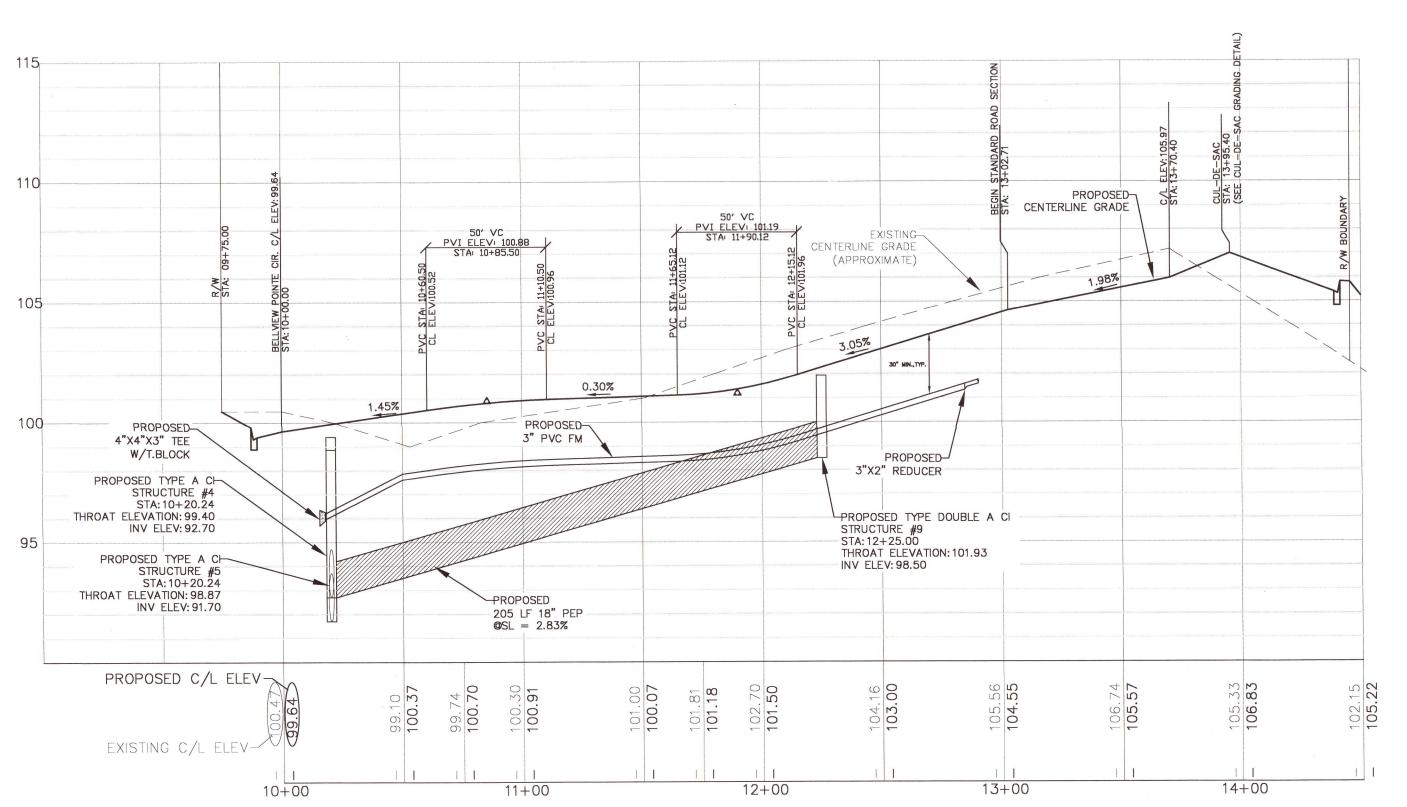



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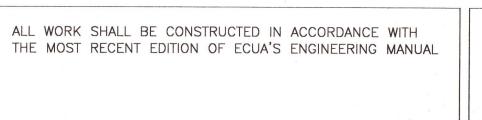
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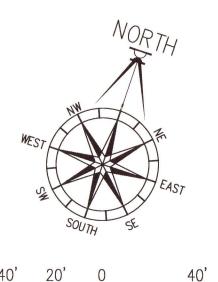
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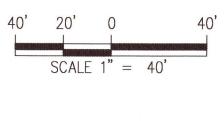
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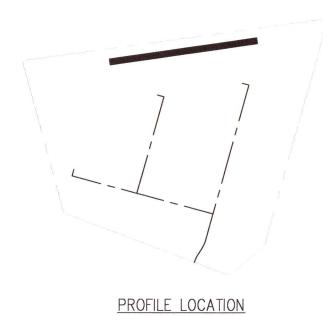
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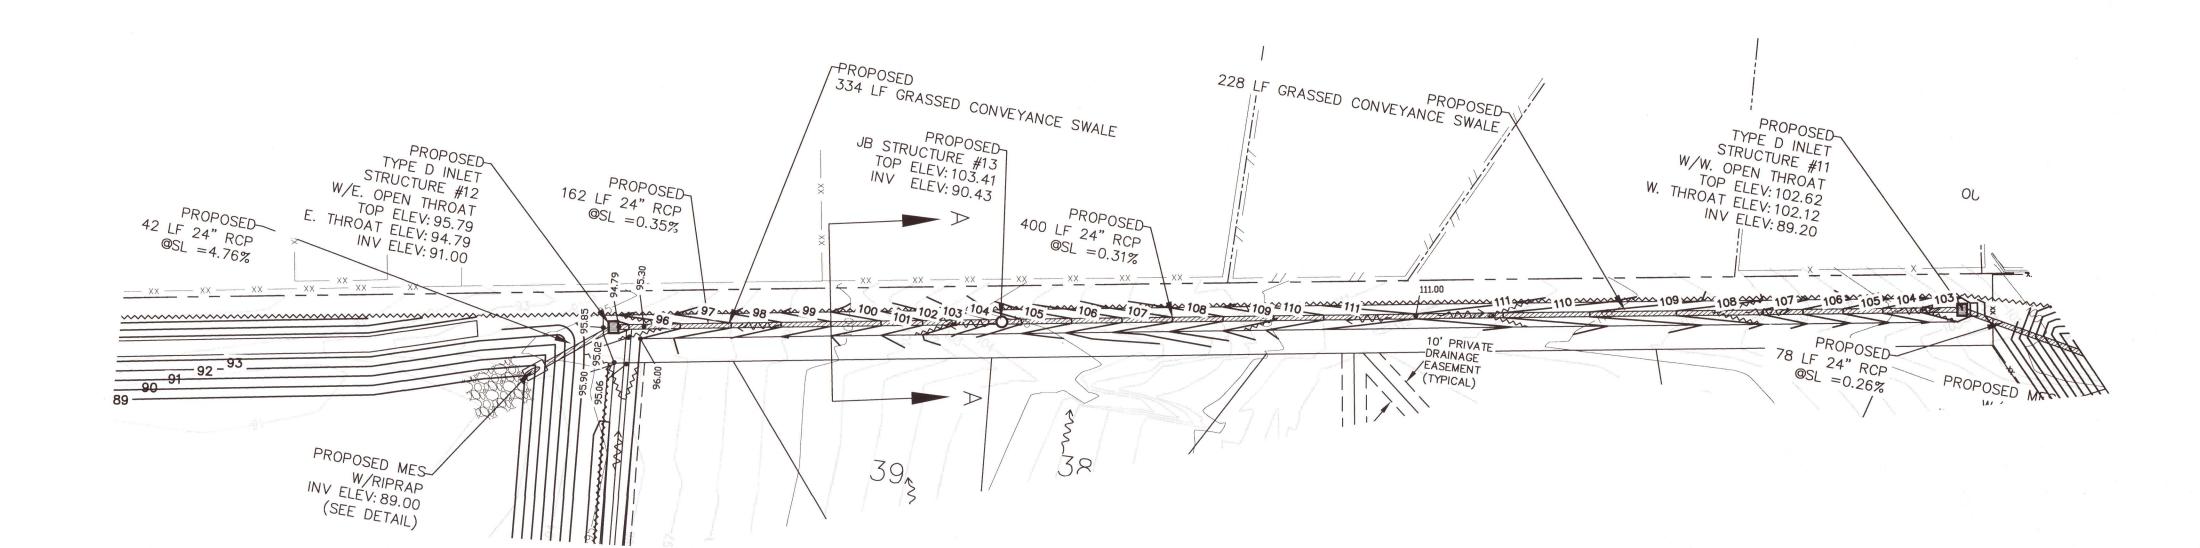
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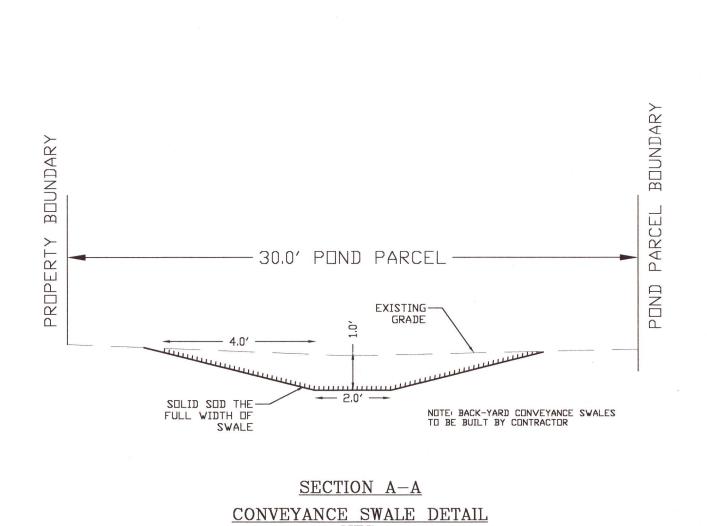











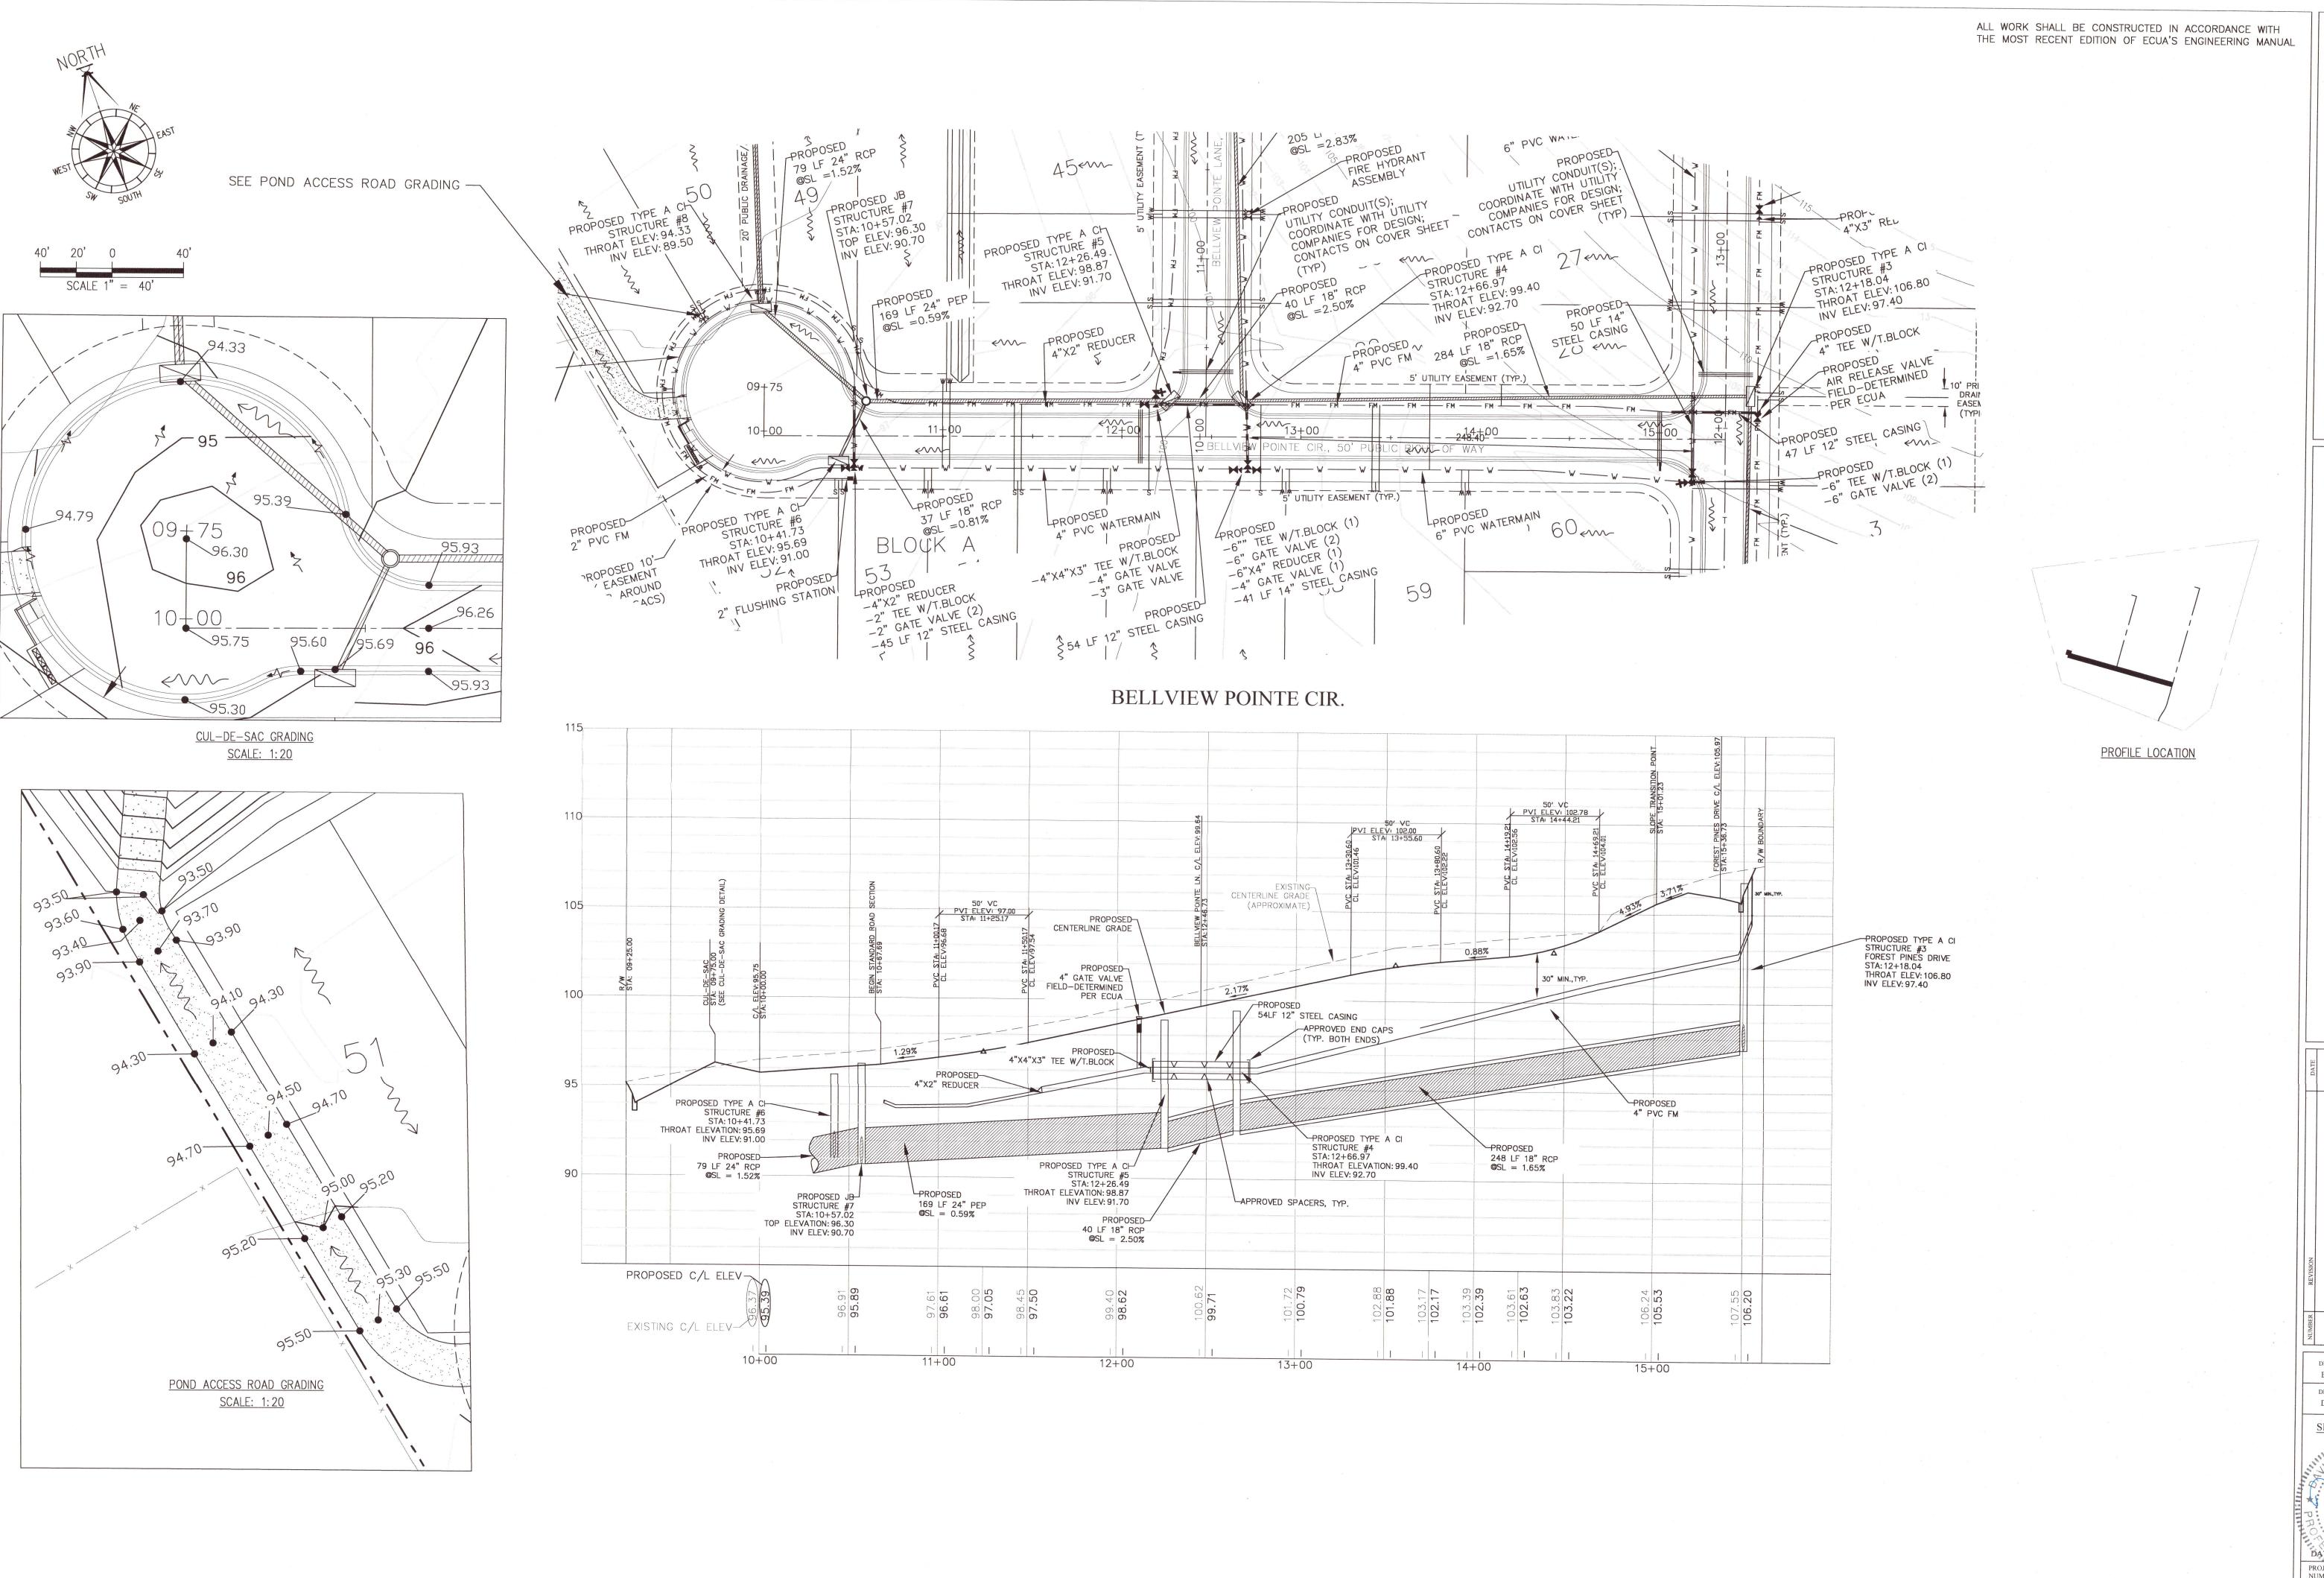

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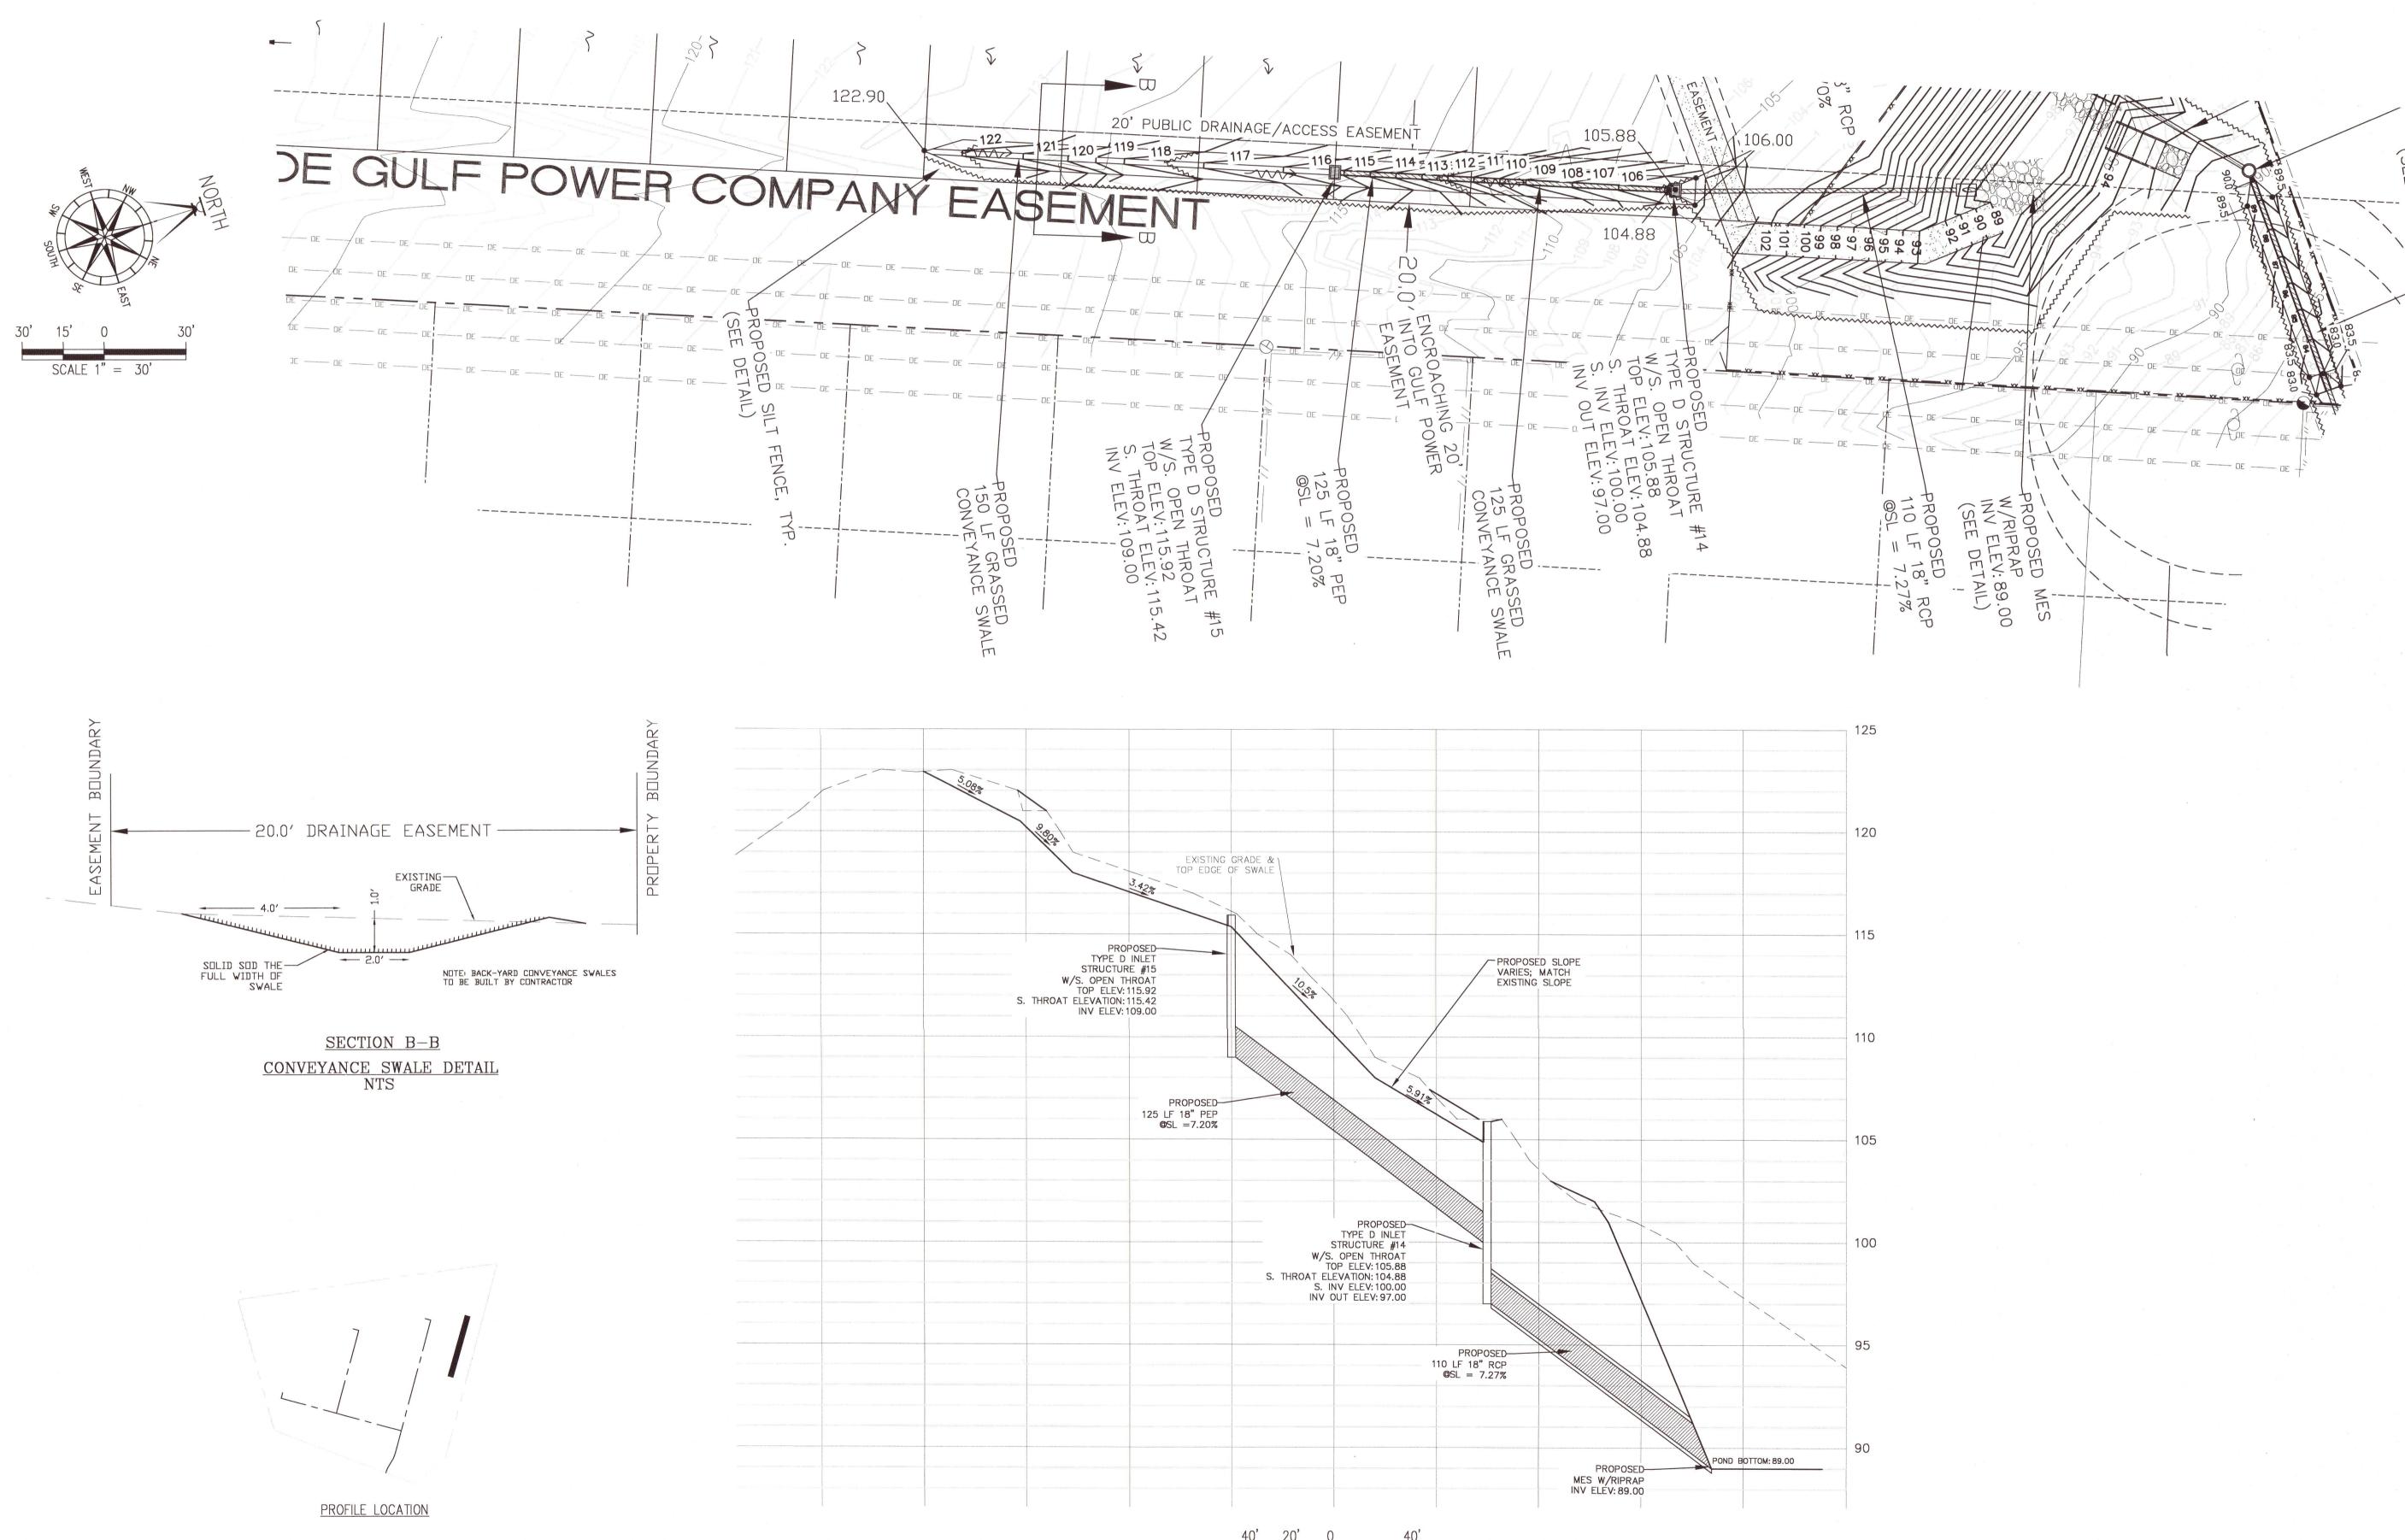
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PROJECT 20-036

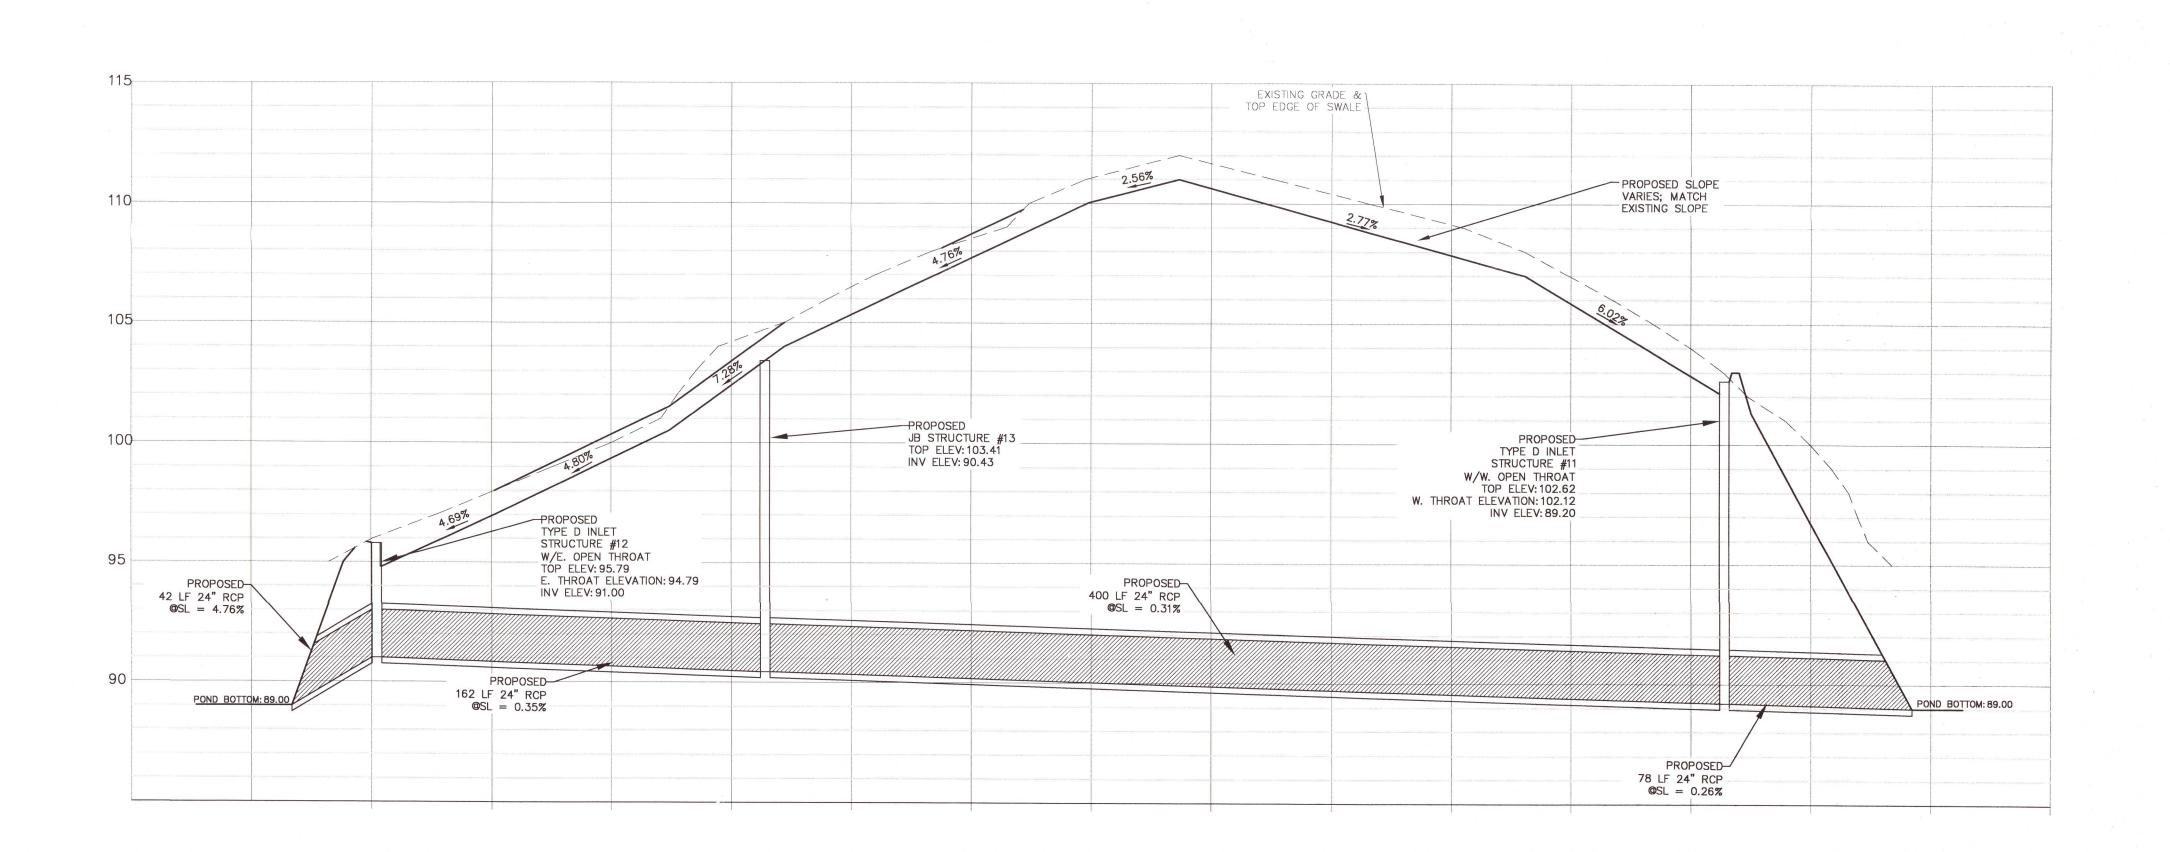PLOT 03/25/22 SHEET C13 OF C28




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D. FITZPATRICK

PROJECT 20-036

03/25/22 sнеет C14 ог C28



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D. FITZPATRICK

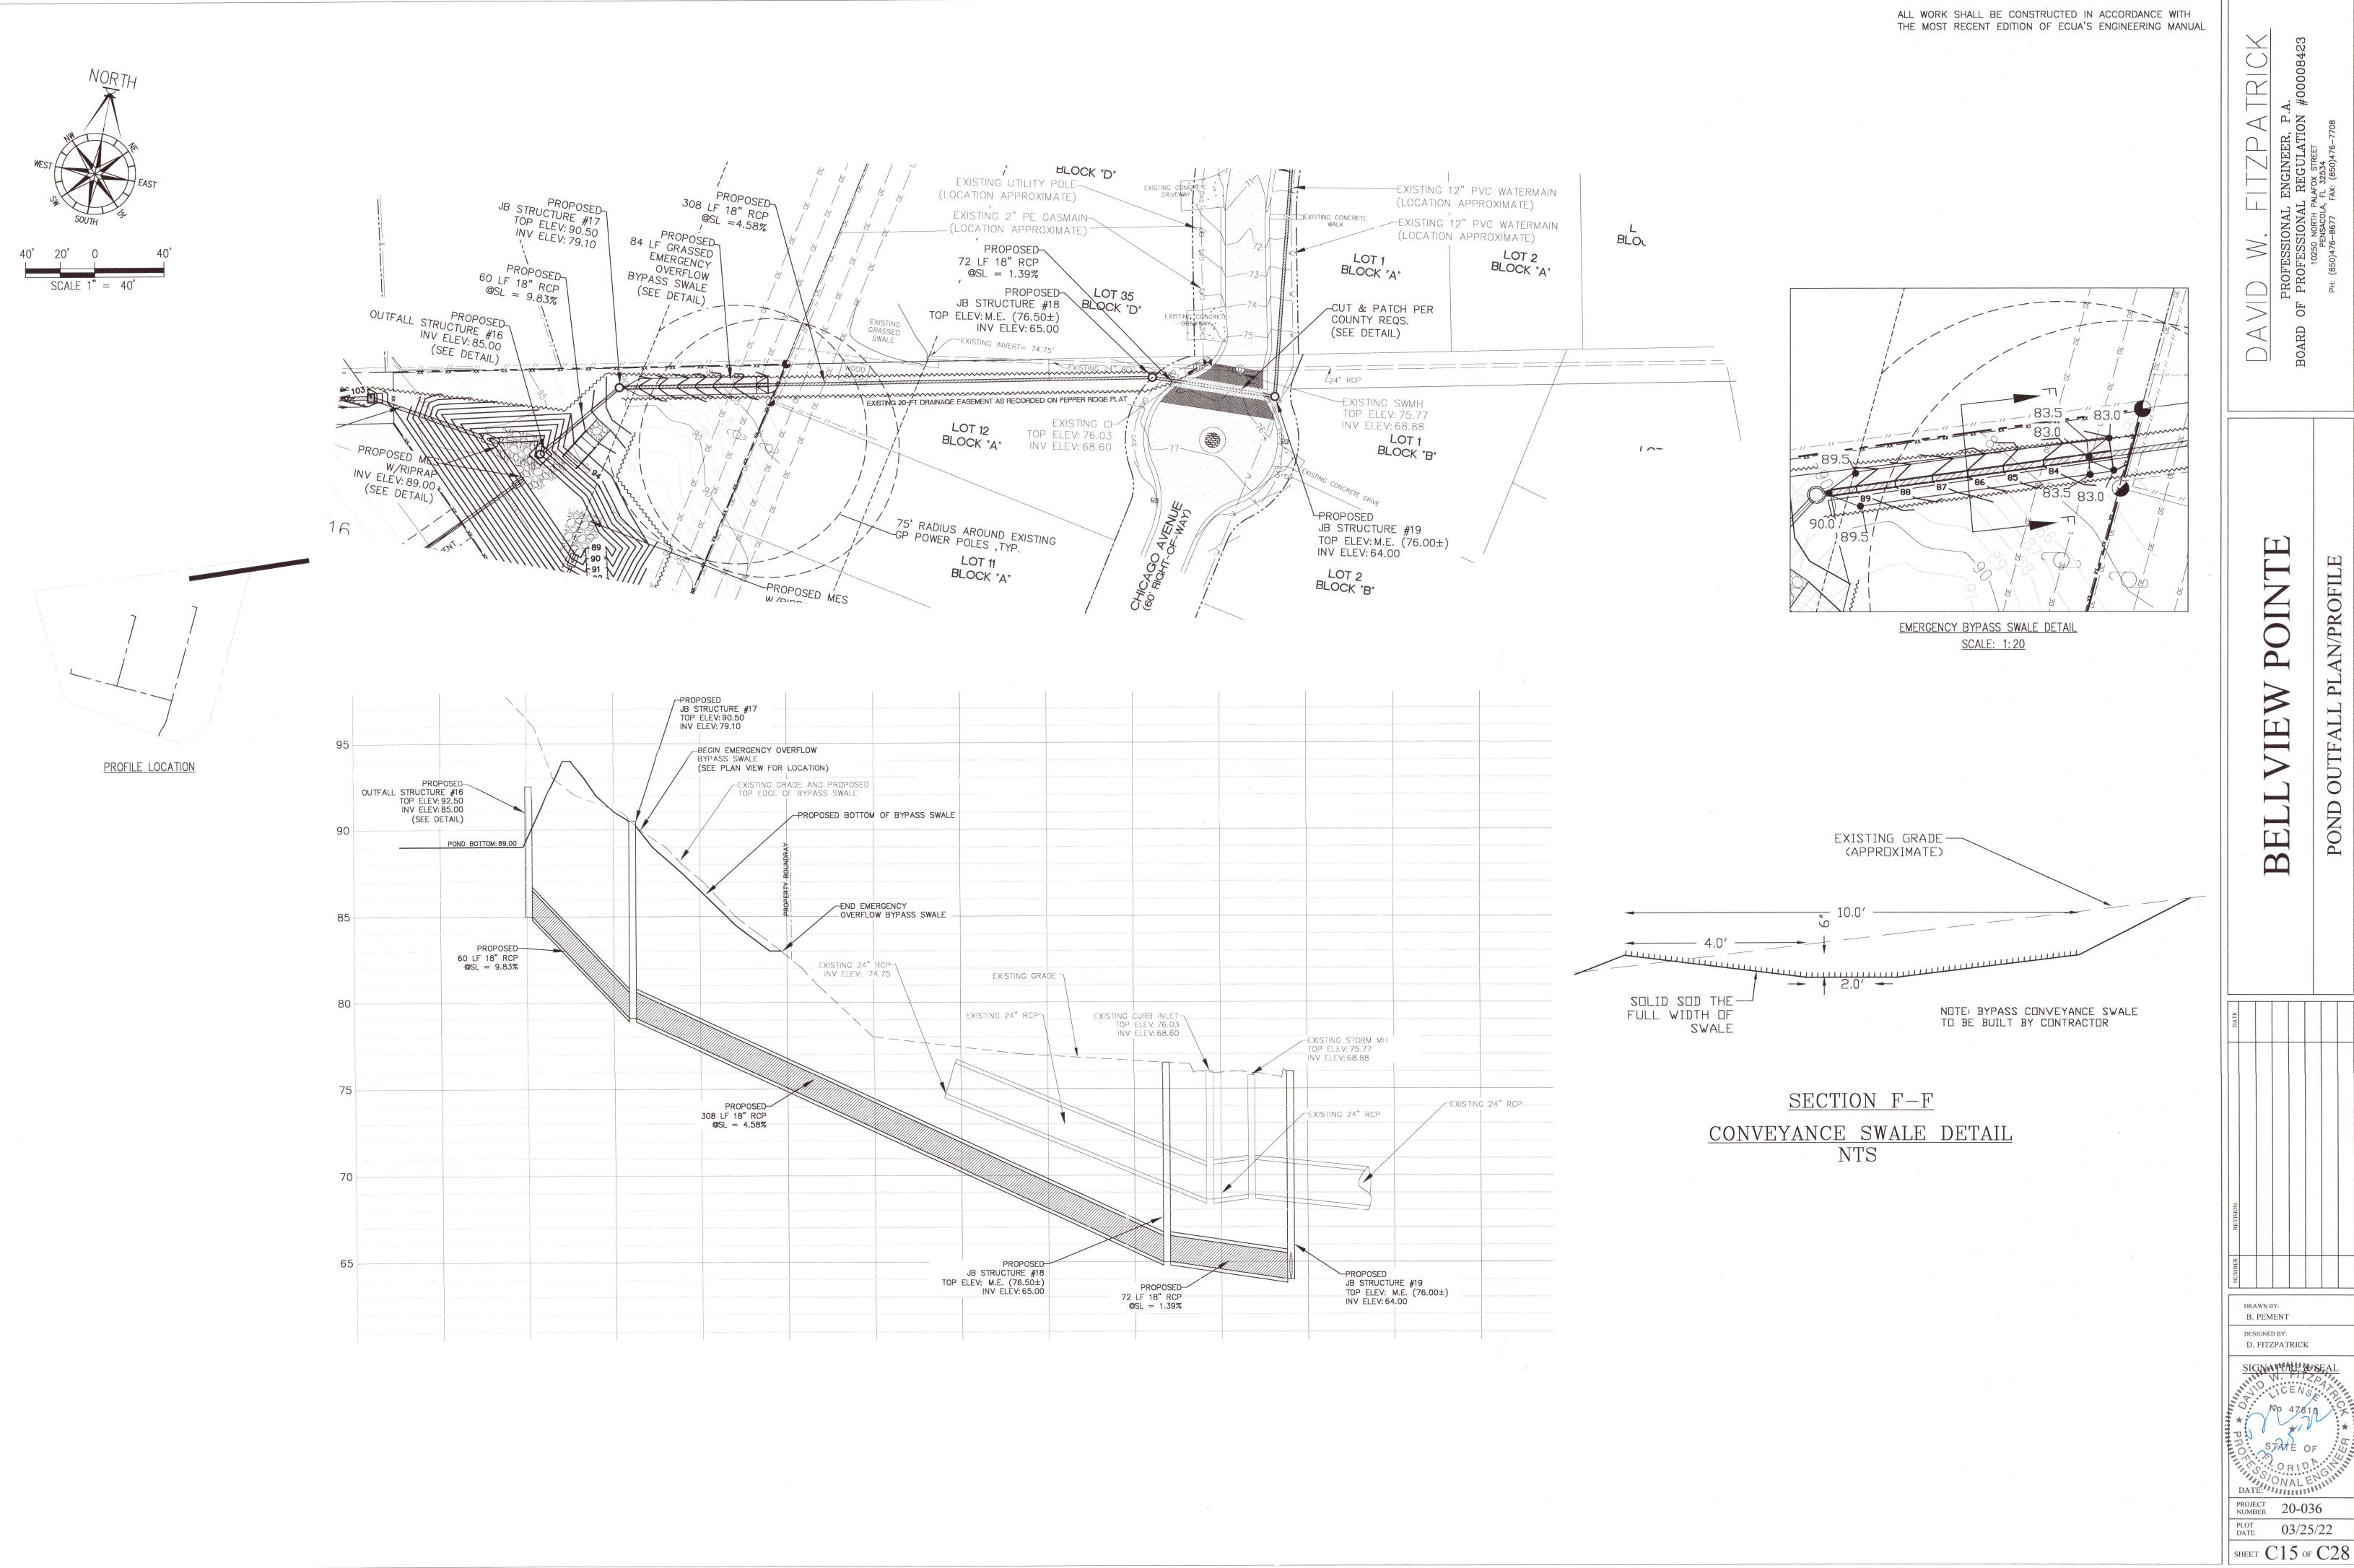PROJECT 20-036

PLOT 03/25/22

STORMWATER OFFSITE

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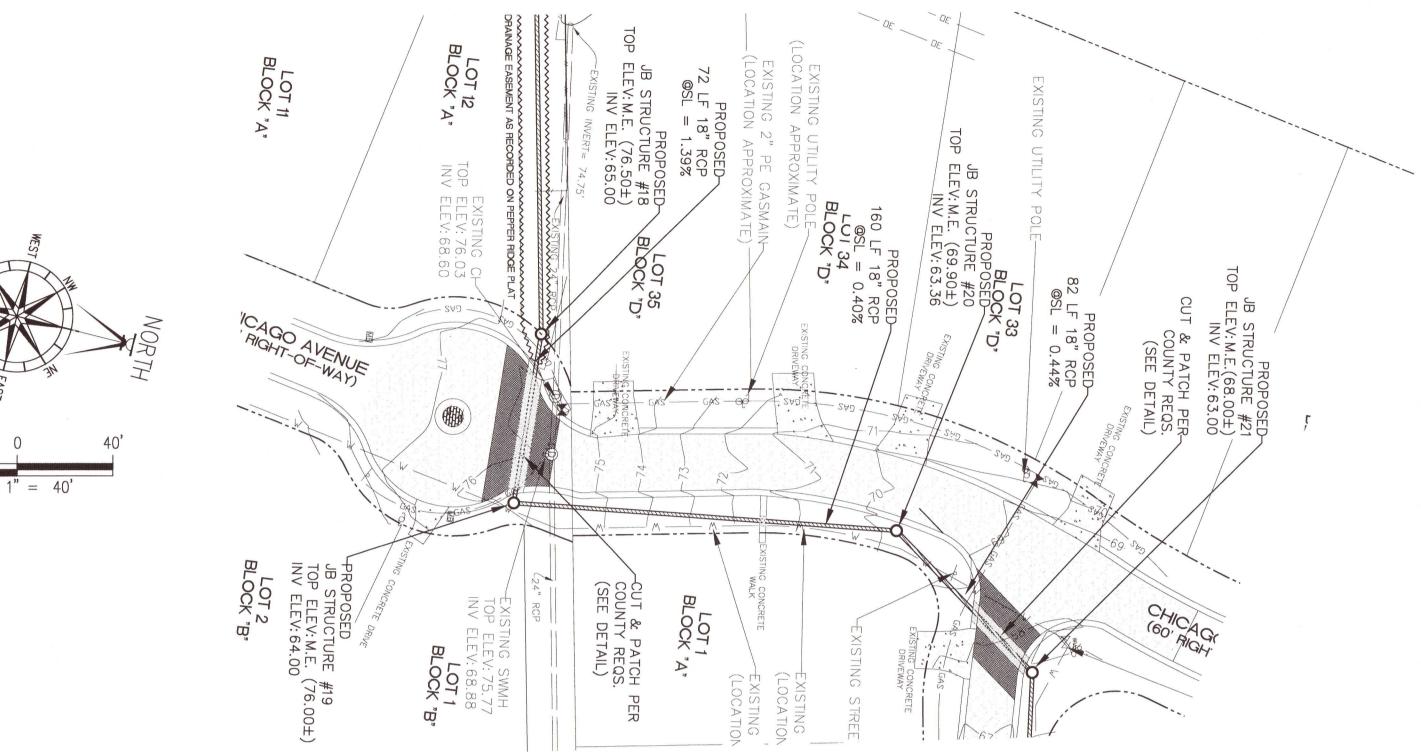
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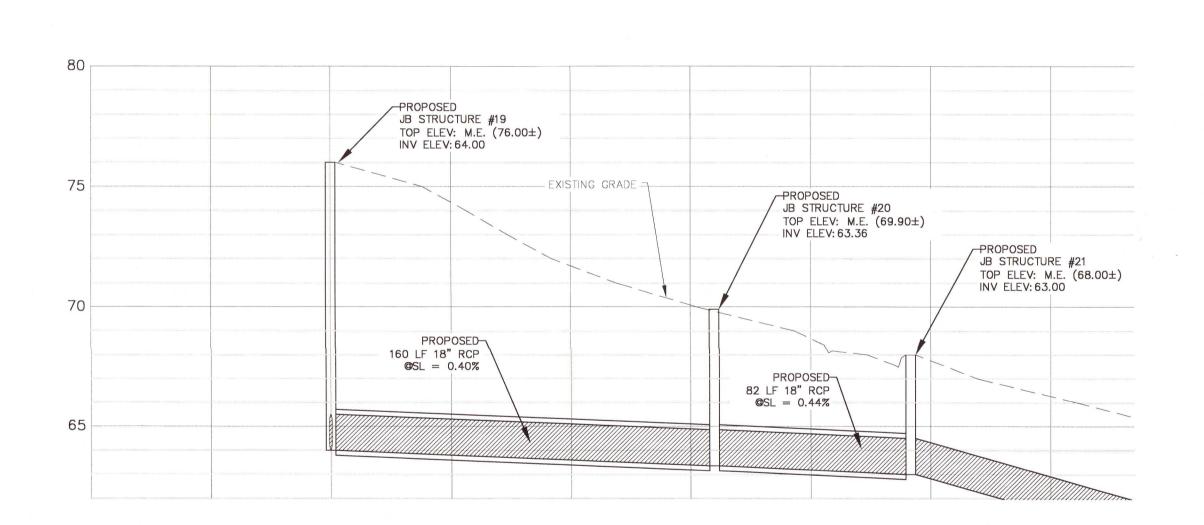
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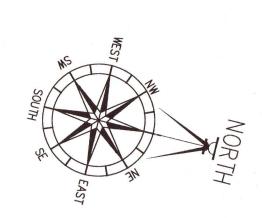
SHEET C16 OF C28


NOTE: ALL DISTURBED EXISTING DRIVEWAYS SHALL BE RESTORED TO ORIGINAL OR BETTER CONDITION.


UTILITY CROSSING NOTE: 10-FT OF ASPHALT ON EITHER SIDE OF THE UTILITY TRENCH SHALL BE MILLED 1.5" DEEP AND RE-SURFACED.









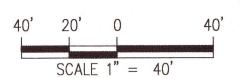

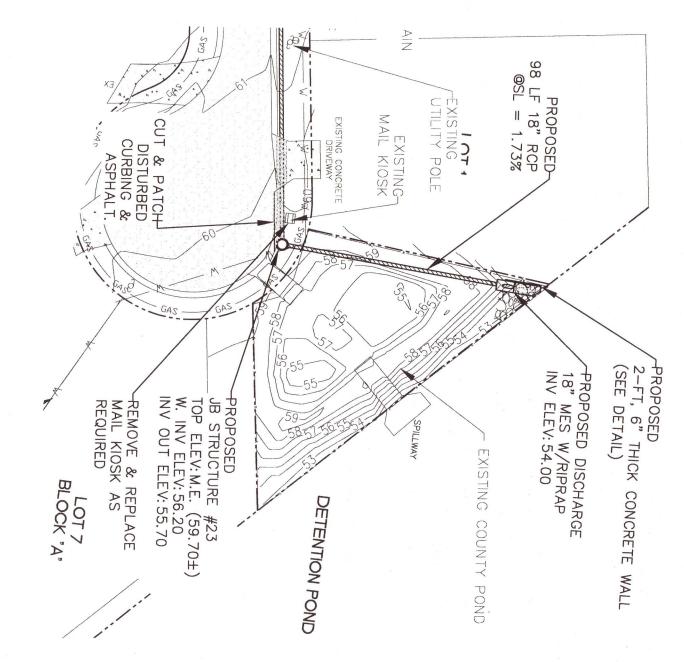

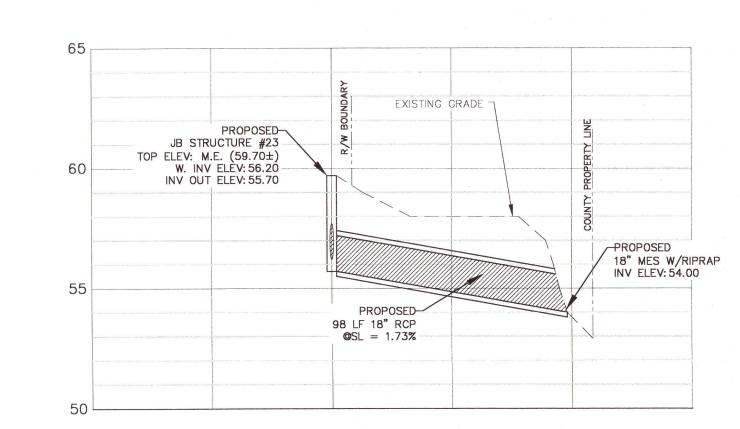


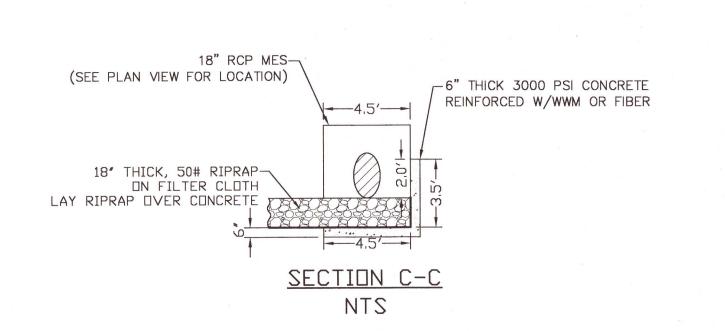



NOTES:
1. ALL DISTURBED EXISTING DRIVEWAYS SHALL BE RESTORED TO ORIGINAL OR BETTER CONDITION.

2. ALL DISTURBED AREAS WITHIN THE COUNTY POND PARCEL SHALL BE RESTORED TO ORIGINAL OR BETTER CONDITION, AND STABILIZED WITH SOLID SOD

UTILITY CROSSING NOTE: 10-FT OF ASPHALT ON EITHER SIDE OF THE UTILITY TRENCH SHALL BE MILLED 1.5" DEEP AND RE-SURFACED.

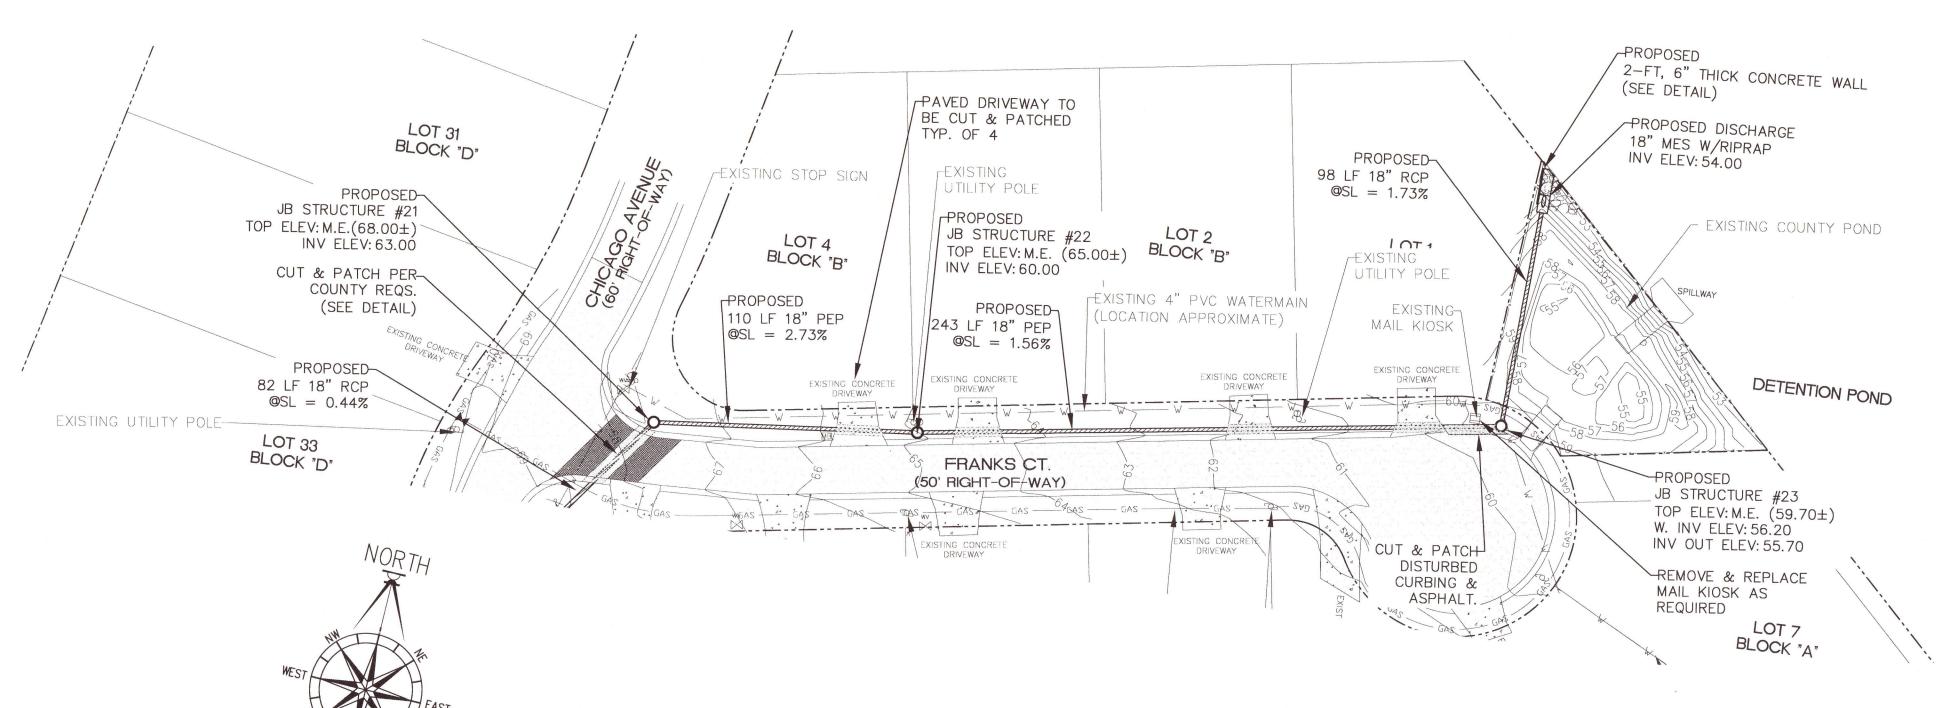

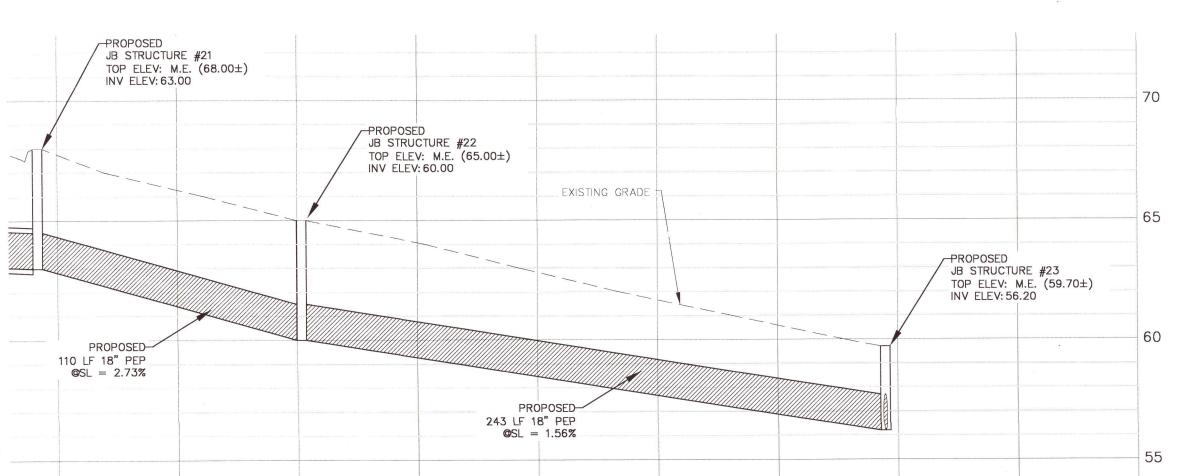

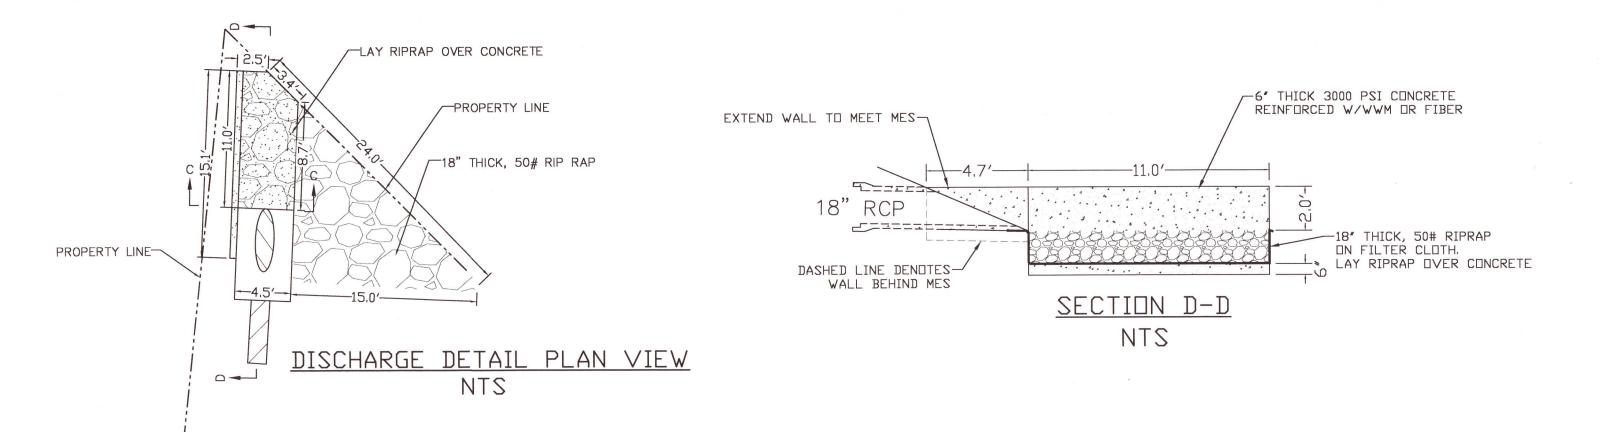

LLVIEW POINT

STORMWATER

SITE

NUMBER REVISION DATE

DRAWN BY:
B. PEMENT

DESIGNED BY:
D. FITZPATRICK

SIGNATURE & SEAL

FITZPA

NO 47818

NO 47818


PROJECT OR 10

PROJECT 20-036

PROJECT 120-1036

PLOT 03/25/22

SHEET C17 OF C28

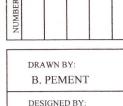



D. FITZPATRICK

SIGNATURE & SEAL


STATE OF DATE: SOONAL PROJECT 20-036


PLOT 03/25/22 SHEET C18 OF C28

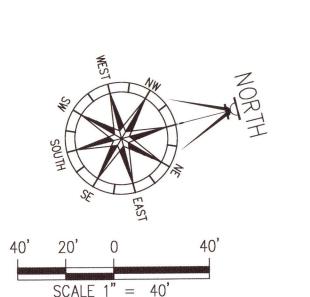

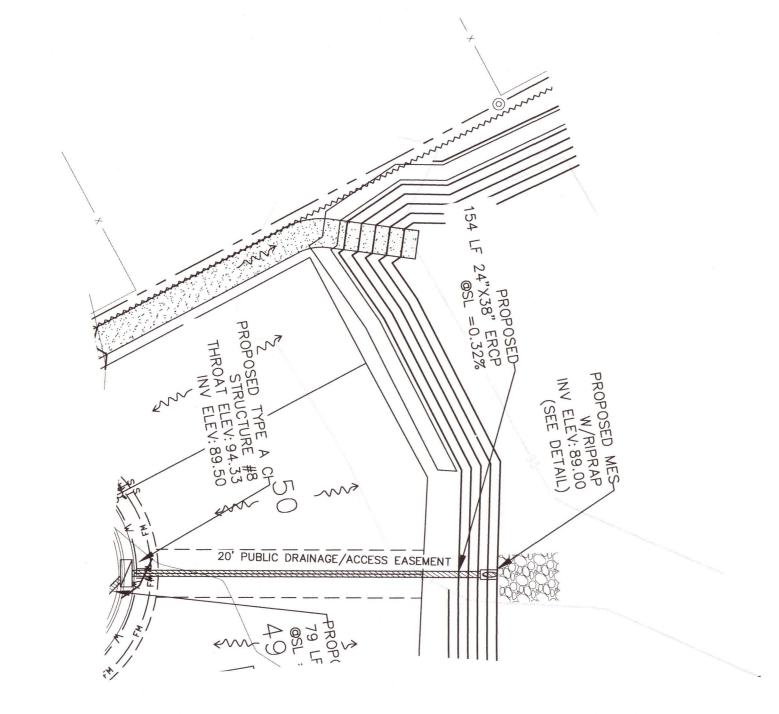



BELLVIEW POINTE CIR.

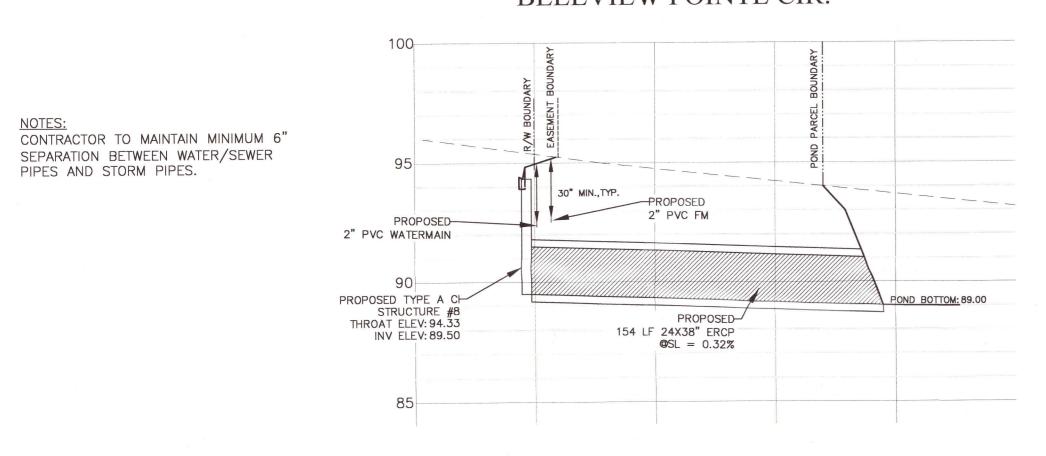


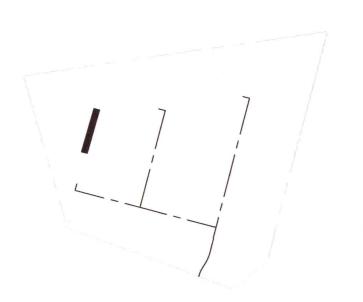



PROFILE LOCATION

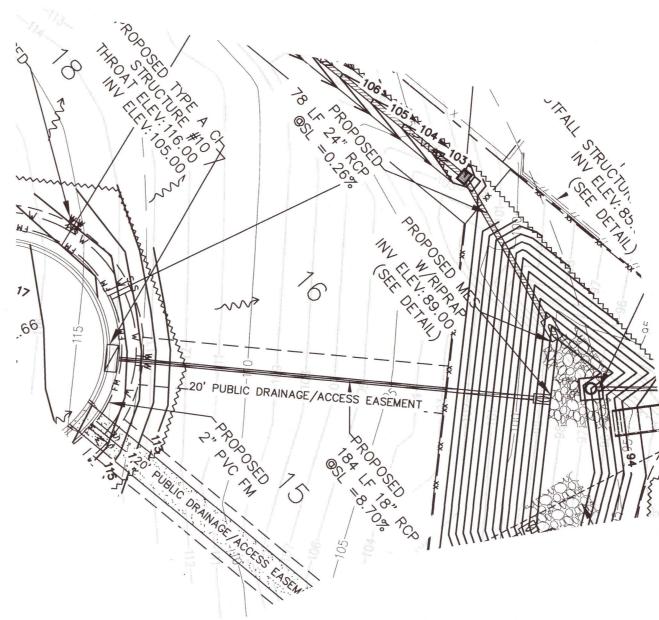


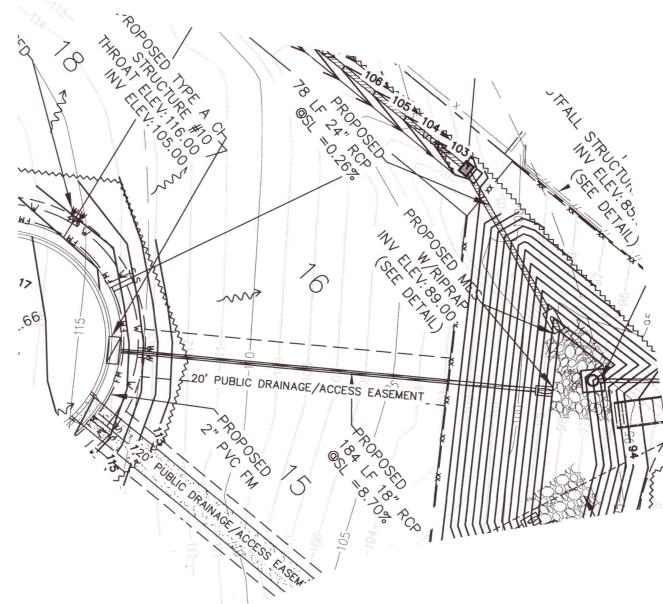

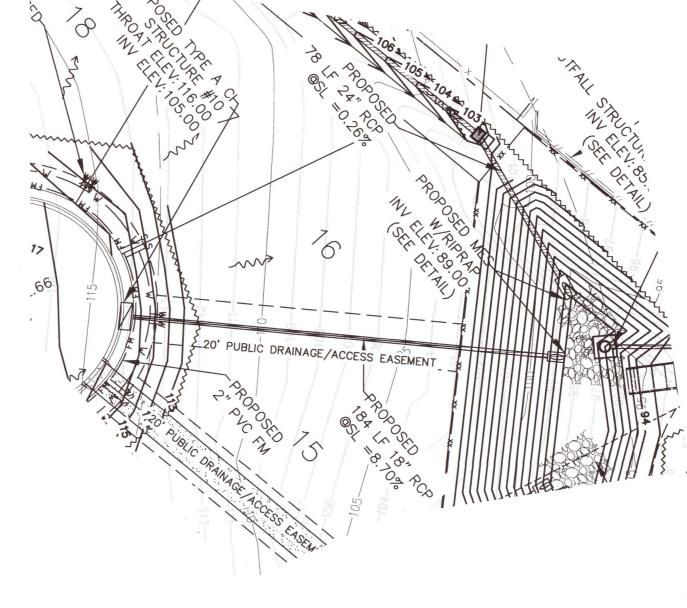


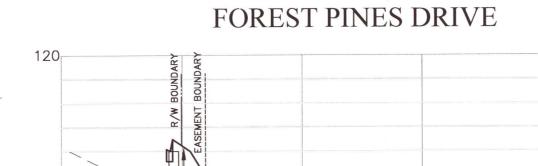


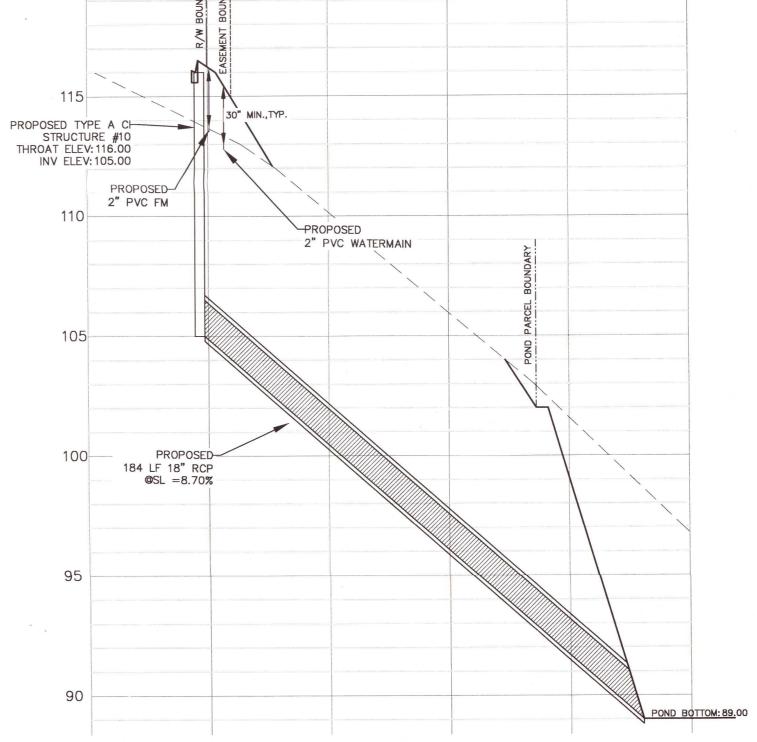


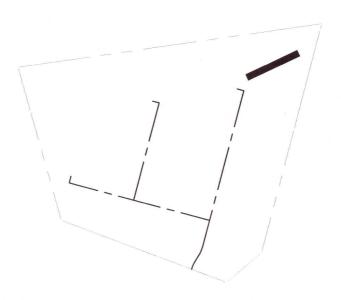


PROFILE LOCATION

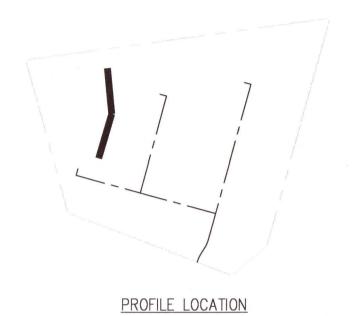

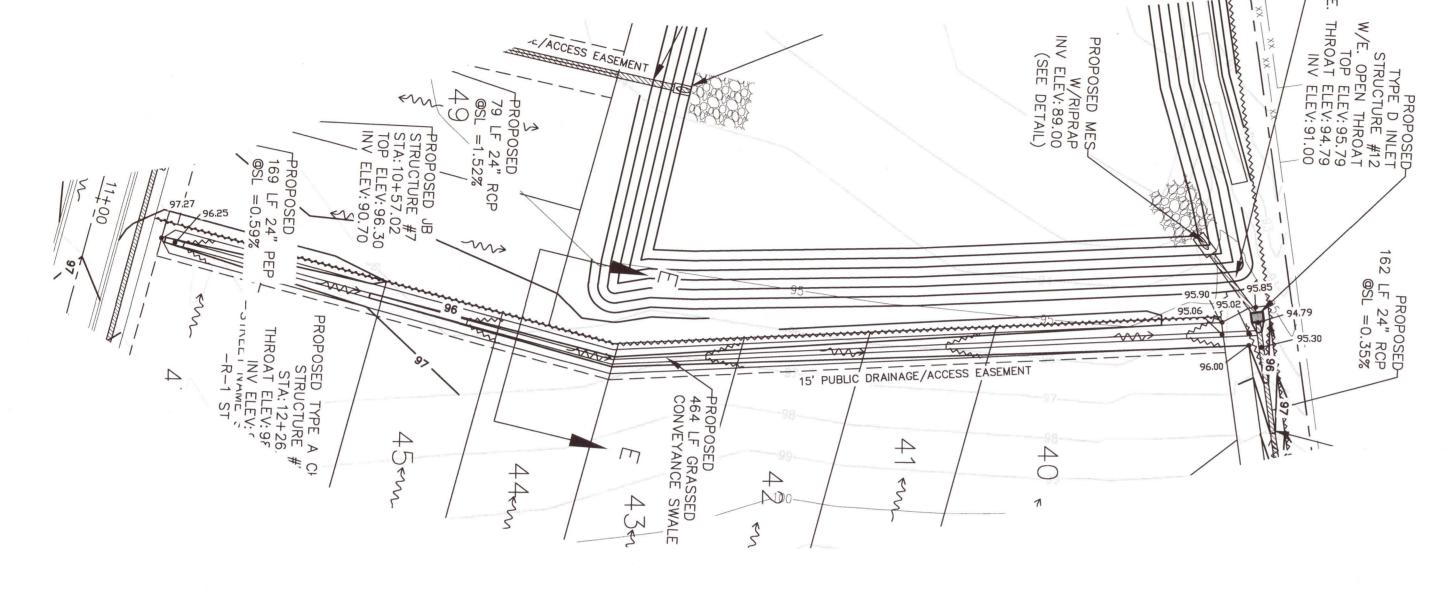

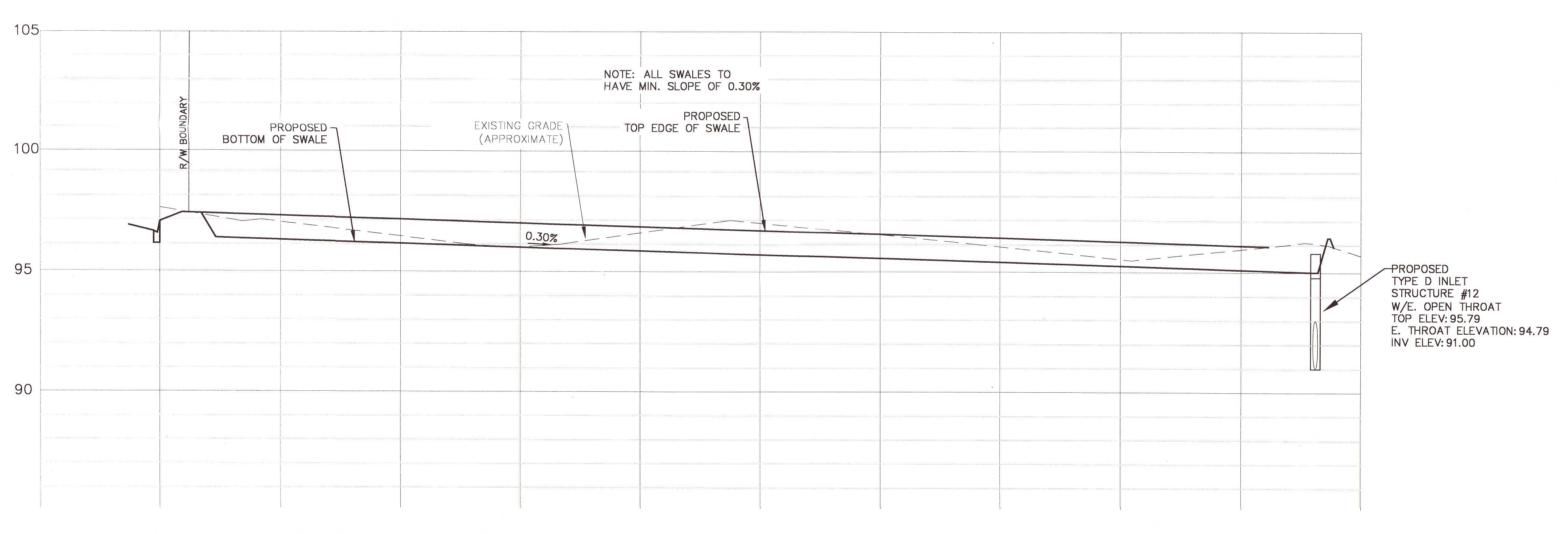

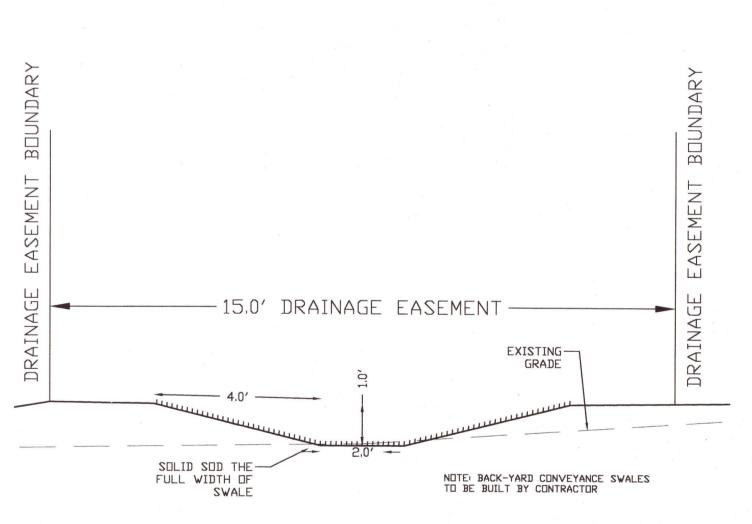

SECTION E-E CONVEYANCE SWALE DETAIL NTS

BE

MISC. PROFILES


DRAWN BY:

B. PEMENT DESIGNED BY:

D. FITZPATRICK SIGNATURE & SEAL

PROJECT 20-036

PLOT 03/25/22 SHEET C19 OF C28

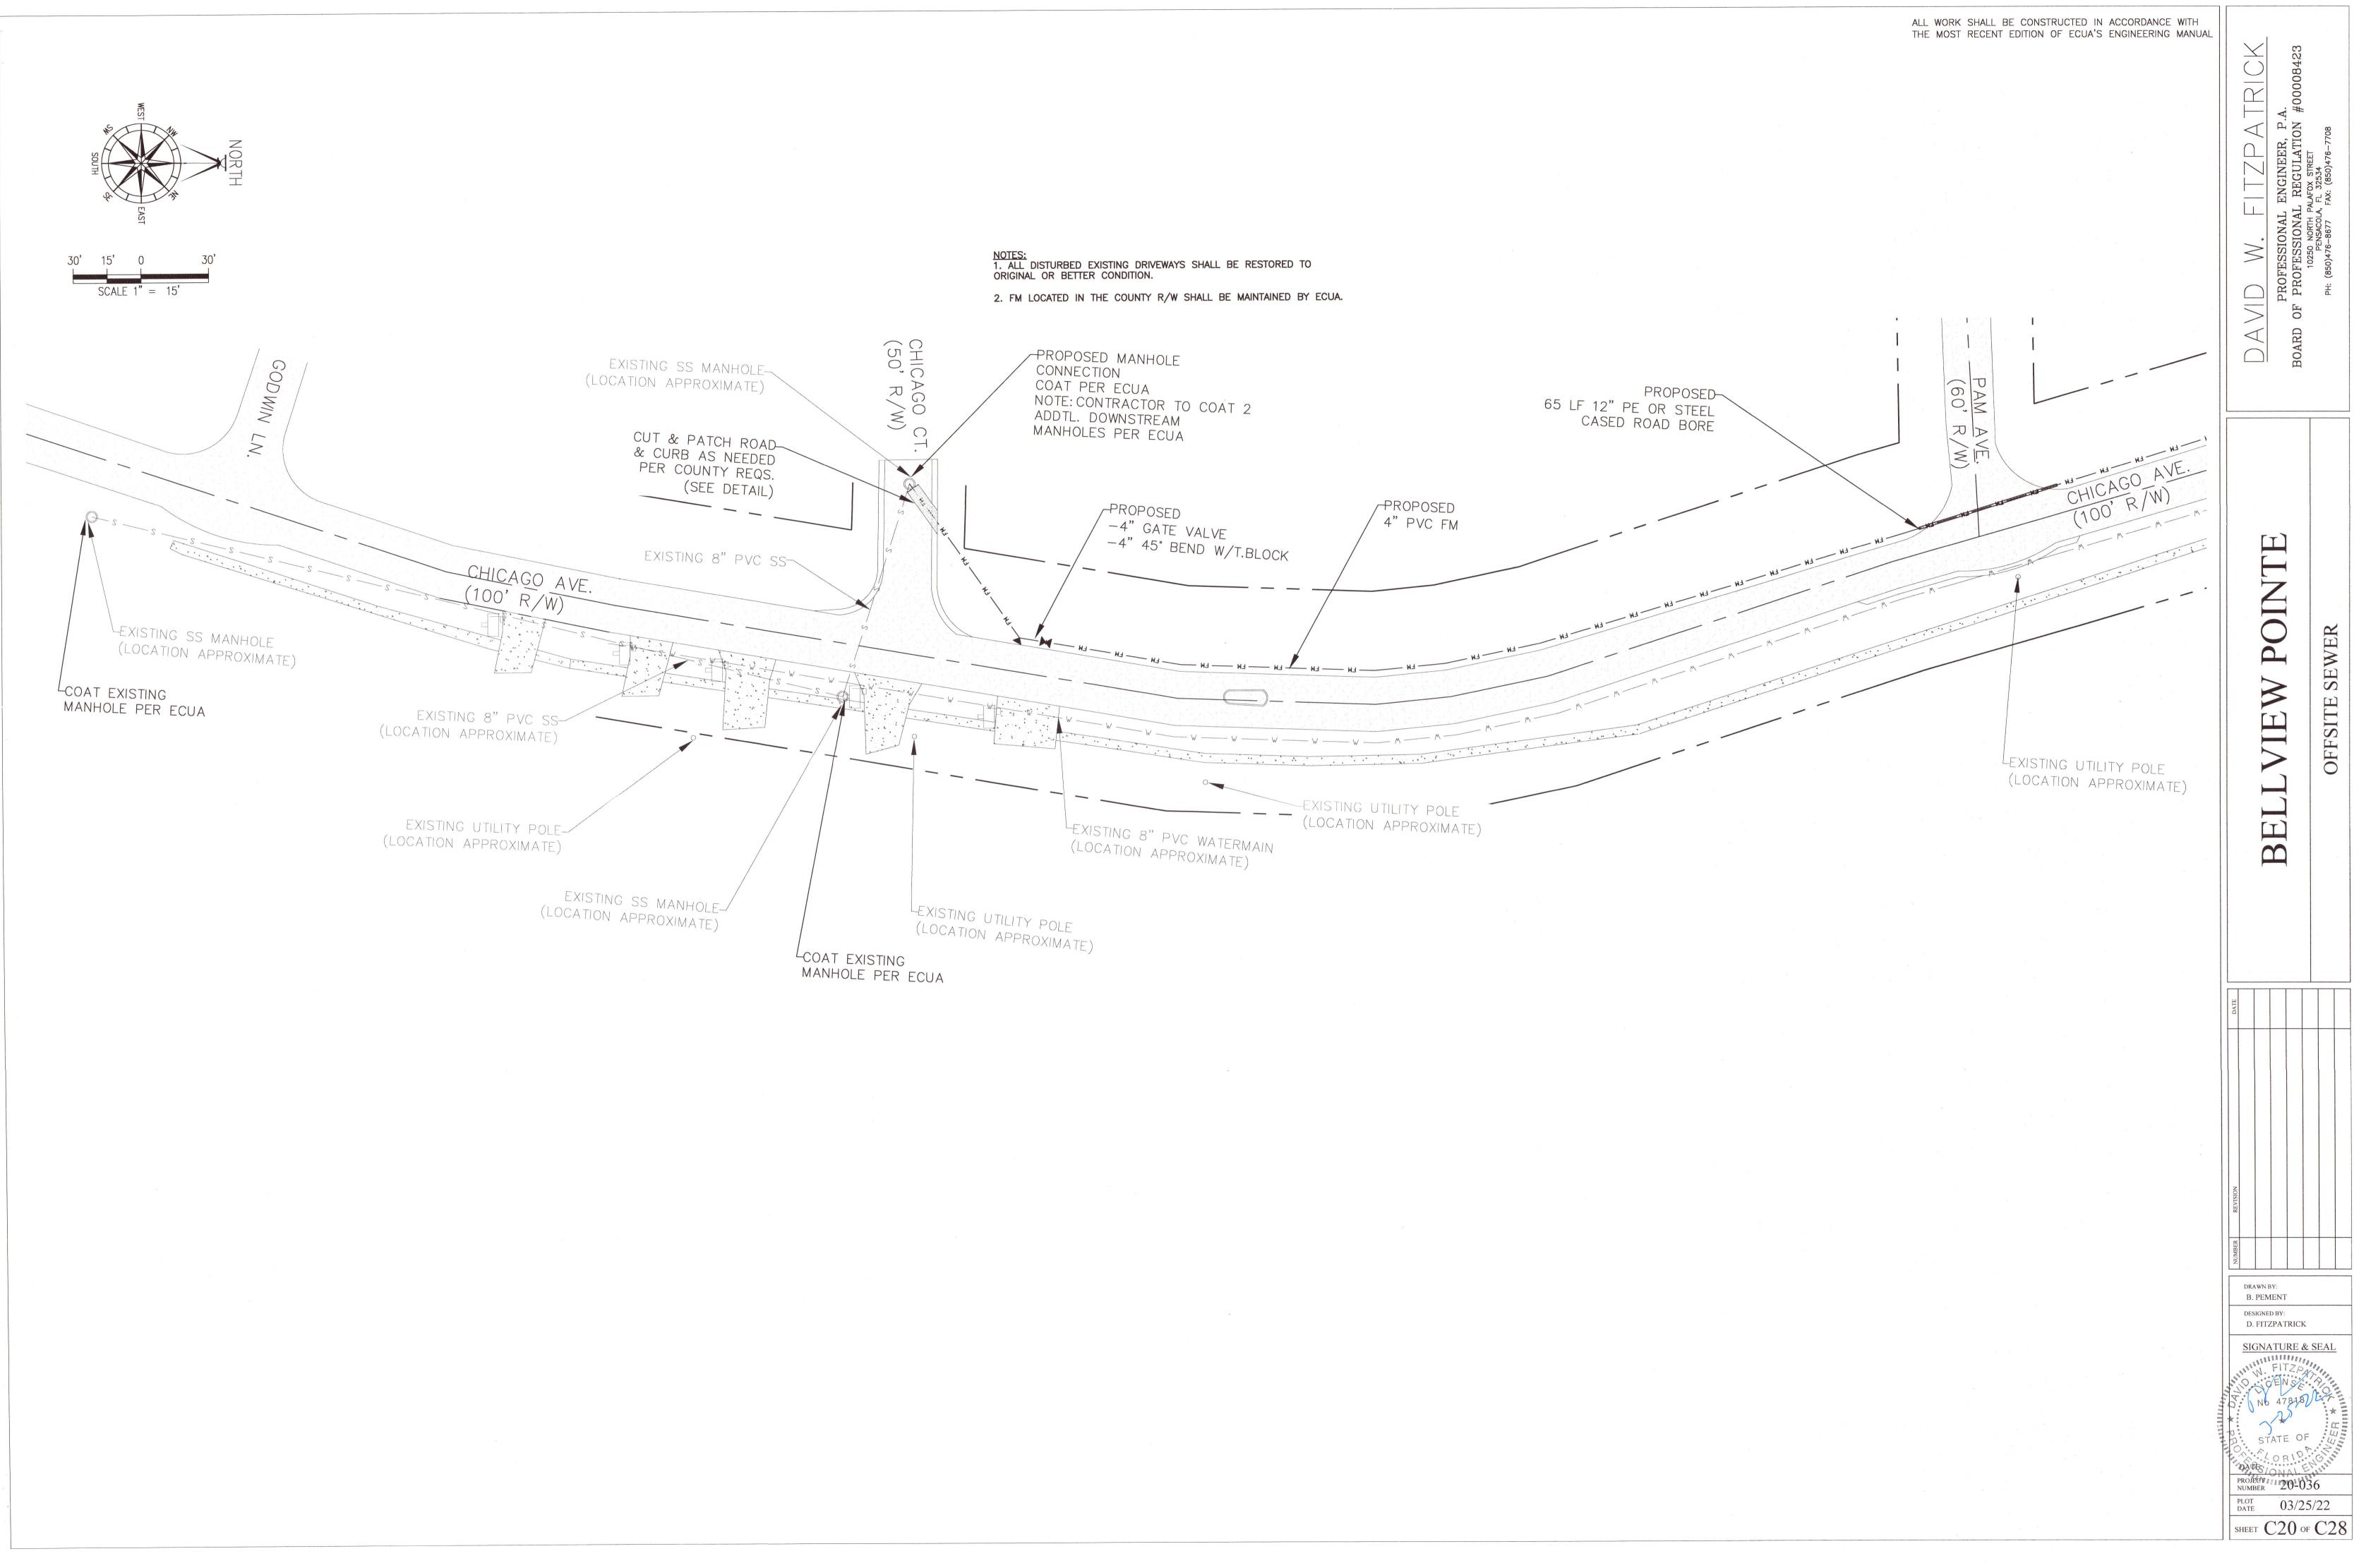

SEWER

OFFSITE

B. PEMENT DESIGNED BY:

SIGNATURE & SEAL

STATE OF

PROJECT 120-036

PLOT DATE 03/25/22

BEL

B. PEMENT

DESIGNED BY: D. FITZPATRICK


PROJECT NUMBER 20-036

PLOT 03/25/22 SHEET C21 OF C28

NOTES:

1. ALL DISTURBED EXISTING DRIVEWAYS SHALL BE RESTORED TO ORIGINAL OR BETTER CONDITION.

2. FM LOCATED IN THE COUNTY R/W SHALL BE MAINTAINED BY ECUA.

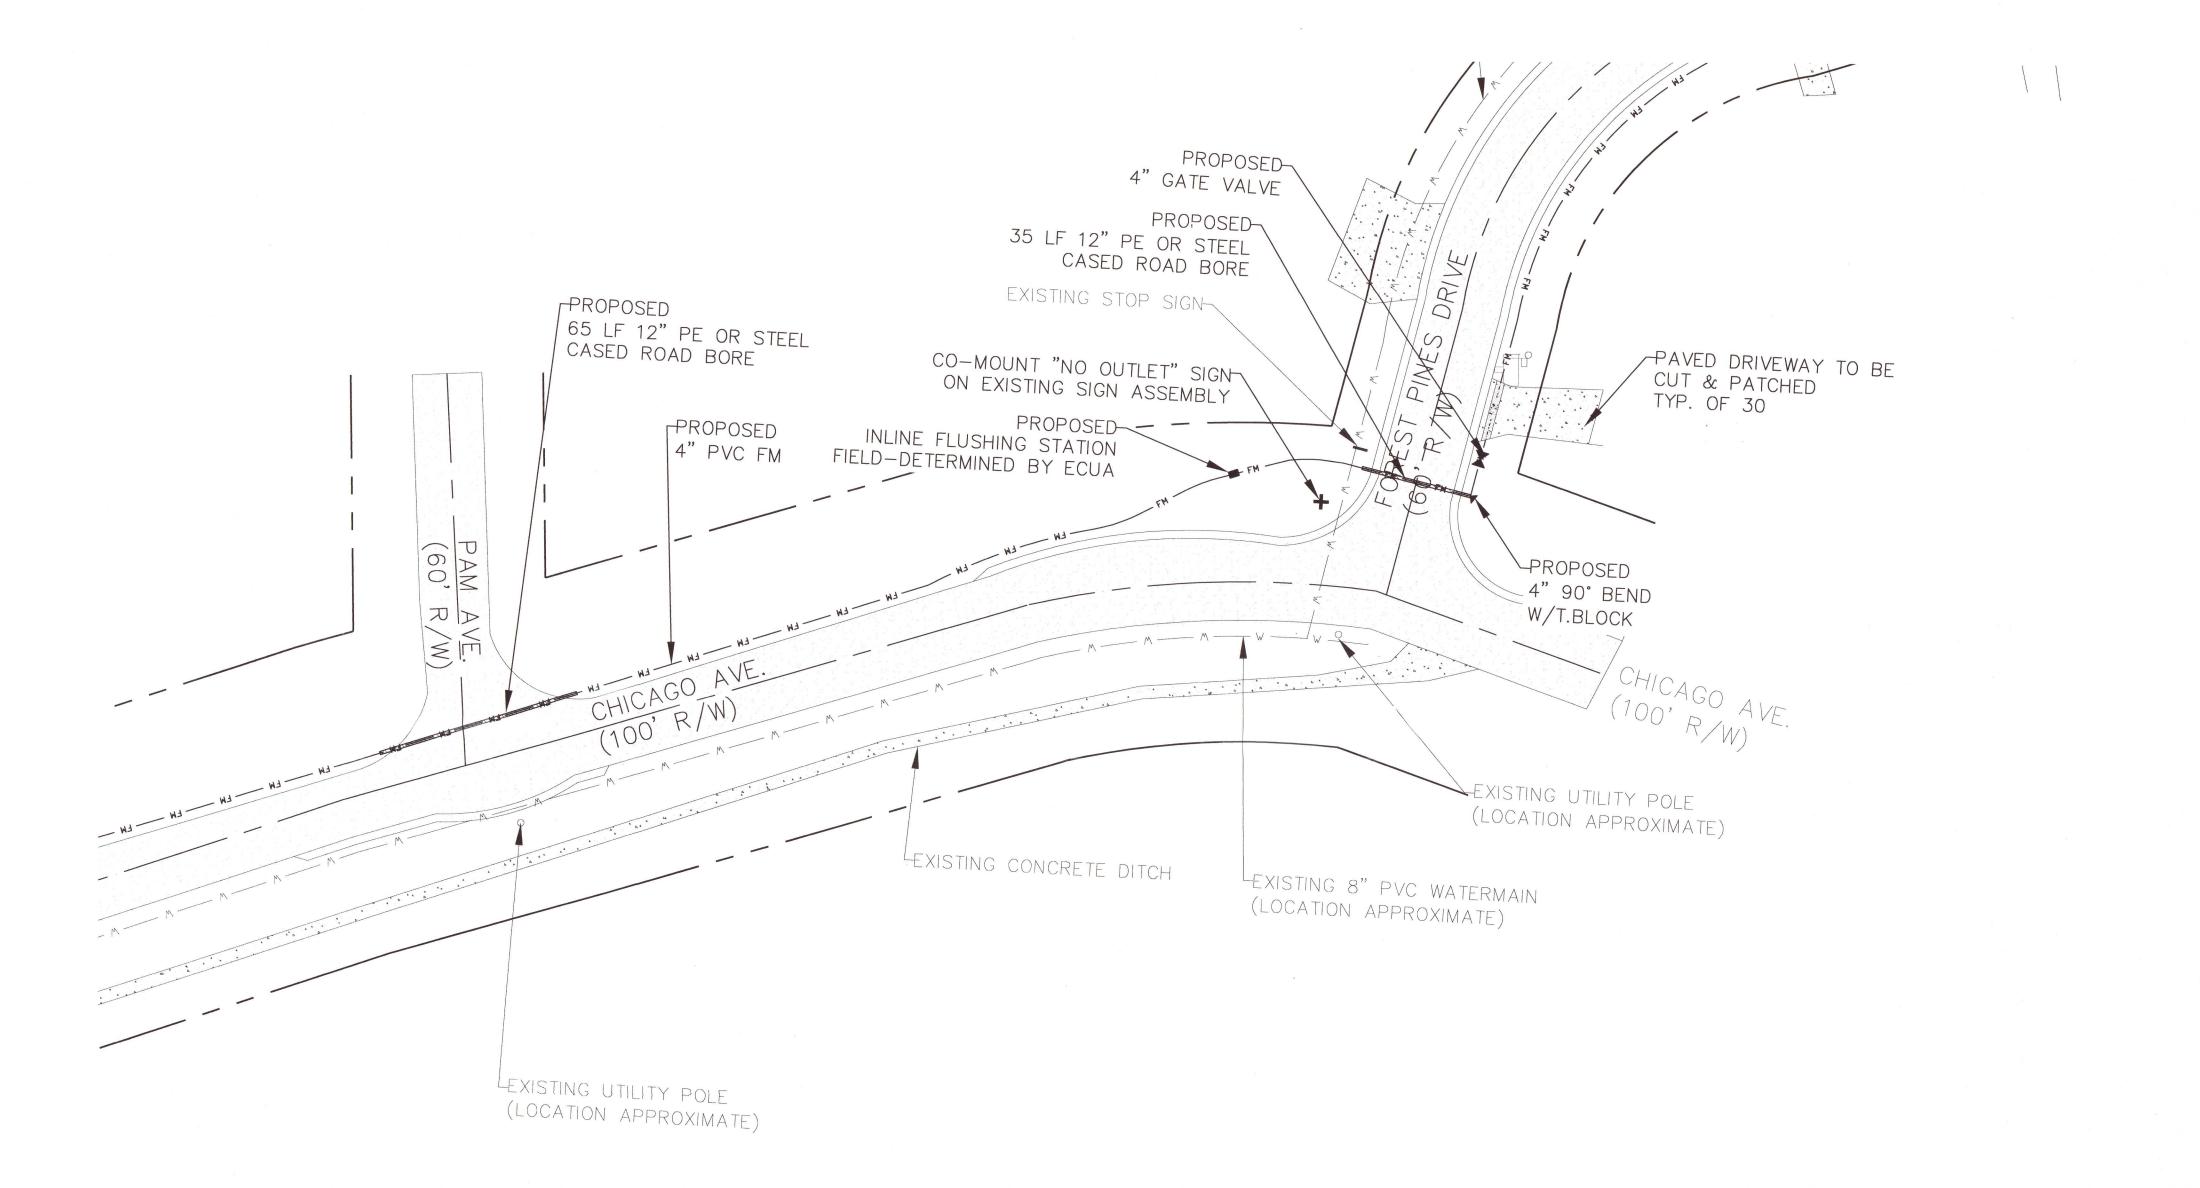

BE

DRAWN BY: B. PEMENT

DESIGNED BY: D. FITZPATRICK

SIGNATURE & SEAL


PLOT 03/25/22 SHEET C22 OF C28


SCALE 1" = 15'

NOTES:

1. ALL DISTURBED EXISTING DRIVEWAYS SHALL BE RESTORED TO ORIGINAL OR BETTER CONDITION.

2. FM LOCATED IN THE COUNTY R/W SHALL BE MAINTAINED BY ECUA.

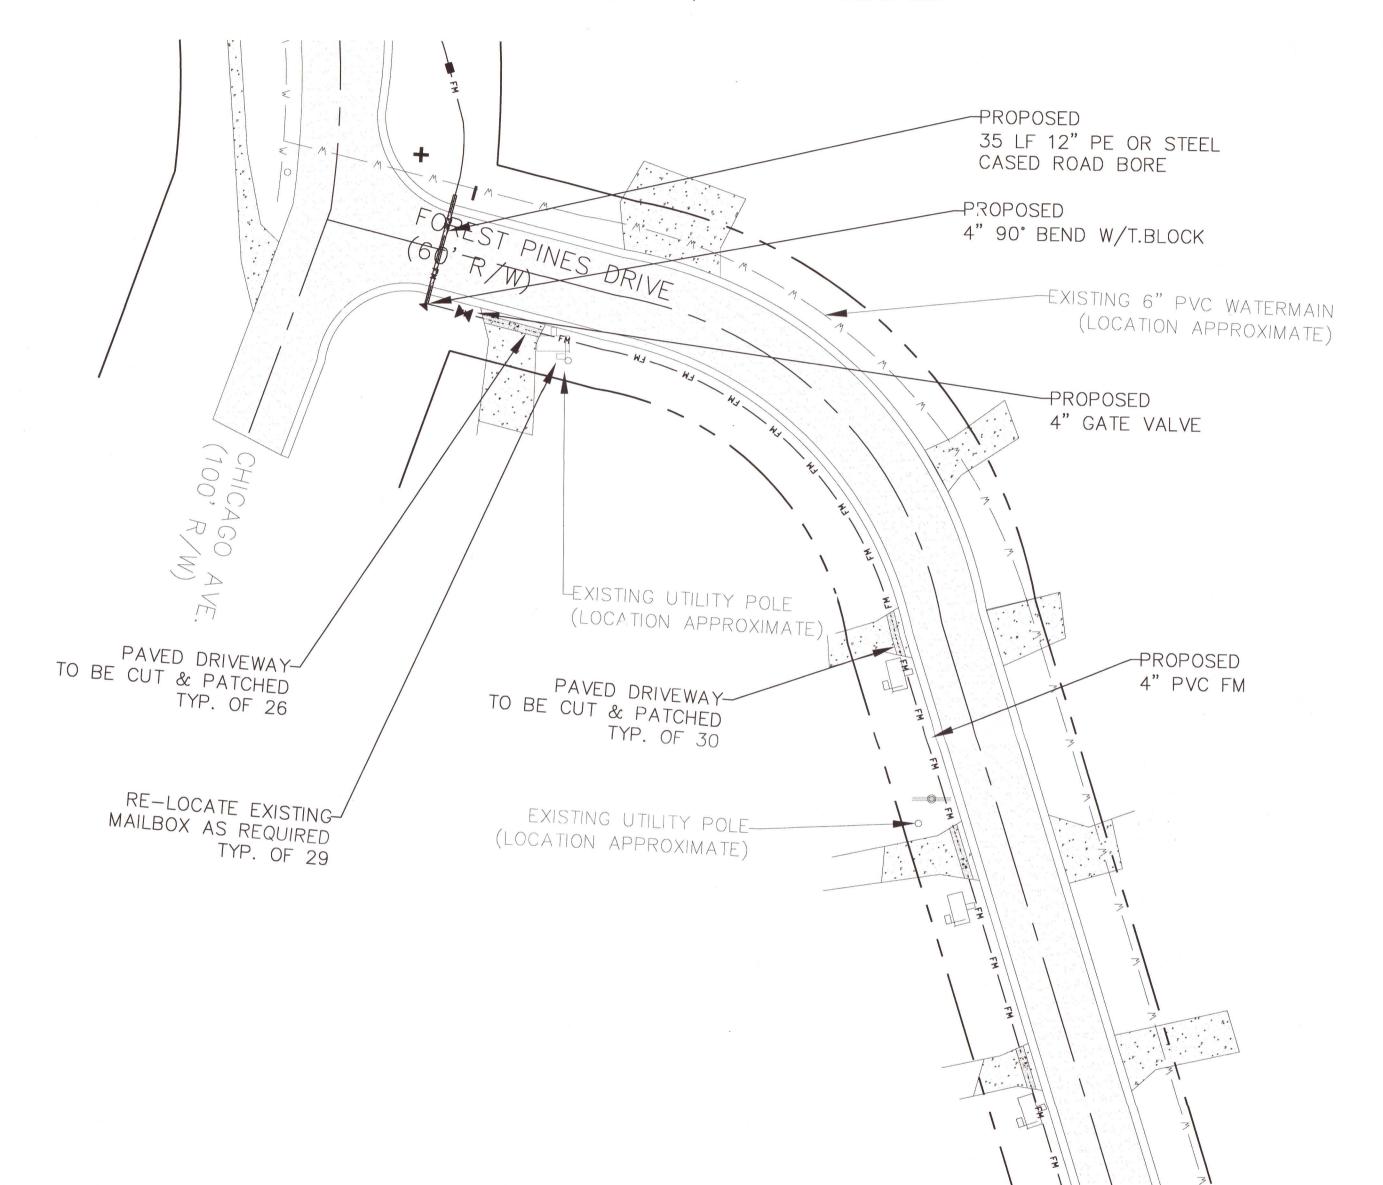


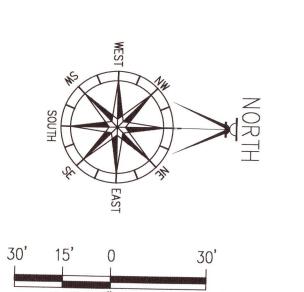

NOTES:

1. ALL DISTURBED EXISTING DRIVEWAYS SHALL BE RESTORED TO ORIGINAL OR BETTER CONDITION.

2. FM LOCATED IN THE COUNTY R/W SHALL BE MAINTAINED BY ECUA.

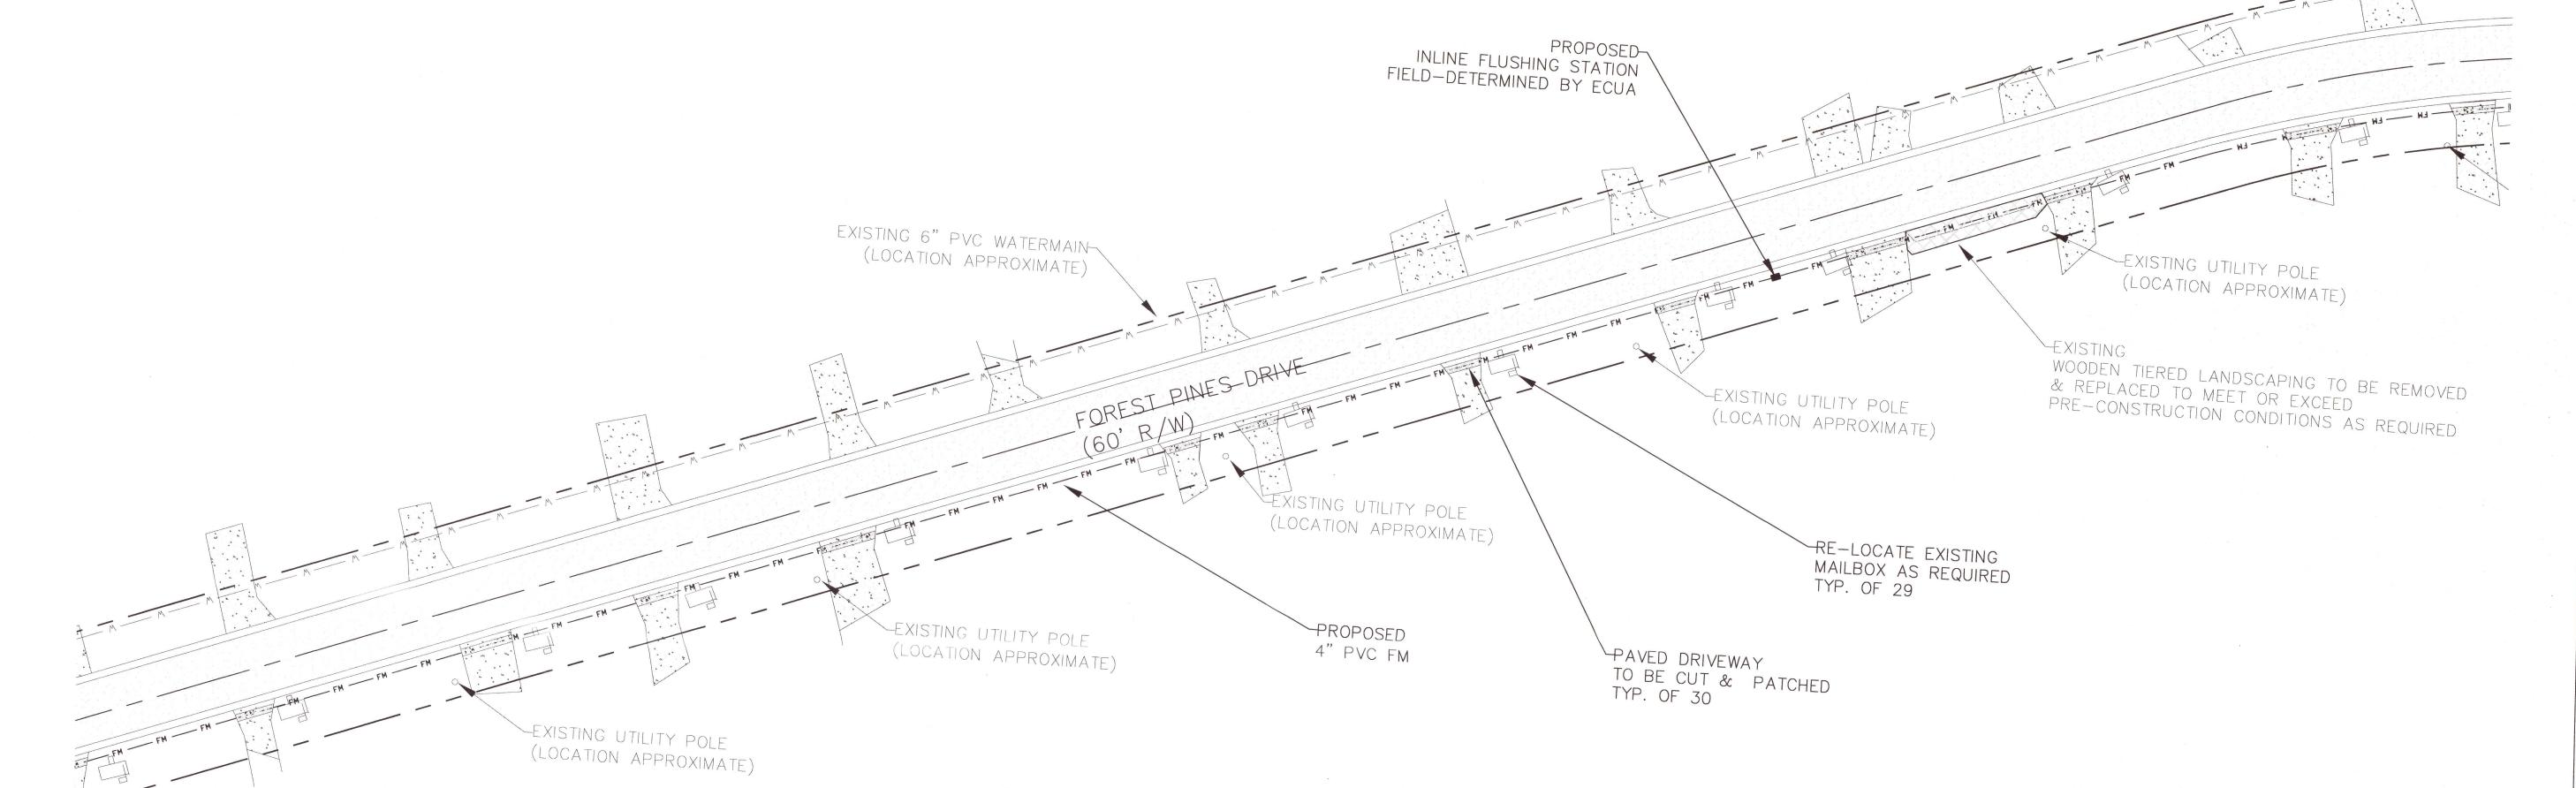

POINTE BEL

DRAWN BY:

B. PEMENT DESIGNED BY: D. FITZPATRICK



PROJECT 20-036 PLOT DATE 03/25/22

SHEET C23 OF C28


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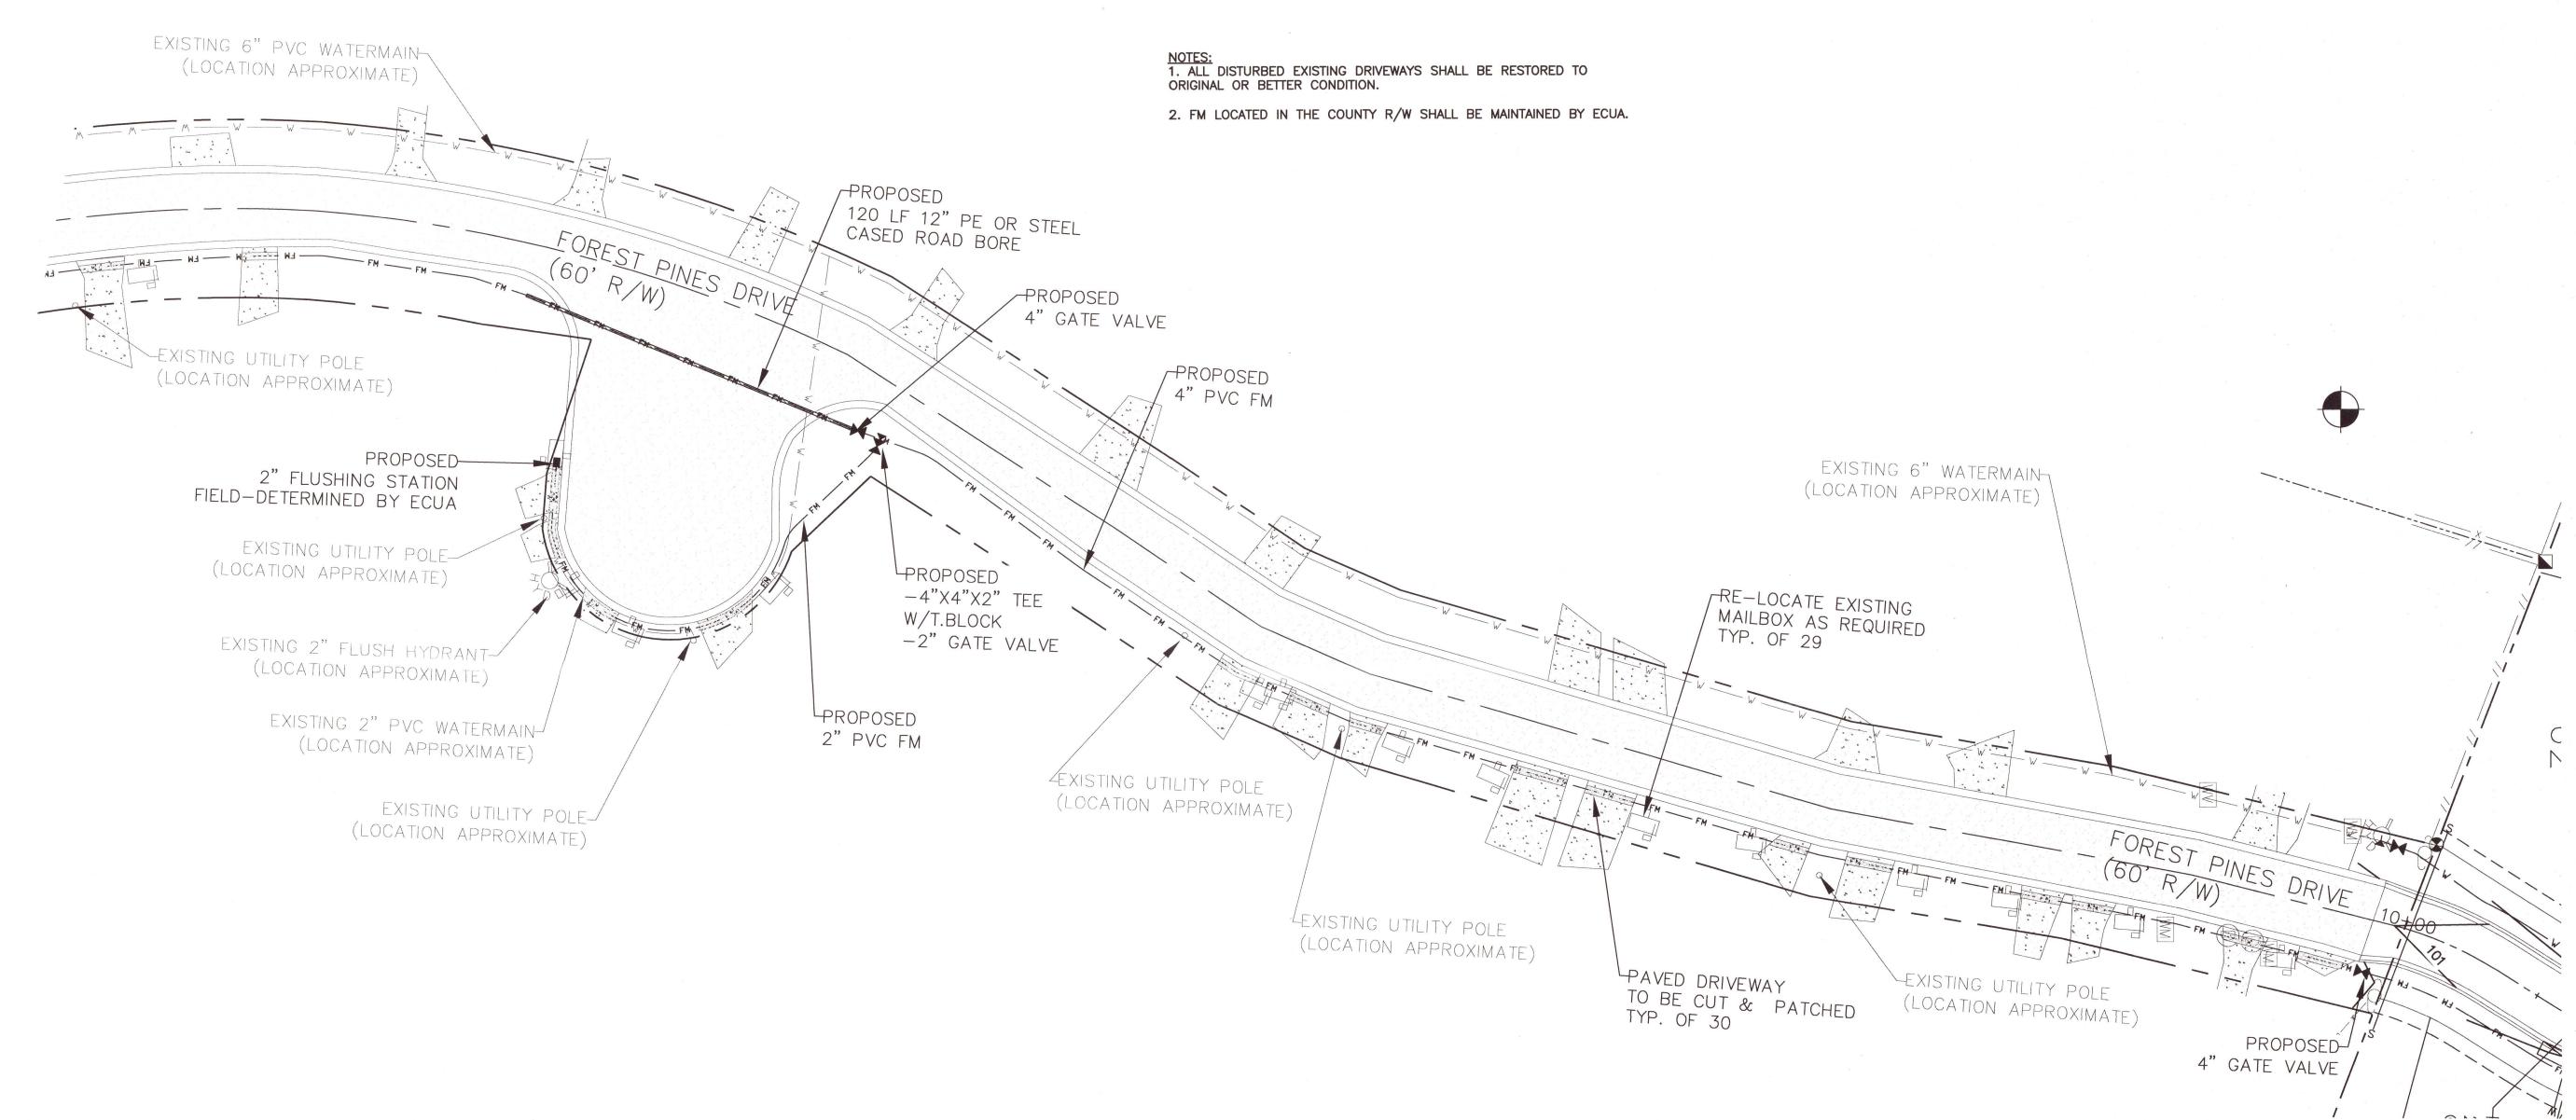
B. PEMENT


D. FITZPATRICK

PROJECT 20-036

PLOT 03/25/22 SHEET C24 OF C28



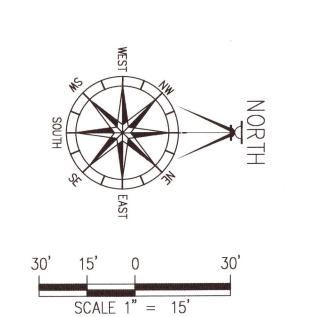

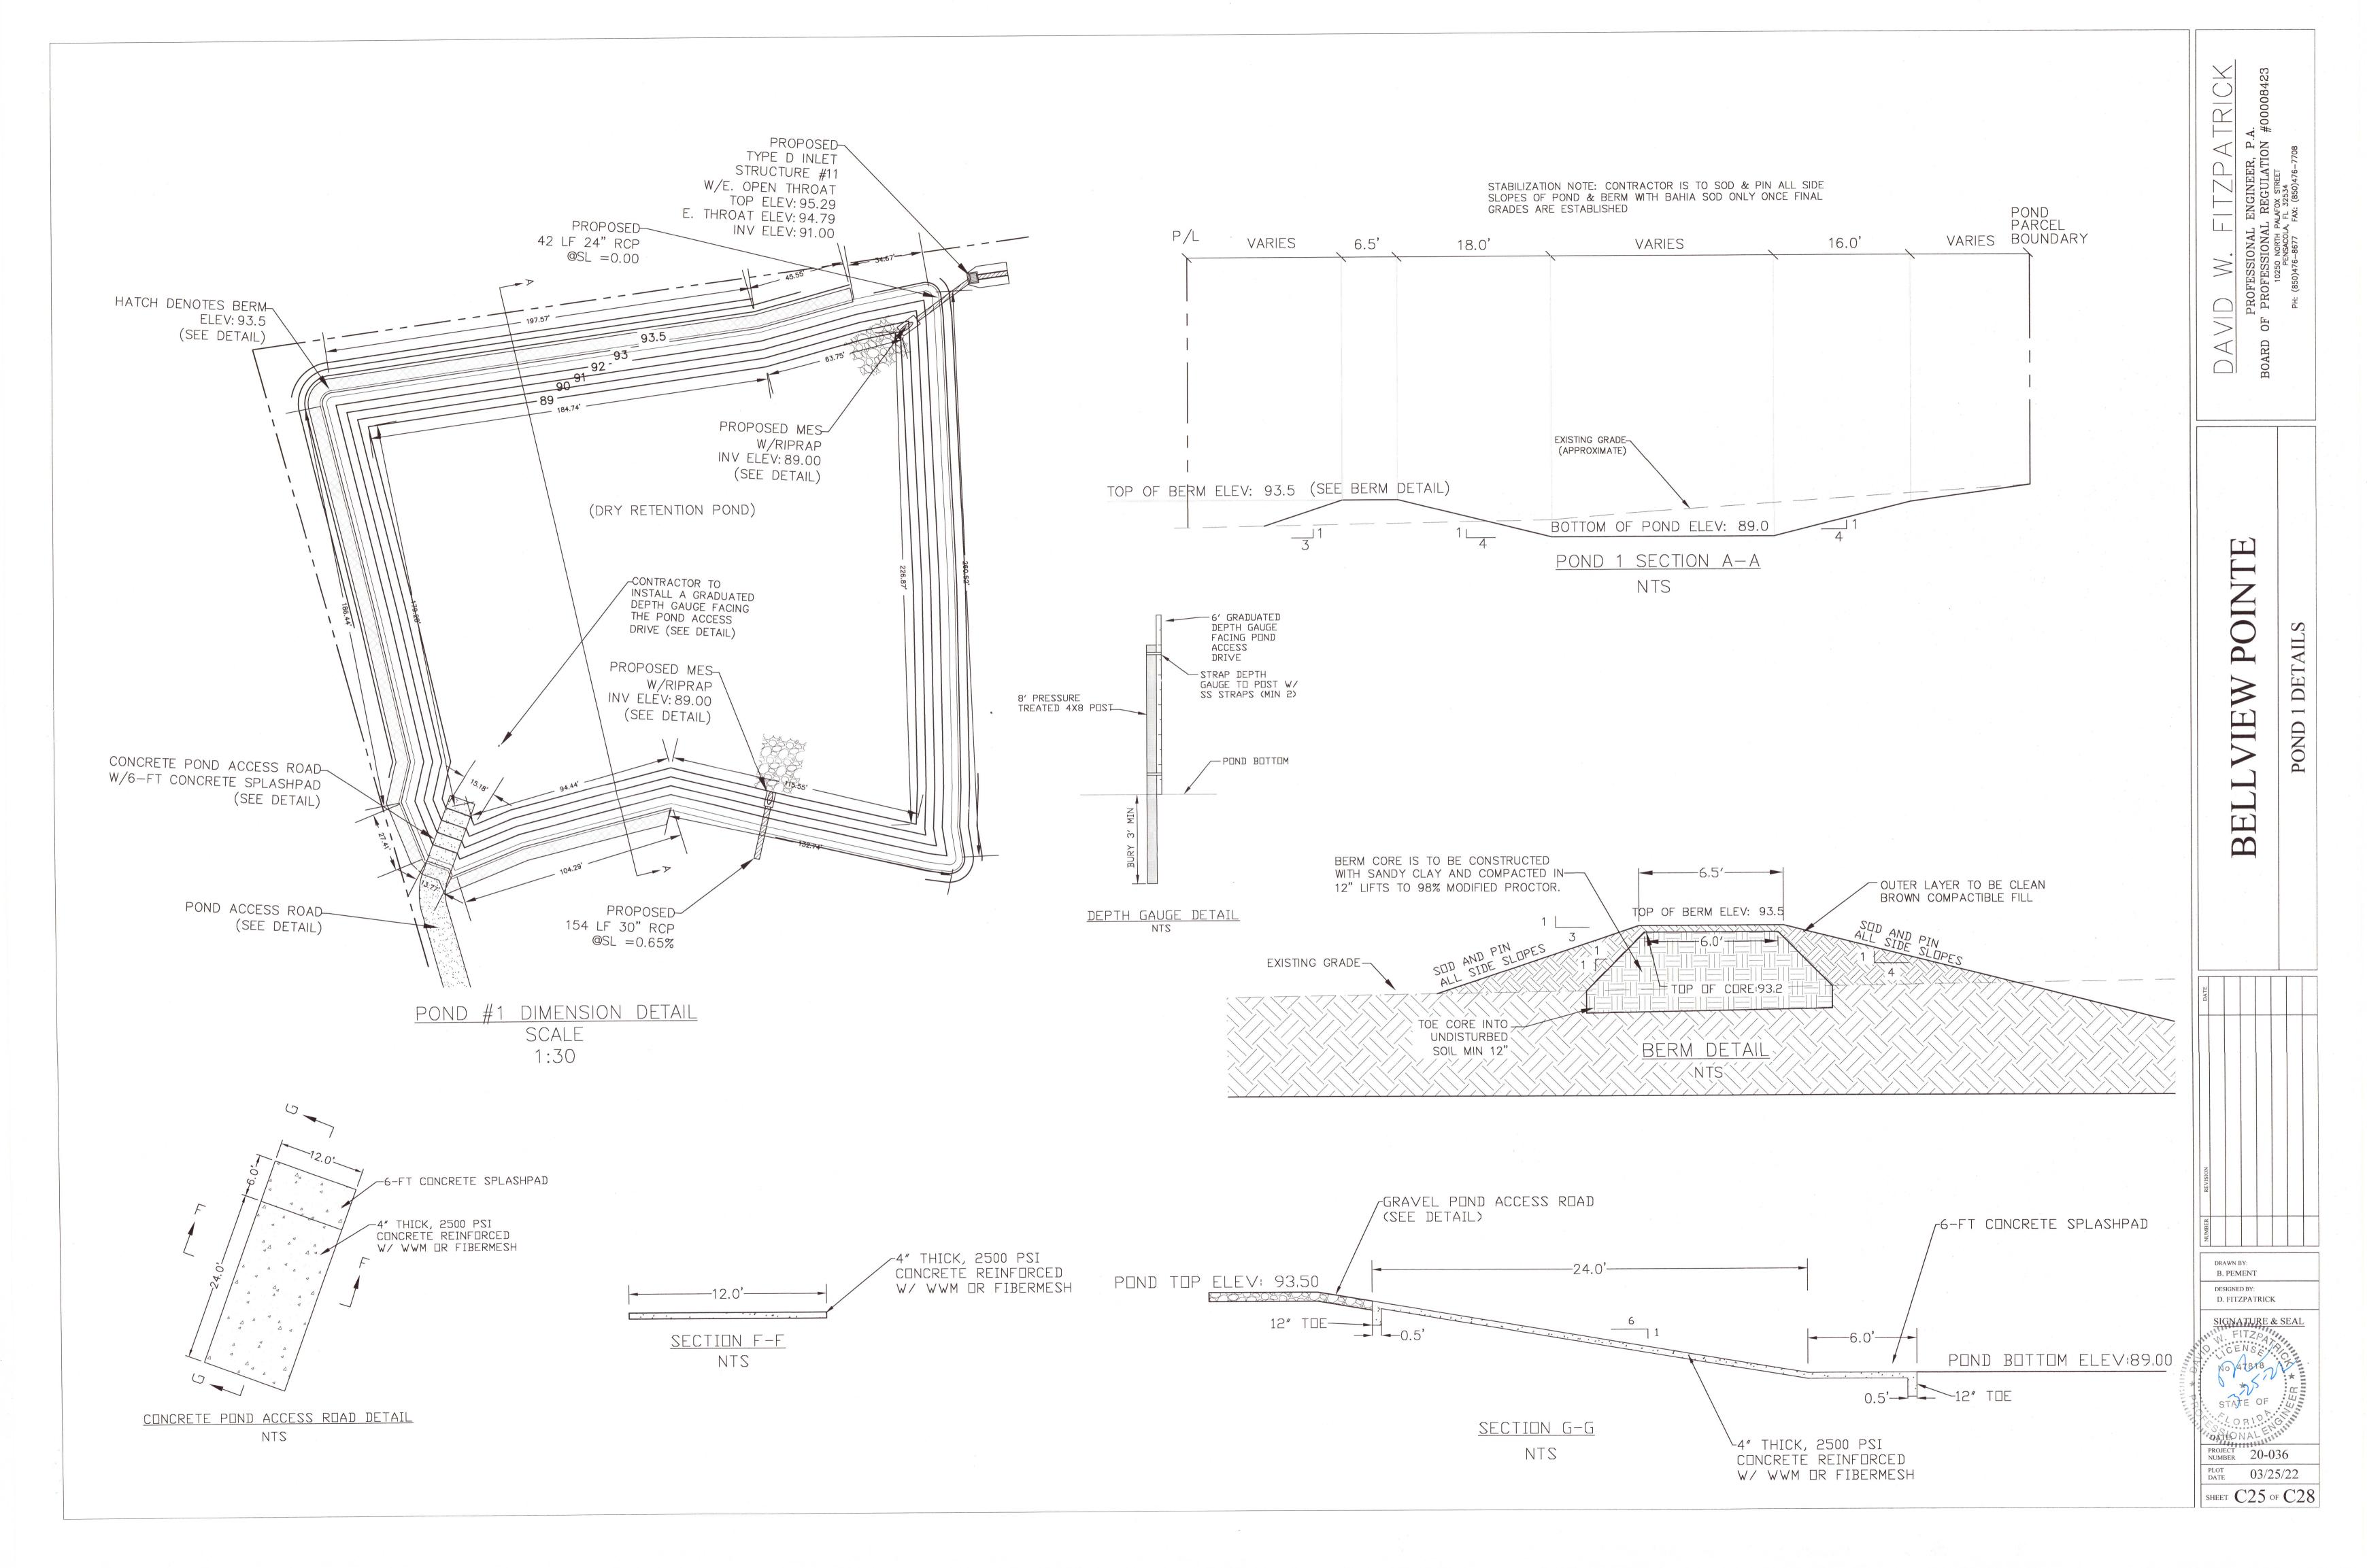

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DRAWN BY:

B. PEMENT

DESIGNED BY:

D. FITZPATRICK

SIGNATURE & SEA

T. 10 47818


STAPE OF

CORIDA

PROJECT 20-036

03/25/22

SHEET C27 OF C28

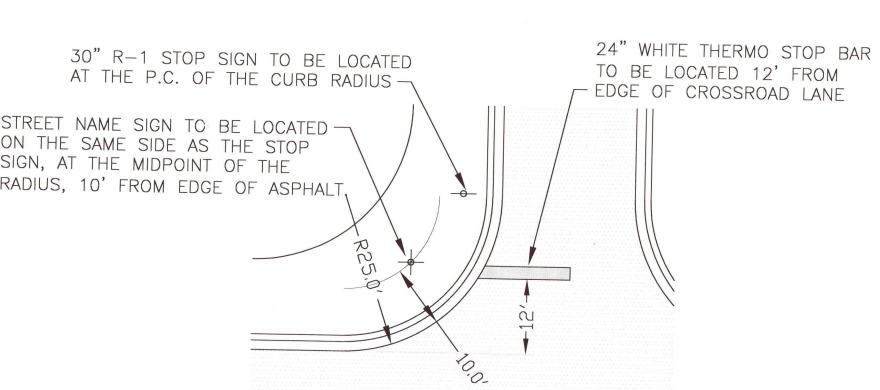



12" COMPACTED SUBGRADE— 98% MODIFIED PROCTOR

POND ACCESS DRIVEWAY DETAIL

§pice spice

REQUIRED ITEMS FOR STREET NAME SIGN INSTALLATION SIGN BLADE - .880" ALODEZED ALUMENUM CORNERS ROUNDED (1/2" RADIUS) FREE OF SHARP EDGES

37.6"X37" BLIND RIVETS (ENDS OF SIGN BLADES WILL BE RIVETED TO GETHER) (4 REQUIRED PER INSTALLATION) 38" STEEL DRIVE RIVETS ("SOUTHCO" 3878 OR EQUIVALENT 62 REQUIRED DRIVE NEXTALLATION.

1/2" CORNER RADIUS (TYPICAL)

(8 REQUIRED PER INSTALLATION)
TELSPAR SIGN POST SYSTEM (GALVANIZED) OR

EQUIVALENT (COMPRISED OF PARTS 5a AND 5b) a) 1 3/4"X 1 3/4"X 10" - 14 GAUGE TELESCOPING TOP POST 2"X 2"X 36" - 12 GAUGE SQUARE FIT ANCHOR POST

ALUMINUM PYRAMID RAINCAP (ARC 17# OR EQUIVALENT)

5/16"X 2 1/4" CORNER BOLT

STANDARD DETAILS FOR INSTALLATION AND LOCATION OF STREET NAME SIGNS

STANDARD DETAILS FOR STREET NAME SIGN BLADE LAYOUT

*STREET NAME SIGN BLADES TO HAVE WHITE LEGENDS, 1/2" WHITE BORDERS AND GREEN BACKGROUND.

*PRIMARY LETTERING TO SERIES B.6" UPPER CASE AND 4 1/2" LOWER CASE.

*PREFIX AND SUFFIX LETTERING TO BE SERIES C, 2 1/2" UPPER CASE AND 1 3/4" LOWER CASE.

ESCAMBIA COUNTY STANDARD DETAILS
FOR STREET NAME SIGNS

DEPARTMENT OF ENGINEERING - TRAFFIC ENGINEERING DIVISION Suite 1, 1190 West Leonard Street, Pensacola, Florida 32501-1116

BY: Alian Thedford, Engineering Technician III Revised 6-2002 * NOT TO SCALE *

*F.D.O.T. TYPE III-A REFLECTIVE SHEETING TO BE USED ON ALL STREET NAME SIGN BLADES.

— 18" MINIMUM OVERALL LENGTH FOR SIGN BLADES — MARGINS TO BE 1" MINIMUM (TYPICAL)

FILTER FABRIC

INSTALL STREET NAME SIGNS ON CORNERS OF INTERSECTION SO THAT THEY WILL BE ON THE FAR

STREET IN ACCORDANCE WITH M.U.T.C.D. SECTION 2D.38

INSTALL SECTION 2D.38

INSTALL SERET NAME SIGN POST AT MID RADIUS, 10 OFF EDGE OF ROAD.

MAJOR ROAL

PLAQUES TO
BE 9" BLADES
ANCHOR POST
4" MAXIMUM
ABOVE
FIVENHED
CRADE

11/4"

2 1/2"

2 1/2"

± 1 1/4"

RIGHT SIDE OF THE INTERSECTION TRAFFIC ON THE MAJOR

"DEAD END" (W14-1P) OR "NO

STREET NAME SIGNS BENEATH STREET NAME SIGN BLADES IN ACCORDANCE WITH M.U.T.C.D. SECTION 2C.46.


7'6" MINIMUM VERTICAL


OUTLET" (W14-2P) PLAQUES MAY BE CO-MOUNTED TO

6" THICK GAB DRIVE W/ MAX 1:6


MODIFIED PROCTOR (MIN LBR 40)


SLOPE COMPACTED TO 98%

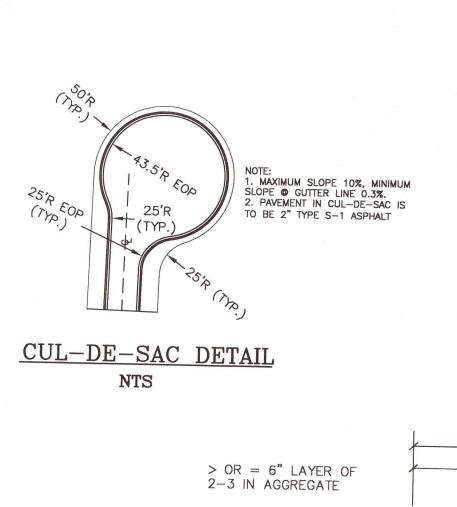


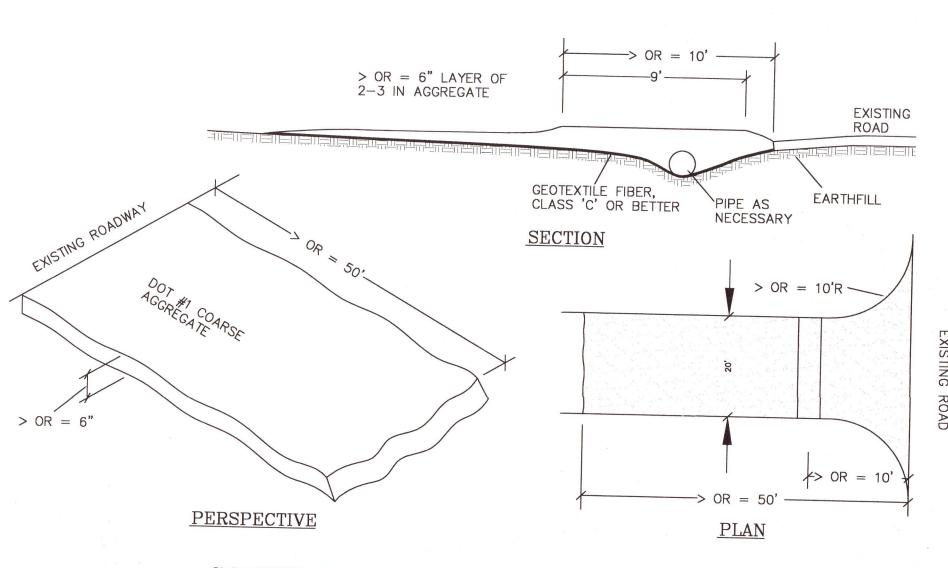




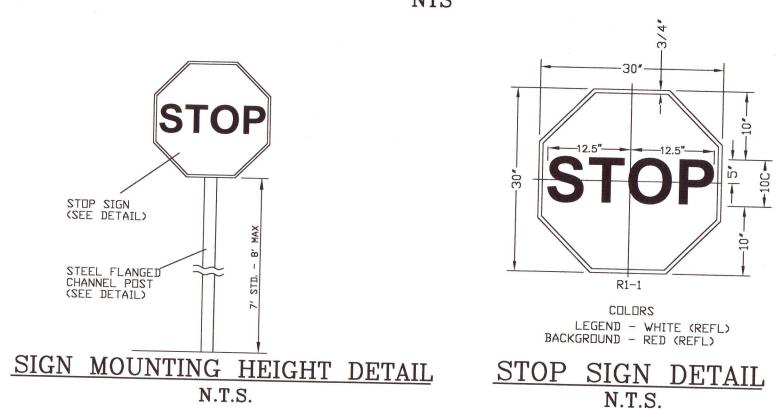

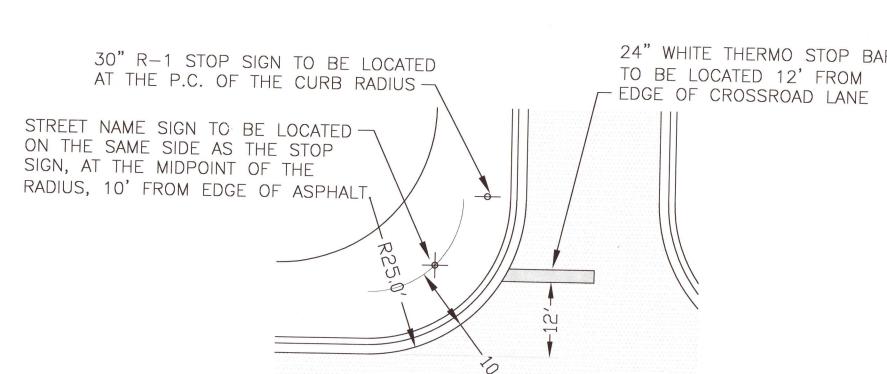

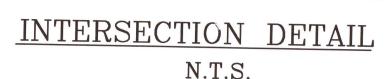

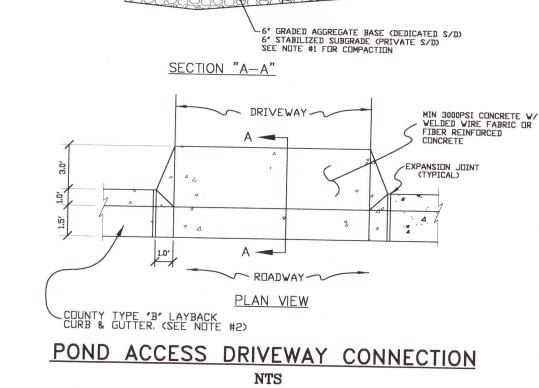

1. DRIVEWAY SECTIONS ABUTTING CURB OR CURB CUT SHALL BE 6" CONCRETE WITH 6" STABILIZED SUBGRADE AND 4" TO 6" CONCRETE DRIVEWAY WITH 4" STABILIZED SUBGRADE ~ 95% COMPACTION

2. FOR OTHER TYPE CURBS, DIMENSIONS MAY BE ADJUSTED TO FIT. IF NECESSARY, REFER TO F.D.O.T. INDEX DETAILS.

3. DRIVEWAYS WITHIN PROPERTY BOUNDARY SHALL PROVIDE A MINIMUM OF 2 PARKING SPACES.

4. TYPICAL DRIVEWAY SECTIONS ARE TO BE 12' WIDE MINIMUM.

W + 1.0' - SURFACE REPLACEMENT

ROAD PATCH WORK BACKFILL (SUBBASE) MATERIAL SHALL BE PLACED IN NOT MORE THAN 8" LIFTS. EACH LAYER TO BE

2. GRADED AGGREGATE BASE SHALL BE COMPACTED TO A MINIMUM 98% MODIFIED PROCTOR. CONCRETE SHALL BE A

3 ROAD CUTS SHALL BE MECHANICALLY SAW CUT TO FORM A SURFACE PAVEMENT JOINT AND TACK COATED ALONG THE FACE OF CUT JOINTS PRIOR TO ASPHALT PLACEMENT.

4. LONGITUDINAL ROAD CUTS OF LESS THAN ONE-HALF PAVEMENT WIDTH TO BE PATCHED SAME AS LATERAL PATCH.
LONGITUDINAL ROAD CUTS ONE-HALF OR GREATER TO BE PATCHED WITH SAME BASE MATERIAL AND ENTIRE ROAD

5. TOP WIDTH OF DITCH (W-DITCH) IS TO BE DETERMINED BY OSHA LAYBACK SLOPE REQUIREMENTS FOR DEPTH OF CUT. CONCRETE PATCH DETAIL

> (FOR PATCHES LESS THAN 24" WIDE) (ALL NOTES APPPLY, SEE ABOVE) **NOT TO SCALE**

1. GRAVEL DRIVEWAYS IMPACTED WILL BE RESTORED TO EXISTING OR BETTER CONDITION 2. SUB BASE MATERIAL SHALL BE PLACED IN NOT MORE THAN 8" LIFTS. EACH LAYER TO BE TAMPED TO A MINIMUM OF 40 LBR.

GRAVEL PATCH DETAIL

FOR PATCHES 24" WIDE OR GREATER

NOT TO SCALE

DIRT ROAD PATCH WORK SUB BASE MATERIAL SHALL BE PLACED IN NOT MORE THAN 8" LIFTS, EACH LAYER TO BE TAMPED TO A MINIMUM OF 40 LBR.

ROAD CUTS SHALL BE MECHANICALLY SAW CUT TO FORM A SURFACE PAVEMENT JOINT AND TACK COATED ALONG THE FACE OF CUT JOINTS PRIOR TO ASPHALT PLACEMENT.

4. LONGITUDINAL ROAD CUTS THAT AFFECT ONE TRAVEL LANE SHALL REQUIRE MILLING AND REPAYING OF THE AFFECTED TRAVEL LANE 5.0' BEYOND THE CUT AND PATCHED WITH THE SAME BASE MATERIAL LONGITUDINAL ROAD CUTS THAT AFFECT BOTH TRAVEL LANES SHALL REQUIRE MILLING AND REPAYING OF THE ENTIRE ROADWAY 5.0' BEYOND THE CUT AND PATCHED WITH THE SAME BASE MATERIAL.

-1½" SP 12.5 (TYP)

UNDERGROUND POWER

NOTE: ALL UTILITIES WITHIN THE

RIGHT OF WAY SHALL HAVE A MIN.

COVER OF 30 INCHES FROM

FINISHED GRADE.

UNDERGROUND TELEPHONE CABLE

UNDERGROUND TELEVISION CABLE

10-FT. 1.5' SURFACE REPLACEMENT

EXISTING ROAD

SEE NOTE 1 BELOW -

TAMPED TO A MINIMUM OF 40 LBR.

SUBBASE MATERIAL SHALL BE PLACED IN NO MORE THAN 8" LIFTS, EACH LAYER TO BE-COMPACTED TO A MINIMUM OF 40 LBR

2. GRADED AGGREGATE BASE SHALL BE COMPACTED TO A MIN LBR 100.

EXISTING ASPHALT 10-FT. 1.5' SURFACE REPLACEMENT CONCRETE (TYP)


8" MIN — GRADED AGGREGATE BASE OR TYPE "B 12.5" — FULL DEPTH ASPHALT BASE SEE NOTE 2 EBLOW

EXISTING ROAD BASE (


TYP. BOTH SIDES)

(MODIFIED PROCTOR) WITH LBR 40 BETWEEN EDGE OF ROADWAY AND

CURB JOINT NOTE:
CONTRACTION JOINTS SHALL BE CONSTRUCTED EVERY TEN (10) FEET BUT NO SECTION SHALL BE LESS THAN FOUR (4) FEET LONG. STEEL TEMPLATES SHALL BE USED FOR THESE JOINTS AND WITHDRAWN AFTER THE INITIAL SET. AT INTERVALS NOT TO EXCEED FIFTY (50) FEET AND AT ALL STRUCTURES AND INLETS AND AT ALL RADIUS POINTS, A ONE-HALF (1) INCH FULL-DEPTH EXPANSION JOINT SHALL BE CONSTRUCTED OF AN APPROVED MATERIAL. EXPANSION JOINTS SHALL BE CONSTRUCTED WITH PREFORMED EXPANSION JOINT MATERIALS CUT AND SHAPED TO THE CROSS-SECTION OF THE CURB.

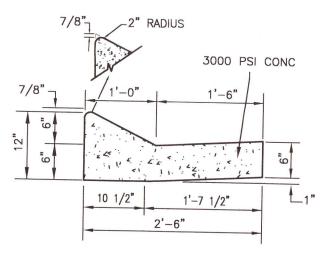

LAYBACK CURB & GUTTER

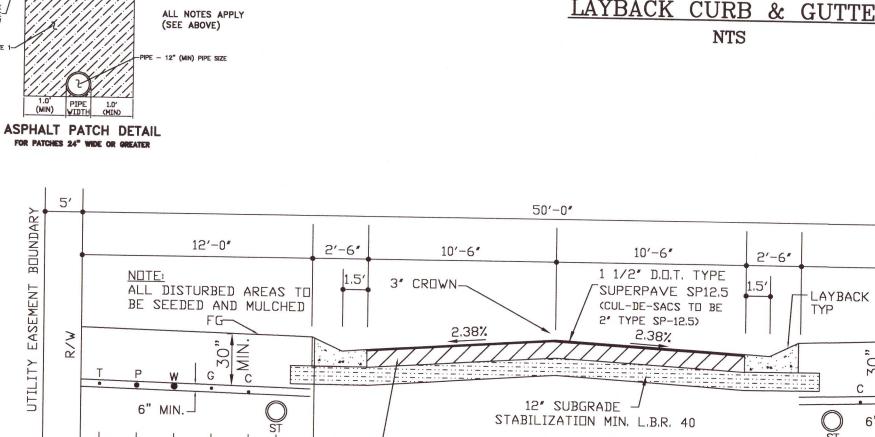


MINIMUM SOIL DENSITY OF 98% OF THE MODIFIED

OF THE MODIFIED PROCTOR TEST (ASTM D 1557).

SOURCE MAY BE USED INSTEAD OF GAB.

PROCTOR TEST (ASTM D1557);

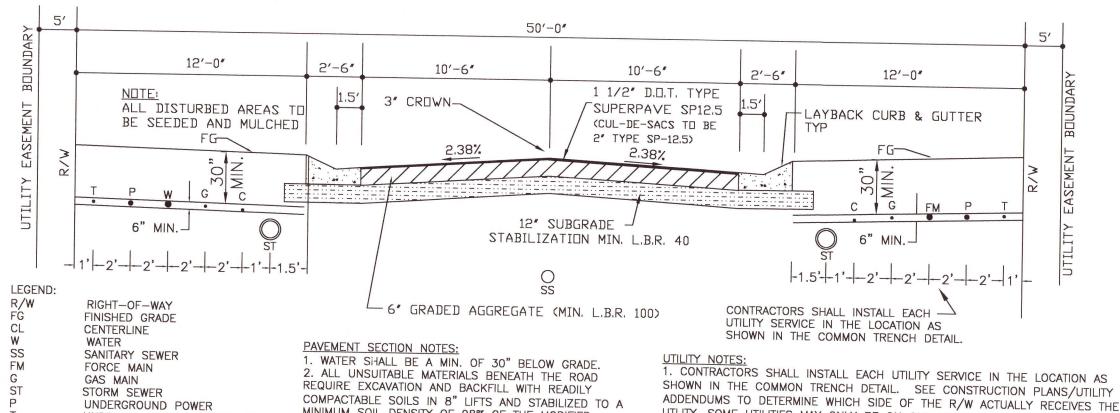

SHOWN IN THE COMMON TRENCH DETAIL. SEE CONSTRUCTION PLANS/UTILITY ADDENDUMS TO DETERMINE WHICH SIDE OF THE R/W ACTUALLY RECEIVES THE UTLITY. SOME UTILITIES MAY ONLY BE ON ONE SIDE OF THE ROAD (I.E. WATER & FORCE MAIN). . ALL PROPOSED UNDERGROUND UTILITIES WITHIN THE RIGHT-OF-WAY SHALL 3. 6" BASE REQUIRES A MINIMUM SOIL DENSITY OF 98% BE INSTALLED PRIOR TO PAVING. NO STREETS UNDER THE TWO YEAR WARRANTY WILL BE ALLOWED TO BE OPEN-CUT OR JACK AND BORED. TO . 12" SUBGRADE REQUIRES A MINIMUM SOIL DENSITY OF ACCOMPLISH THIS REQUIREMENT, COMMON TRENCHING IS REQUIRED. COMMON 98% OF THE MODIFIED PROCTOR TEST (ASTM D 1557) TRENCHING SHALL NOT TAKE PLACE UNTIL ALL ROW ROUGH GRADES HAVE BEEN ESTABLISHED TO ENSURE PROPER UTILITY DEPTHS. IF COMMON TRENCHING IS NOT A FEASIBLE OPTION, THE DEVELOPER SHALL INSTALL CONDUIT FOR THE . CRUSHED LIMEROCK BASE FROM AN FDOT APPROVED 6. ANY GAB MATERIAL SUBSTITUTION HAS TO GO THROUGH
A SPECIAL APPROVAL BY THE COUNTY PROCESS.
7. CRUSHED CONCRETE IS NOT AN ALLOWABLE BASE
MATERIAL IN ESCAMBIA COUNTY FOR NEW SUBDIVISIONS UTILITY NOT PARTICIPATING IN THE COMMON TRENCHING FOR ALL ROAD CROSSINGS AND THE UTILITY COMPANY WILL BE REQUIRED TO USE THE CONDUIT. THIS SHALL REQUIRE PLANNING BETWEEN THE DEVELOPER AND THE

NO OUTLET SIGN DETAIL N.T.S.

COMMON TRENCH DETAIL/ROAD CROSS SECTION NOT TO SCALE

03/25/22


SHEET C28 OF C28

PLOT DATE


STATE OF PROJECT ON 100 PROJECT NUMBER 11120-036

-5'-6**"**(TYP,)-----**→** B 4" CONCRETE COLUMN(TYP.) EXPANSION JOINT -EACH SIDE (TYP.)


TYPE DOUBLE 'A' DROP INLET DETAIL

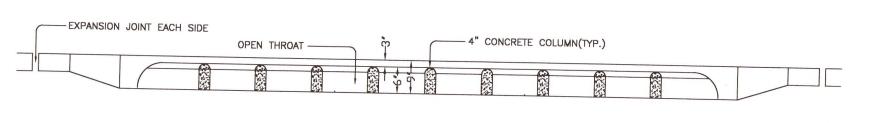



TYPE DOUBLE 'A' THROAT ELEVATION

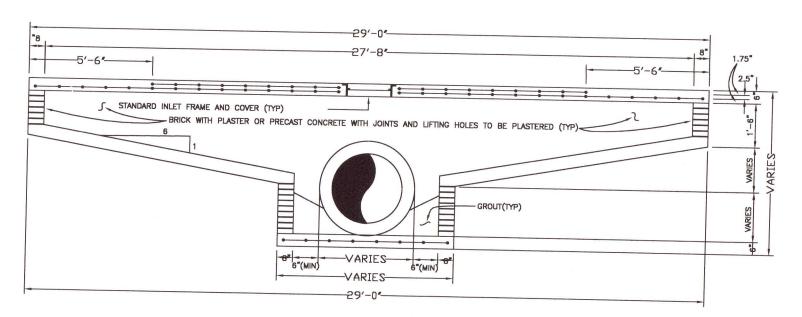



SECTION "E-E"

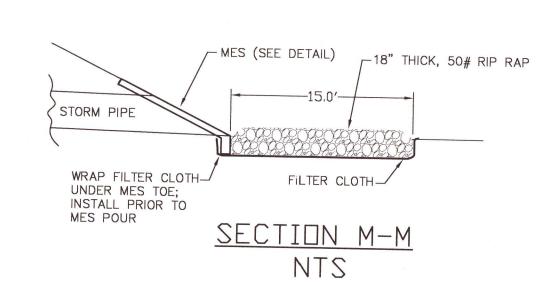


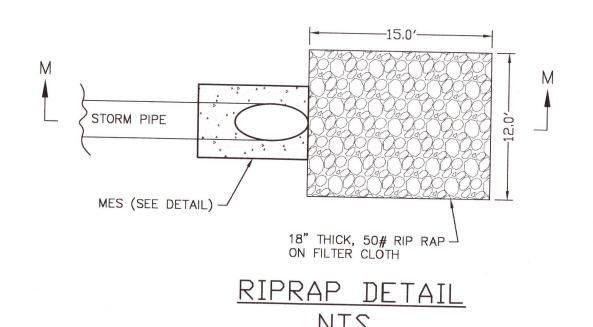


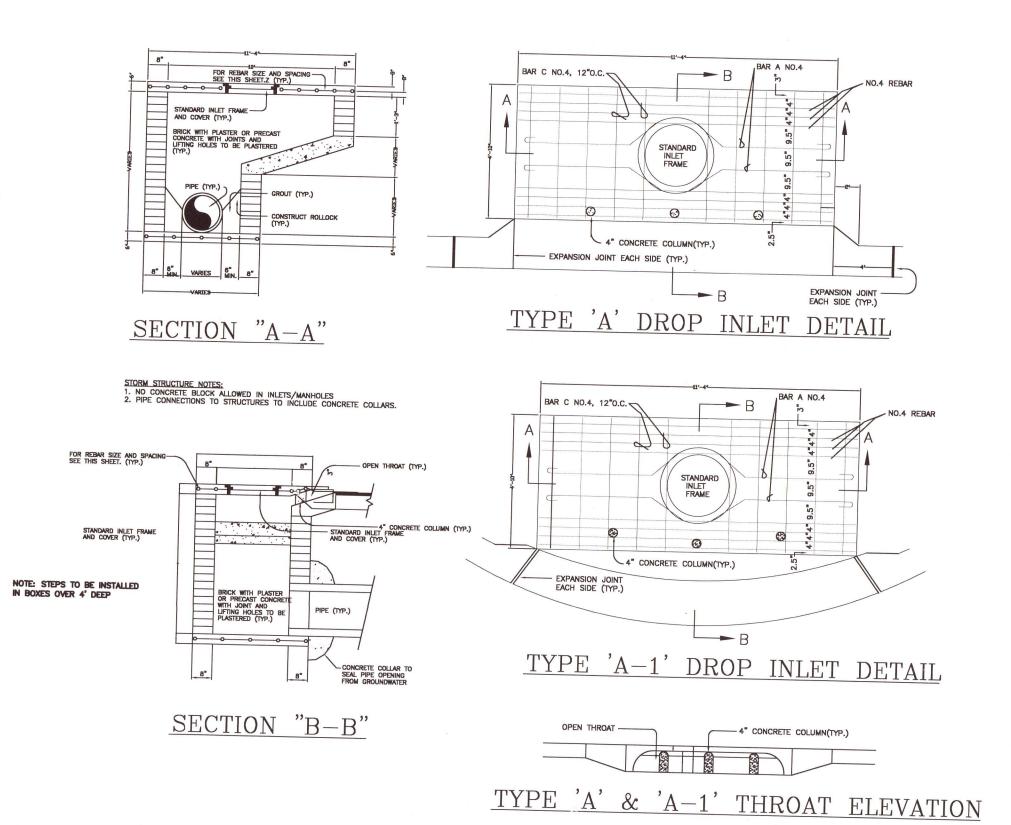

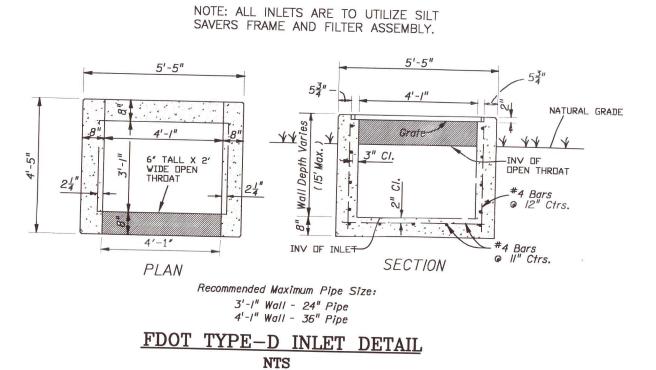

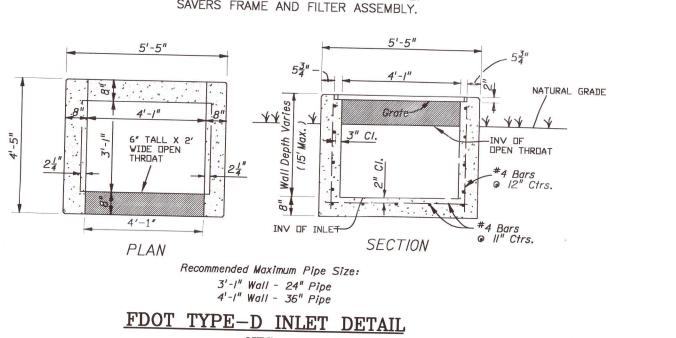

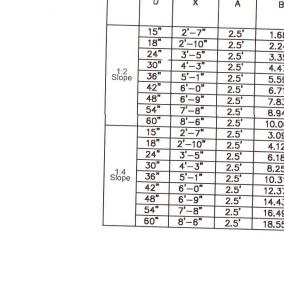

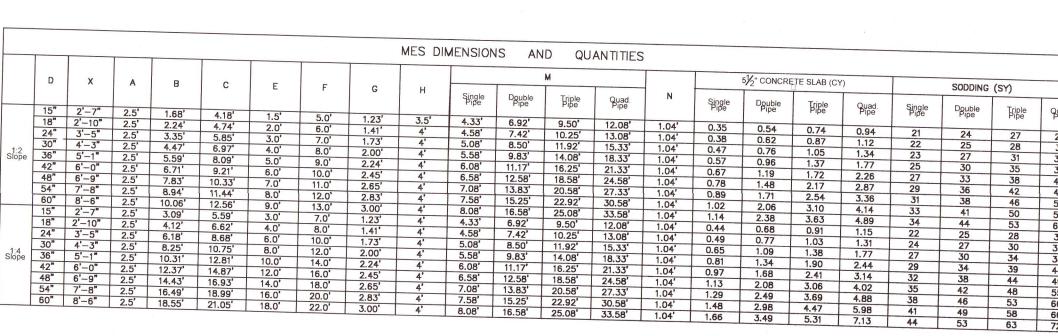

STANDARD JUNCTION BOX

MANHOLE SHALL CONFORM TO A.S.T.M. C 478 SPECIFICATIONS.
 DIAMETER OF OPENING FOR PIPE SHALL BE 1" LARGER DIAMETER THAN BELL OF THE PIPE BEING USED.

JOINTING COMPOUND SHALL BE RAM NECK, TYPE 1, ROPE FORM PLASTIC GASKET OR EQUAL.

ALL PATCHING TO BE DONE WITH HYDRAULIC CEMENT. NO MORTAR REPAIRS PERMITTED.

PERMITTED.

5. CONCRETE TO BE 2500 P.S.I., REINFORCING STEEL TO BE A.S.T.M.
A 615 GRADE 60.

6. FRAME AND COVER SHALL BE VULCAN 1337—2 (ASTM SPEC. A—48, CLASS 30 CAST IRON) OR APPROVED EQUAL. REFER TO SPECIFICATIONS

7. CONTRACTOR IS CAUTIONED TO DETERMINE IF A 4' DIAMETER MANHOLE IS LARGE ENOUGH TO CONTAIN SOME OF THE LARGER PIPES OR CONFIGURATIONS. IT MAY BE NECESSARY TO PROVIDE A LARGER DIAMETER JUNCTION BOXE. RECTANGULAR JUNCTION BOXES ARE ACCEPTABLE PROVIDED THEY MEET ESCAMBIA COUNTY REQUIREMENTS AND FDOT SPEC.

8. NO CONCRETE BLOCK ALLOWED IN INLETS/MANHOLES

9. PIPE CONNECTIONS TO STRUCTURES TO INCLUDE CONCRETE COLLARS.

Ditch Grade -

STANDARD FRAME & COVER-


USE 4", 6" OR 8" GRADE RINGS TO BRING TO GRADE: — 12" MIN. — 18" MAXIMUM OPTIONAL IN UNIMPROVED ROADS.

SEAL ALL LIFT HOLES -


NOTE: STEPS TO BE INSTALLED IN BOXES OVER 4' DEEP

JUNCTION BOX NOTES:


FDOT MES DETAIL NTS

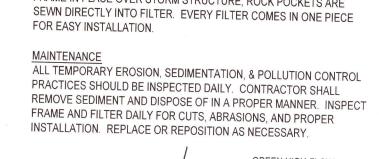

FILTER INSTALLATION
FILTER SLIDES DIRECTLY OVER FILTER FRAME. TO KEEP FILTER
FRAME IN PLACE OVER STORM STRUCTURE, ROCK POCKETS ARE

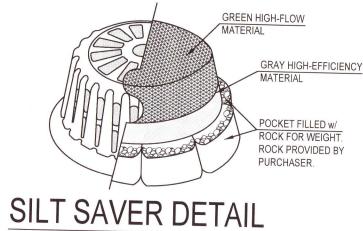

SHOWN WITH DOT FILTER

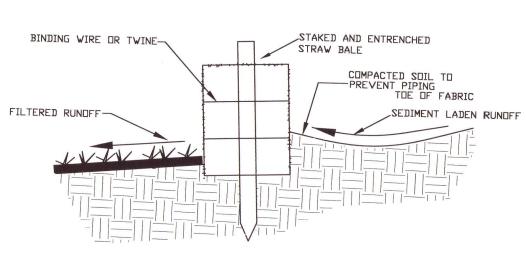


F (Pipe To Be Included Under Unit

SECTION

NOTE: MES SHALL NOT BE CONSTRUCTED OF PVC (A2000) OR HDPE (ADS) PIPE. USE ONLY CONCRETE OR METAL MITERED END SECTIONS AS INDICATED IN FDOT STANDARD SPECIFICATIONS 430-4.6. WHEN USE IN CONJUNCTION WITH CORRUGATED MES, CONNECTION SHALL BE BY EITHER A FORMED METAL BAND SPECIFICALLY DESIGNED TO JOIN HDPE OR PVC PIPE. WHEN USED IN CONJUNCTION WITH A CONCRETE MES, CONNECTION SHALL BE BY CONCRETE JACKET CONSTRUCTED IN ACCORDANCE WITH FDOT DESIGN STANDARD INDEX NO 280.

DETAIL OF PROPERLY INSTALLED STRAW BALE

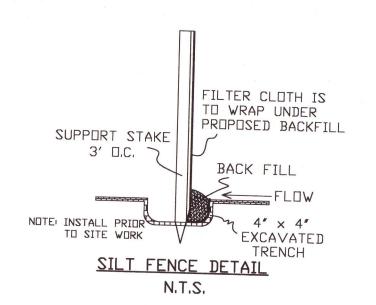

Reinforced With WWF 6x6-WI.4xWI.4

TOP VIEW

Sod O