

CIVIL SITE PLANS FOR

# FIRST CHURCH OF CHRIST SCIENTIST PARKING LOT EXPANSION

5994 WEST NINE MILE ROAD  
PENSACOLA, FLORIDA 32526


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C1 - EXISTING SITE, DEMOLITION & EROSION CONTROL PLAN  
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C3 - GRADING PLAN  
C4 - LANDSCAPE PLAN  
C5 - CONSTRUCTION DETAILS

OWNER INFORMATION/DEVLOPER

OWNER: FIRST CHRUCH OF CHRIST SCIENTIST  
5994 WEST NINE MILE ROAD  
PENSACOLA, FLORIDA 32526  
850-607-9605

PROPERTY REFERENCE #: 06-1S-31-4201-112-004  
ZONING DESIGNATION: LDR  
FLUM CATEGORY: MU-S

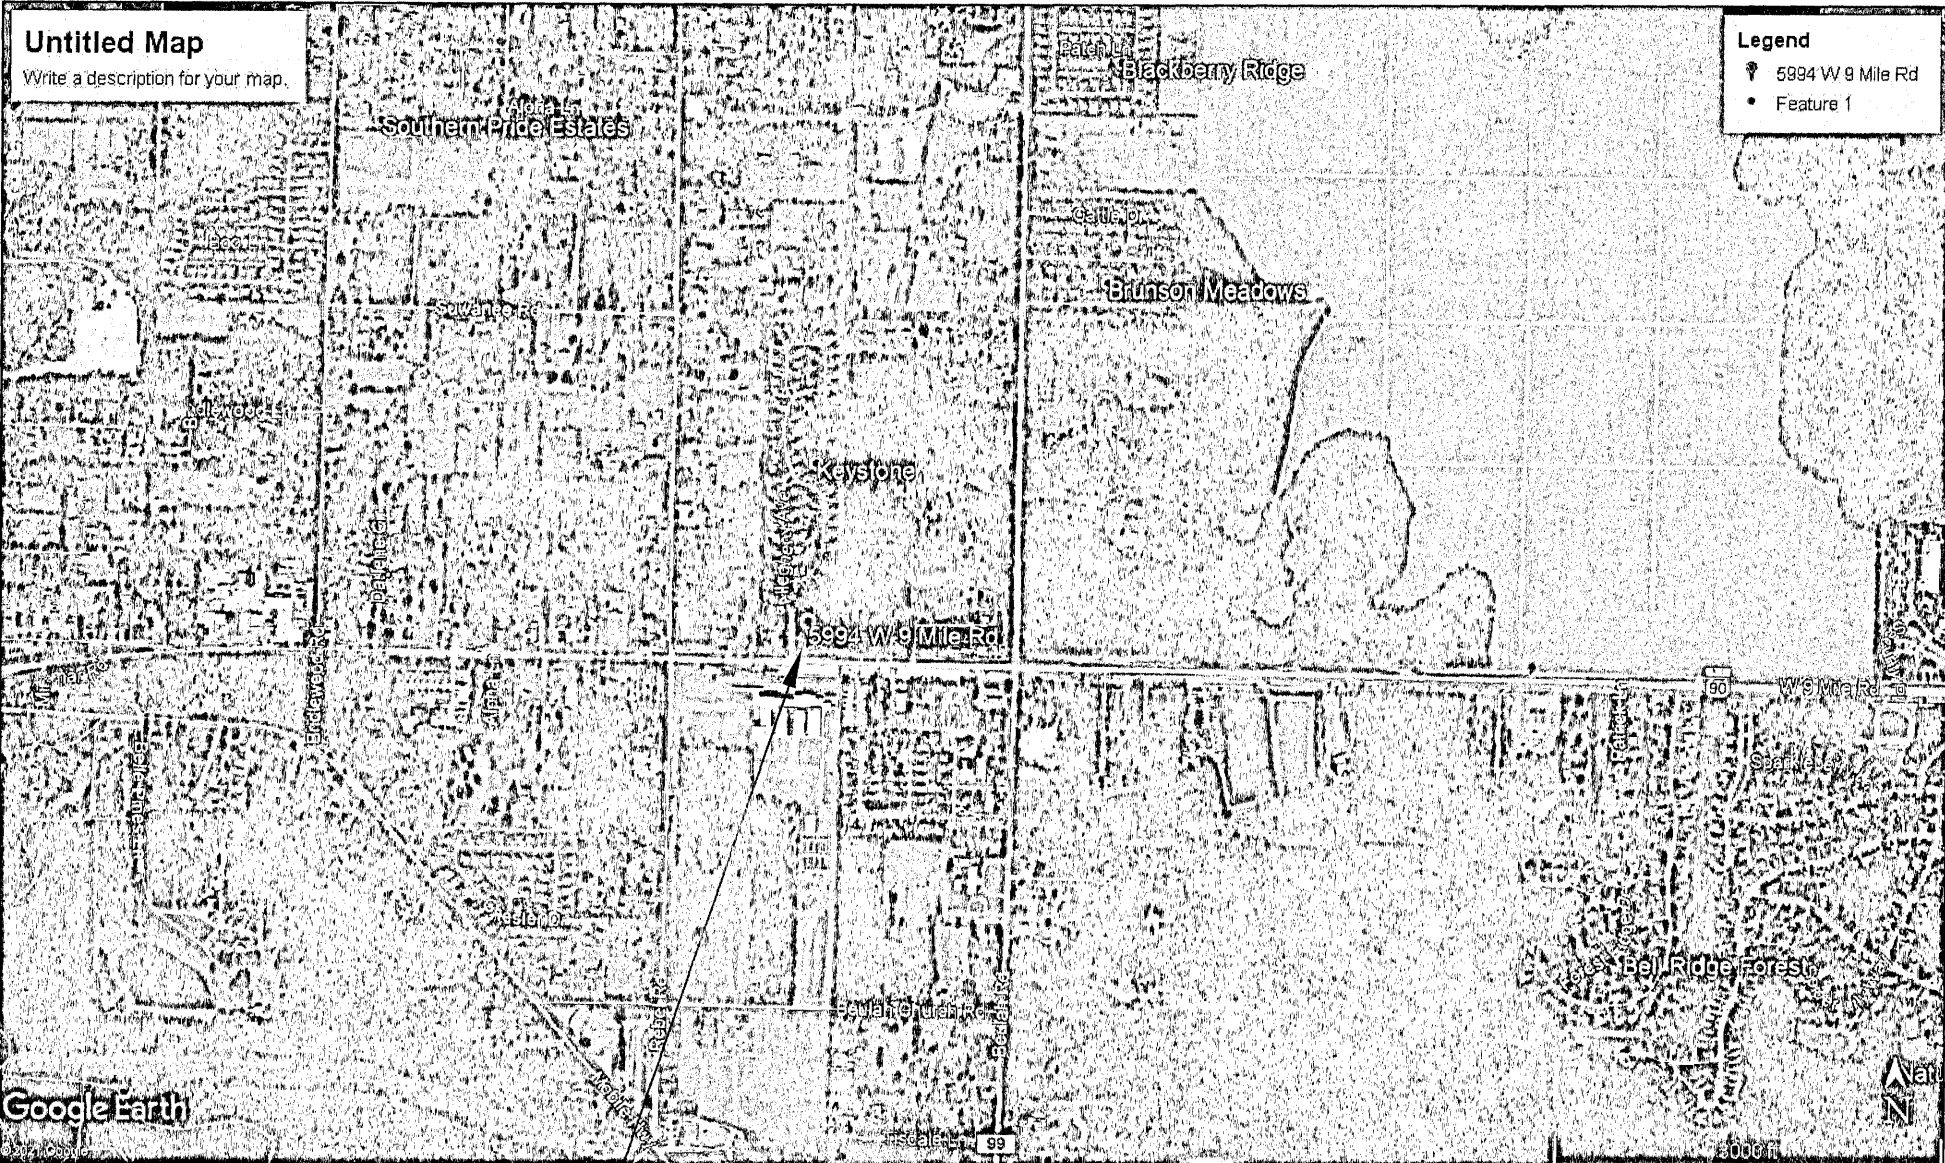

PROJECT LOCATION

VICINITY MAP  
SCALE: 1"=0.50 MILE



GENERAL NOTES

- All work shall comply with these specifications and applicable standards established by Escambia County. Where these Specifications and the County Standards deviate, the more stringent requirements shall prevail unless approved otherwise by the engineer of record.
- The Contractor shall coordinate the work of the utility subcontractors to ensure that all utility installations proceed in a timely manner and to prevent conflicts in the installation of the water, sewer, electric power, and telephone lines.
- All conditions and stipulations of the construction permits and the approvals issued by the Escambia County and Florida Department of Transportation shall be complied with in every detail.
- This is not a survey, boundary information based upon a survey performed by NORTHWEST FLORIDA LAND SURVEING INC. (850-432-1052) Project #: 24176, dated 11-12-20.

GENERAL REQUIREMENTS GRADING AND DRAINAGE CONSTRUCTION

- All areas to be cut or filled shall be cleared and grubbed. All rights-of-ways, easements, and the retention pond areas are to be cleared & grubbed. Clearing and grubbing shall be as per Section 110 of the 2020 FDOT Standard Specifications for Roads and Bridges..
- All disturbed and/or exposed soil/dirt in the FDOT right-of-way shall be stabilized with bahia sod.
- The County, its officers, and employees shall be held harmless from any damage to persons or property which might result from work or activity undertaken by the developer and authorized by the County.
- THE ELEVATIONS AS SHOWN HEREON ARE REFERENCED TO NORTH AMERICAN VERTICAL DATUM OF 1988, FROM ESCAMBIA COUNTY GEODETIC CONTROL POINT STAMPED "ESC 4075" HAVING A PUBLISHED ELEVATION OF 109.05 FEET. BASED ON ESCAMBIA COUNTY, FLORIDA GPS NETWORK SURVEY PREFORMED BY BASKERVILLE DONOVAN, INC. DATED 10/15/97. SEE SHEETS C1 & C3 FOR BENCHMARK LOCATIONS.  
  
BENCHMARK DATA:  
  
BM-1 NAIL AND DISK LABELED REBOL/BATTLE  
ELEVATION= 125.68' (NAVD88)  
  
BM-2 NAIL AND DISK LABELED REBOL/BATTLE  
ELEVATION= 123.65' (NAVD88)

GENERAL REQUIREMENT OF GRADING AND DRAINAGE CONSTRUCTION (CONTINUED)

- The project engineer (engineer of record) shall provide to Escambia As-Built record drawings for verification and approval by Escambia County one week prior to requesting a certificate of occupancy, or provide "As-Built Certification" that the project construction adheres to the permitted plans and specifications. As-Built drawings shall include topo of pond verifying volume, outlet structure details, drainage structure modifications, and hydrology study on as-built data." The As-built Certification or the As-Built record drawings must be signed, sealed and dated by a registered Florida Professional Engineer.
- The contractor shall be responsible for installation of sediment control structures prior to the start of construction and maintenance/repairs during construction as required to retain all sediments and erosion on the site of development. Improper sediment control measures may result in Code Enforcement Violation.
- All disturbed areas which are not paved are to be stabilized per note 2 above.
- Contractor shall maintain record drawings during construction which show As-Built conditions of all work including piping, drainage structures, topo of pond, outlet structures, dimensions, etc. These record drawings are to be provided to the Project Engineer prior to requesting final inspection.
- No deviations or revisions from these plans by the contractor shall be allowed without prior approval from both the design engineer and the Escambia County Engineer.
- The contractor shall notify FDOT 48 hours in advance prior to initiating any work in the state rights-of-way.
- The contractor shall obtain a permit from the Escambia Road & Bridge Department and/or Florida Department of Transportation prior to commencing any work in the County or FDOT R/W .
- All aspects of the stormwater/drainage components and/or transportation components shall be completed prior to issuance of a final certificate of occupancy.
- The owner or his agent shall arrange/schedule with the County a final inspection of the development upon completion and any intermediate inspections at 850-595-3472. As-built certification is required prior to request for final inspection/approval.
- Any damage to existing roads during construction will be repaired by the developer prior to final "as-built" sign off from the county.

LAND DISTURBANCE ACTIVITIES

- All trees shall remain onsite and any proposed land clearing or land disturbance activities, including the placement of fill/fill materials, grading, excavating, etc. shall not occur until such time as appropriate permit(s) are issued for such site work.
- All land shall remain vegetated & in its natural state until such time as DRC Site Plan & any additional permitting approvals allow for such, per code. All tree removal, land clearing, placement of fill materials, or other Land Disturbing Activities, etc. shall be permitted or otherwise approved by the County prior to initiation.

Approved ESCAMBIA COUNTY DRC PLAN REVIEW	
DRC Chairman Signature: <i>[Signature]</i>	Date: <i>3/7/24</i>
Printed Name: <i>Jim Day</i>	
Development Services Director for DRC	
This document has been reviewed in accordance with the requirements of applicable Escambia County Regulations and Ordinances, and does not in any way relieve the submitting Architect, Engineer, Surveyor or other signatory from responsibility of details as drawn. A Development Order (DO) must be obtained through the Development Review Process prior to the commencement of construction. This DO approval does not constitute approval by any other agency. All additional state/federal permits shall be provided to the county prior to approval of a final plat or the issuance of state/federal permits shall be provided to the county prior to approval of a final plat or the issuance of a building permit.	

UTILITY CONSTRUCTION

- Location of existing utilities shown on plans are approximate only and it shall be the responsibility of the Contractor to verify the location before construction. Failure of the plans to show the existence of any underground utilities, structures, etc., shall not relieve the Contractor from the responsibility of locating, preserving and protecting said utility or structures.
- The Contractor shall notify the superintendents of the water, sewer, telephone and power companies 10 days in advance, that he intends to start work in a specific area. The owner disclaims any responsibility for the support and protection of sewers, drains, water pipes, gas pipes, conduits of any kind, utilities or other structures owned by the City, County, State or by private or public utilities legally occupying any street, alley, public place or right-of-way.
- Notify Sunshine utilities 96 hours in advance prior to digging within right-of-way at 1-800-432-4770.
- All work shall comply with applicable standards established by ECUA, Escambia County Health Department, Florida Department of Environmental Protection.


FLOOD STATEMENT:

THE PROPERTY AS SHOWN HEREON IS LOCATED IN FLOOD ZONE "X", OUTSIDE 0.2% ANNUAL CHANCE OF FLOOD, AS DETERMINED FROM FEDERAL EMERGENCY MANAGEMENT AGENCY FLOOD INSURANCE RATE MAP OF ESCAMBIA COUNTY, FLORIDA (UNINCORPORATED AREAS), MAP NUMBER 12033C 0270 G, REVISED COUNTY, FLORIDA, COMMUNITY 120080, FIRM MAP PANEL NUMBERS 12033C0270G, MAP REVISION DATED SEPTEMBER 29, 2006.

DESIGNED AND DRAWN BY  
ENVIRONMENTAL ENGINEERING SERVICES  
CERTIFICATE OF AUTHORIZATION #: 6515  
GREGORY ALLEN CAMPBELL P.E.  
FLORIDA LICENSE #: 38572  
  
2120 MARIA CIRCLE  
PENSACOLA, FL. 32514  
(850) 982-8606

1	ESCAMBIA COUNTY COMMENTS DATED 02-19-21	GAC	02-21-21
NO.	REVISIONS	BY	DATE
ENVIRONMENTAL ENGINEERING SERVICES CERTIFICATE OF AUTHORIZATION #: 6515 2120 MARIA CIRCLE PENSACOLA, FLORIDA 32514 850-982-8606 (OFC) 850-477-1176 (FAX) GREGORY ALLEN CAMPBELL, P.E. FL PE LICENSE #: 38572			
PROJECT TITLE: FIRST CHURCH OF CHRIST SCIENTIST PARKING LOT EXPANSION  5994 W NINE MILE ROAD PENSACOLA, FLORIDA ESCAMBIA COUNTY			
SHEET TITLE: TITLE SHEET AND GENERAL NOTES			
DATE: 02-03-21			
SCALE: N.T.S.			
SHEET NUMBER: T1			
SHEET 1 OF 6			



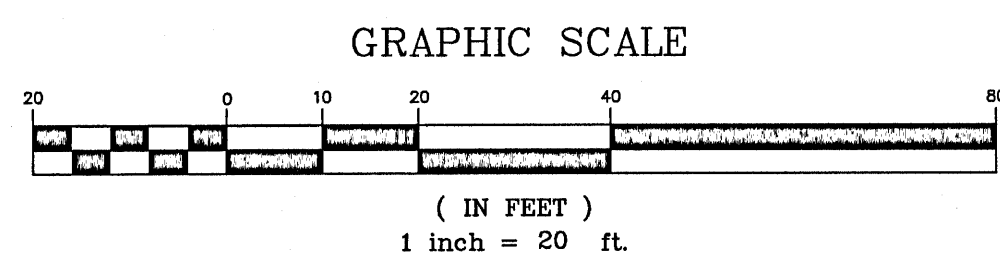







PARCEL H, KEYSTONE SUBDIVISION, ACCORDING TO THE PLAT THEREOF, RECORDED IN PLAT BOOK 18, PAGE(S) 43 THROUGH 43B, OF THE PUBLIC RECORDS OF ESCAMBA COUNTY, FLORIDA.

TOP= 124.48'  
N. INVERT= 116.27'  
S.E. INVERT= 116.30'  
S INVERT= 116.56'

ADDRESS: C/O REALITY MASTERS  
4400 BAYOU BLVD #583  
Pensacola, FL 32503

PROP REF #: 06-1S-31-4201-100-004  
CURRENT ZONING: LDR  
FLU: MU-S  
CURRENT USE: VACANT WOODED LOT

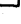(P) ~ PLATTED INFORMATION  
(F) ~ FIELD INFORMATION  
R/W ~ RIGHT OF WAY  
P.C. ~ POINT OF CURVATURE  
 ~ BENCHMARK  
 ~ POWER TRANSFORMER  
 ~ TELEPHONE PEDISTAL  
 ~ UTILITY POLE  
GAS ~ GAS PIPELINE MARKER  
 ~ WATER VALVE  
 ~ STORM DRAIN MANHOLE


 PROPOSED DEMOLITION

EXISTING GRAVEL

 EXISTING ASPHALT

PROPERTY LINE

T-2 EXISTING TREE & DESIGNATION NUMBER

 T15      EXISTING TREE TO BE REMOVED

## SILT FENCE

**SPECIAL LINES:**

— DE —	~	OVERHEAD ELECTRICAL
— SS —	~	SANITARY SEWER LINES
— W —	~	WATER SERVICE LINE
— FPO —	~	BURIED FIBER OPTIC CABLE
— GAS —	~	NATURAL GAS SERVICE LINE
— SW —	~	STORM WATER PIPE

BENCHMARK DATA:




BM~1 NAIL AND DISK LABELED REBOL/BATTLE  
ELEVATION= 125.68' (NAVD88)

BM~2 NAIL AND DISK LABELED REBOL/BATTLE  
ELEVATION= 123.65' (NAVD88)

NOTE: ALL EXISTING TREES ARE TO REMAIN.  
NO EXISTING TREES TO BE REMOVED.

PROP REF #: 06-1S-31-4201-105-004  
CURRENT ZONING: LDR  
FLU: MU-S  
CURRENT USE: VACANT WOODED LOT

<p><b>ENVIRONMENTAL ENGINEERING SERVICES</b>  <b>FIRM REGISTRATION #: RY6515</b>  <b>2120 MARIA CIRCLE</b>  <b>PENSACOLA, FLORIDA 32514</b>  <b>850-982-8606 (OFC)</b>  <b>850-477-1176 (FAX)</b>  <b>GREGORY ALLEN CAMPBELL, P.E.</b>  <b>FL PE LICENSE #: 38572</b></p>	<p><b>PROJECT TITLE:</b>          FIRST CHURCH OF CHRIST SCIENTIST          PARKING LOT EXPANSION</p>		<p><b>SHEET TITLE:</b>          EXISTING SITE, DEMOLITION &amp;          EROSION CONTROL PLAN</p>	<p><b>DATE:</b> 02-03-21</p>	<p><b>SCALE:</b> 1"=20'</p>	<p><b>SHEET NUMBER:</b>  <b>C1</b></p>	<p><b>SHEET 2 OF 6</b></p>	
	<p><b>5994 W NINE MILE ROAD</b>  <b>PENSACOLA, FLORIDA</b>  <b>ESCAMBIA COUNTY</b></p>			<p><b>DATE:</b> 02-21-21</p>	<p><b>BY:</b></p>	<p><b>REVISIONS</b></p>	<p><b>NO.</b></p>	

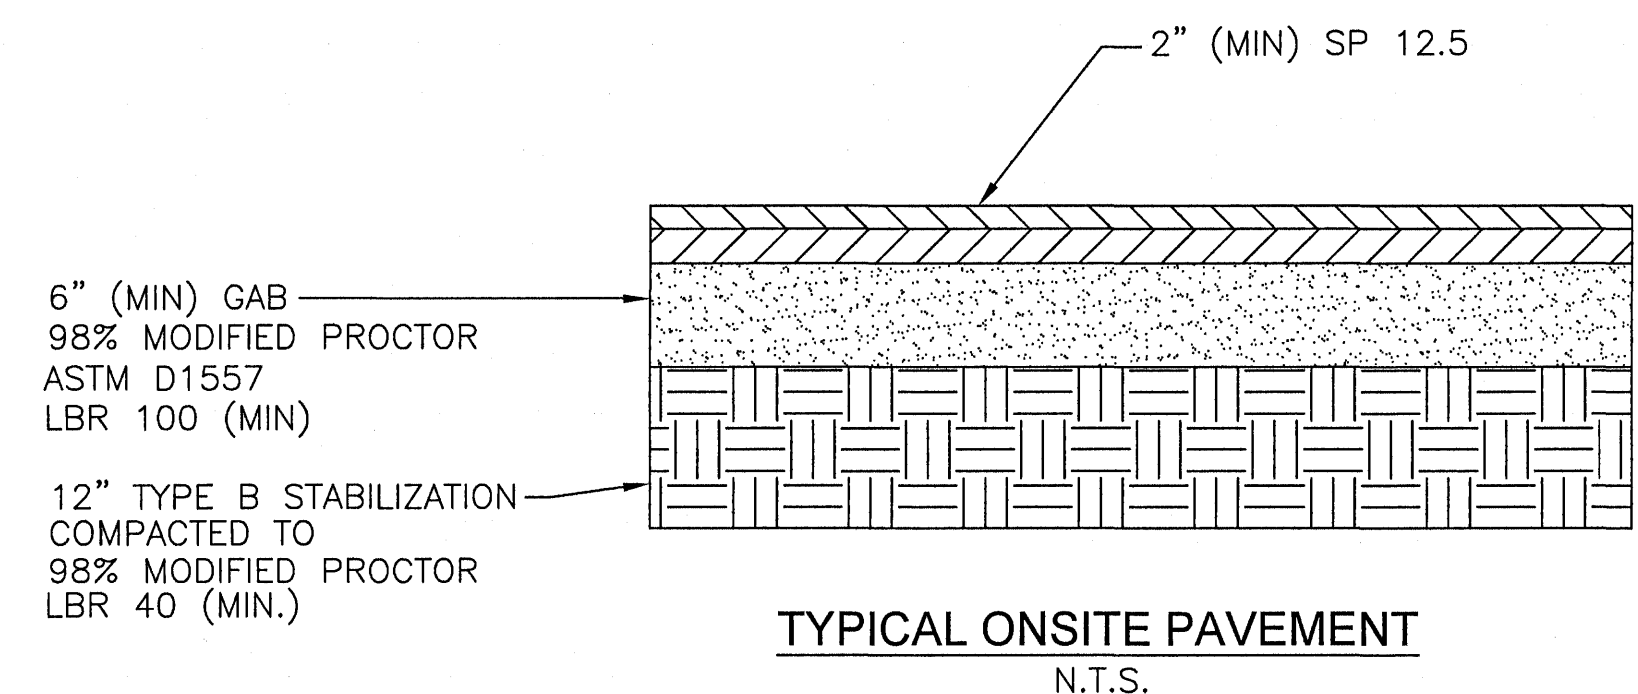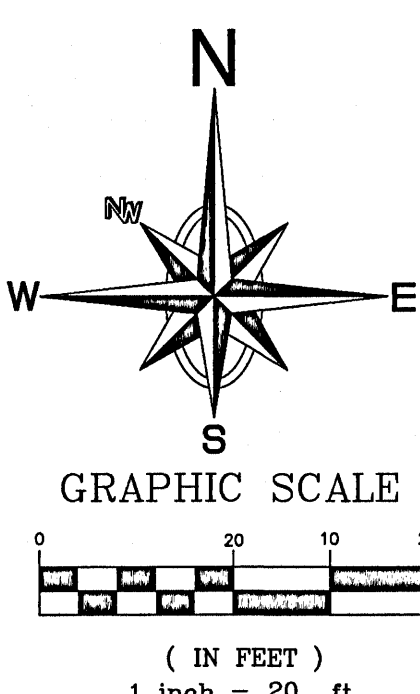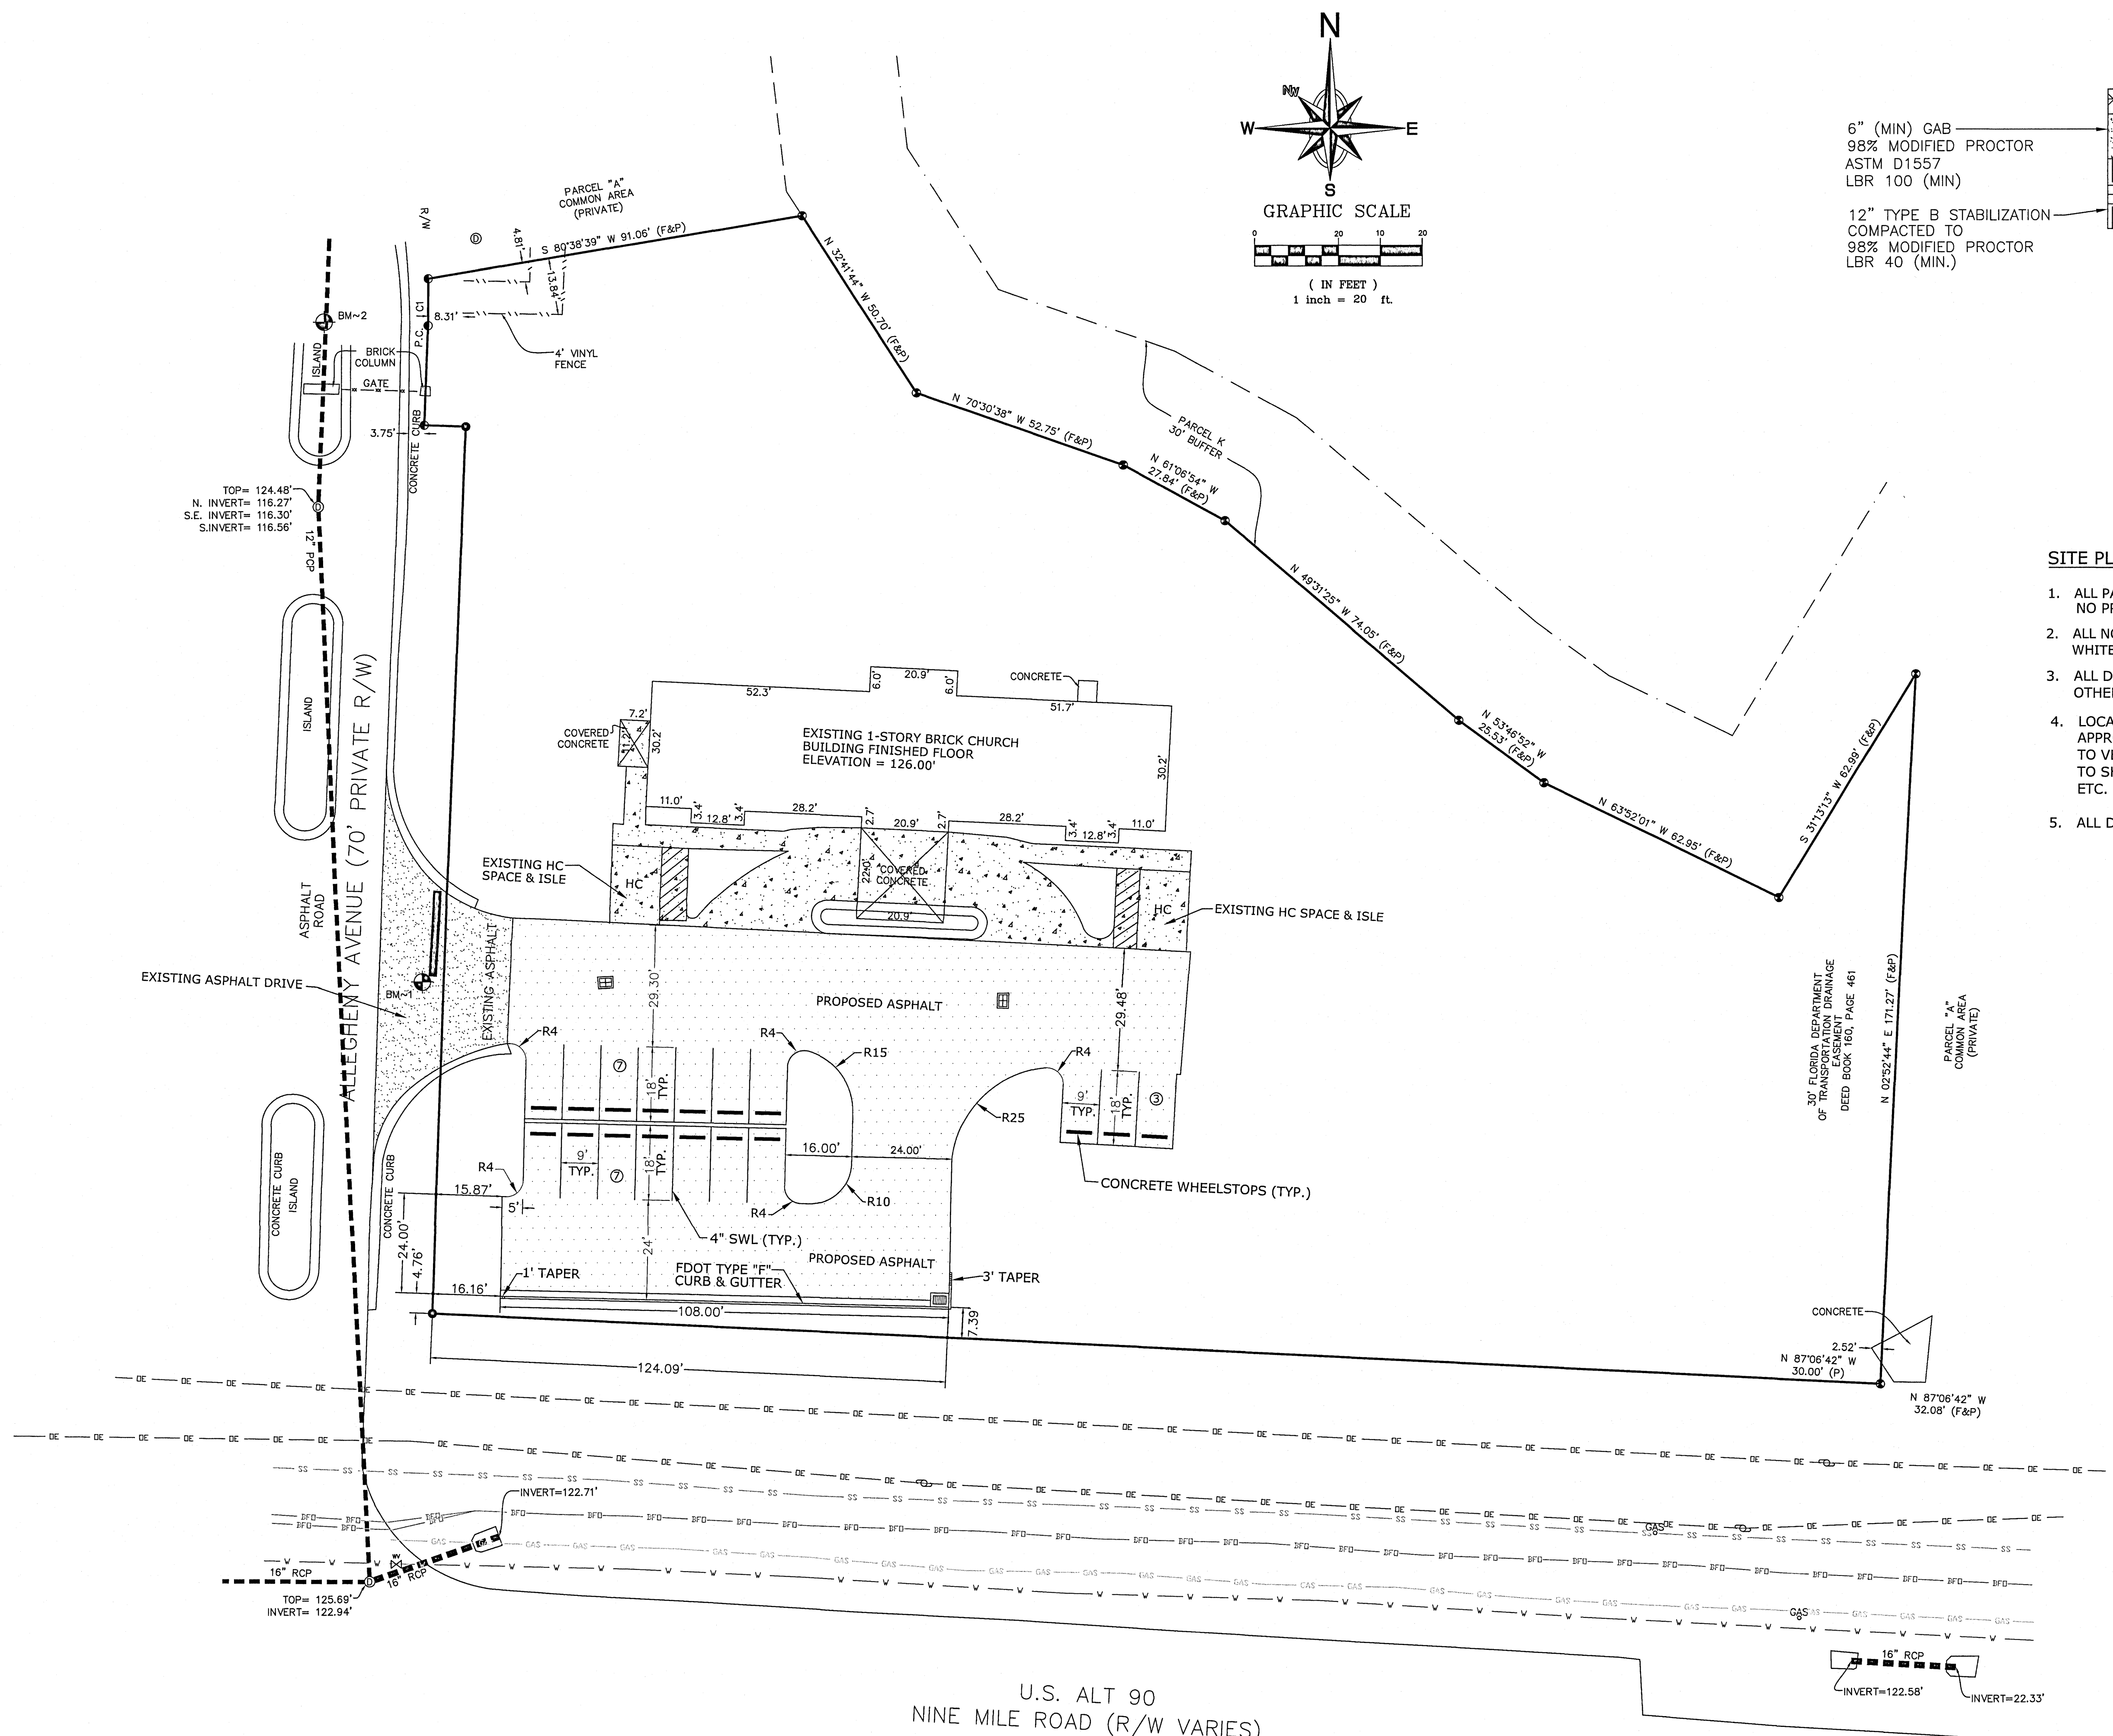

**SITE PLAN NOTES:**

1. ALL PAVEMENT MARKINGS & STRIPING SHALL BE THERMOPLASTIC. NO PRE-MANUFACTURED STRIPING (TAPE) WILL BE ALLOWED.
2. ALL NON-HANDICAPP PAVEMENT MARKINGS SHALL BE SOLID WHITE THERMOPLASTIC UNLESS OTHERWISE NOTED.
3. ALL DIMENSIONS AND RADII ARE TO THE FACE OF CURB UNLESS OTHERWISE NOTED.
4. LOCATIONS OF EXISTING UTILITIES SHOWN ON THESE PLANS ARE APPROXIMATE AND IT SHALL BE THE RESPONSIBILITY OF THE CONTRACTOR TO VERIFY THE LOCATION BEFORE CONSTRUCTION. FAILURE OF THE PLANS TO SHOW THE EXISTENCE OF ANY UNDERGROUND UTILITIES, STRUCTURES ETC. SHALL NOT RELIEVE THE CONTRACTOR FROM THE RESPONSIBILITY.
5. ALL DIMENSIONS ARE IN FEET UNLESS OTHERWISE NOTED.

SITE PLAN DATA	PRE-DEV	POST-DEV
BUILDING AREA (S.F.)	3,985	3,985
IMPERVIOUS PAVING (S.F.)	3,421	15,272
SEMI-IMPERVIOUS (S.F.)	6,209	0
PERVIOUS AREA (S.F.)	56,081	50,439
TOTAL LOT AREA (S.F.)	69,696	69,696

PERCENT IMPERVIOUS AREA= 19,257 S.F./69,696 S.F. X 100 = 27.63%  
PERCENT PERVIOUS AREA= 50,439 S.F./69,696 S.F. X 100 = 72.37%

**LEGEND:**

- |     |                                 |
|-----|---------------------------------|
| R/W | RIGHT OF WAY                    |
|     | BENCHMARK                       |
|     | UTILITY POLE                    |
|     | GUY ANCHOR                      |
|     | WATER METER                     |
|     | WATER VALVE                     |
|     | FIRE HYDRANT                    |
|     | STORM WATER INLET               |
|     | BURIED FIBER OPTIC CABLE MARKER |
|     | BURIED FIBER OPTIC CABLE BOX    |
|     | BACK FLOW PREVENTION DEVICE     |
|     | EXISTING ASPHALT                |
|     | NEW ASPHALT                     |
|     | EXISTING CONCRETE               |
|     | BUILDING SETBACK LINE           |
|     | PROPERTY LINE                   |
|     | RADIUS IN FEET                  |
|     | EXISTING CHAIN LINK FENCE       |
|     | EXISTING WOOD FENCE             |

U.S. ALT 90  
NINE MILE ROAD (R/W VARIES)

1	ESCAMBIA COUNTY COMMENTS DATED 02-19-21	02-21-21	DATE
			BY
			REVISIONS
			NO.


ENVIRONMENTAL ENGINEERING SERVICES  
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GREGORY ALLEN CAMPBELL, P.E.  
FL PE LICENSE #: 38572

PROJECT TITLE:  
FIRST CHURCH OF CHRIST SCIENTIST  
PARKING LOT EXPANSION  
  
5994 W NINE MILE ROAD  
PENSACOLA, FLORIDA  
ESCAMBIA COUNTY

SHEET TITLE:	SITE PLAN
DATE:	02-03-21
SCALE:	1"=20'
SHEET NUMBER:	C2
SHEET 3 OF 6	





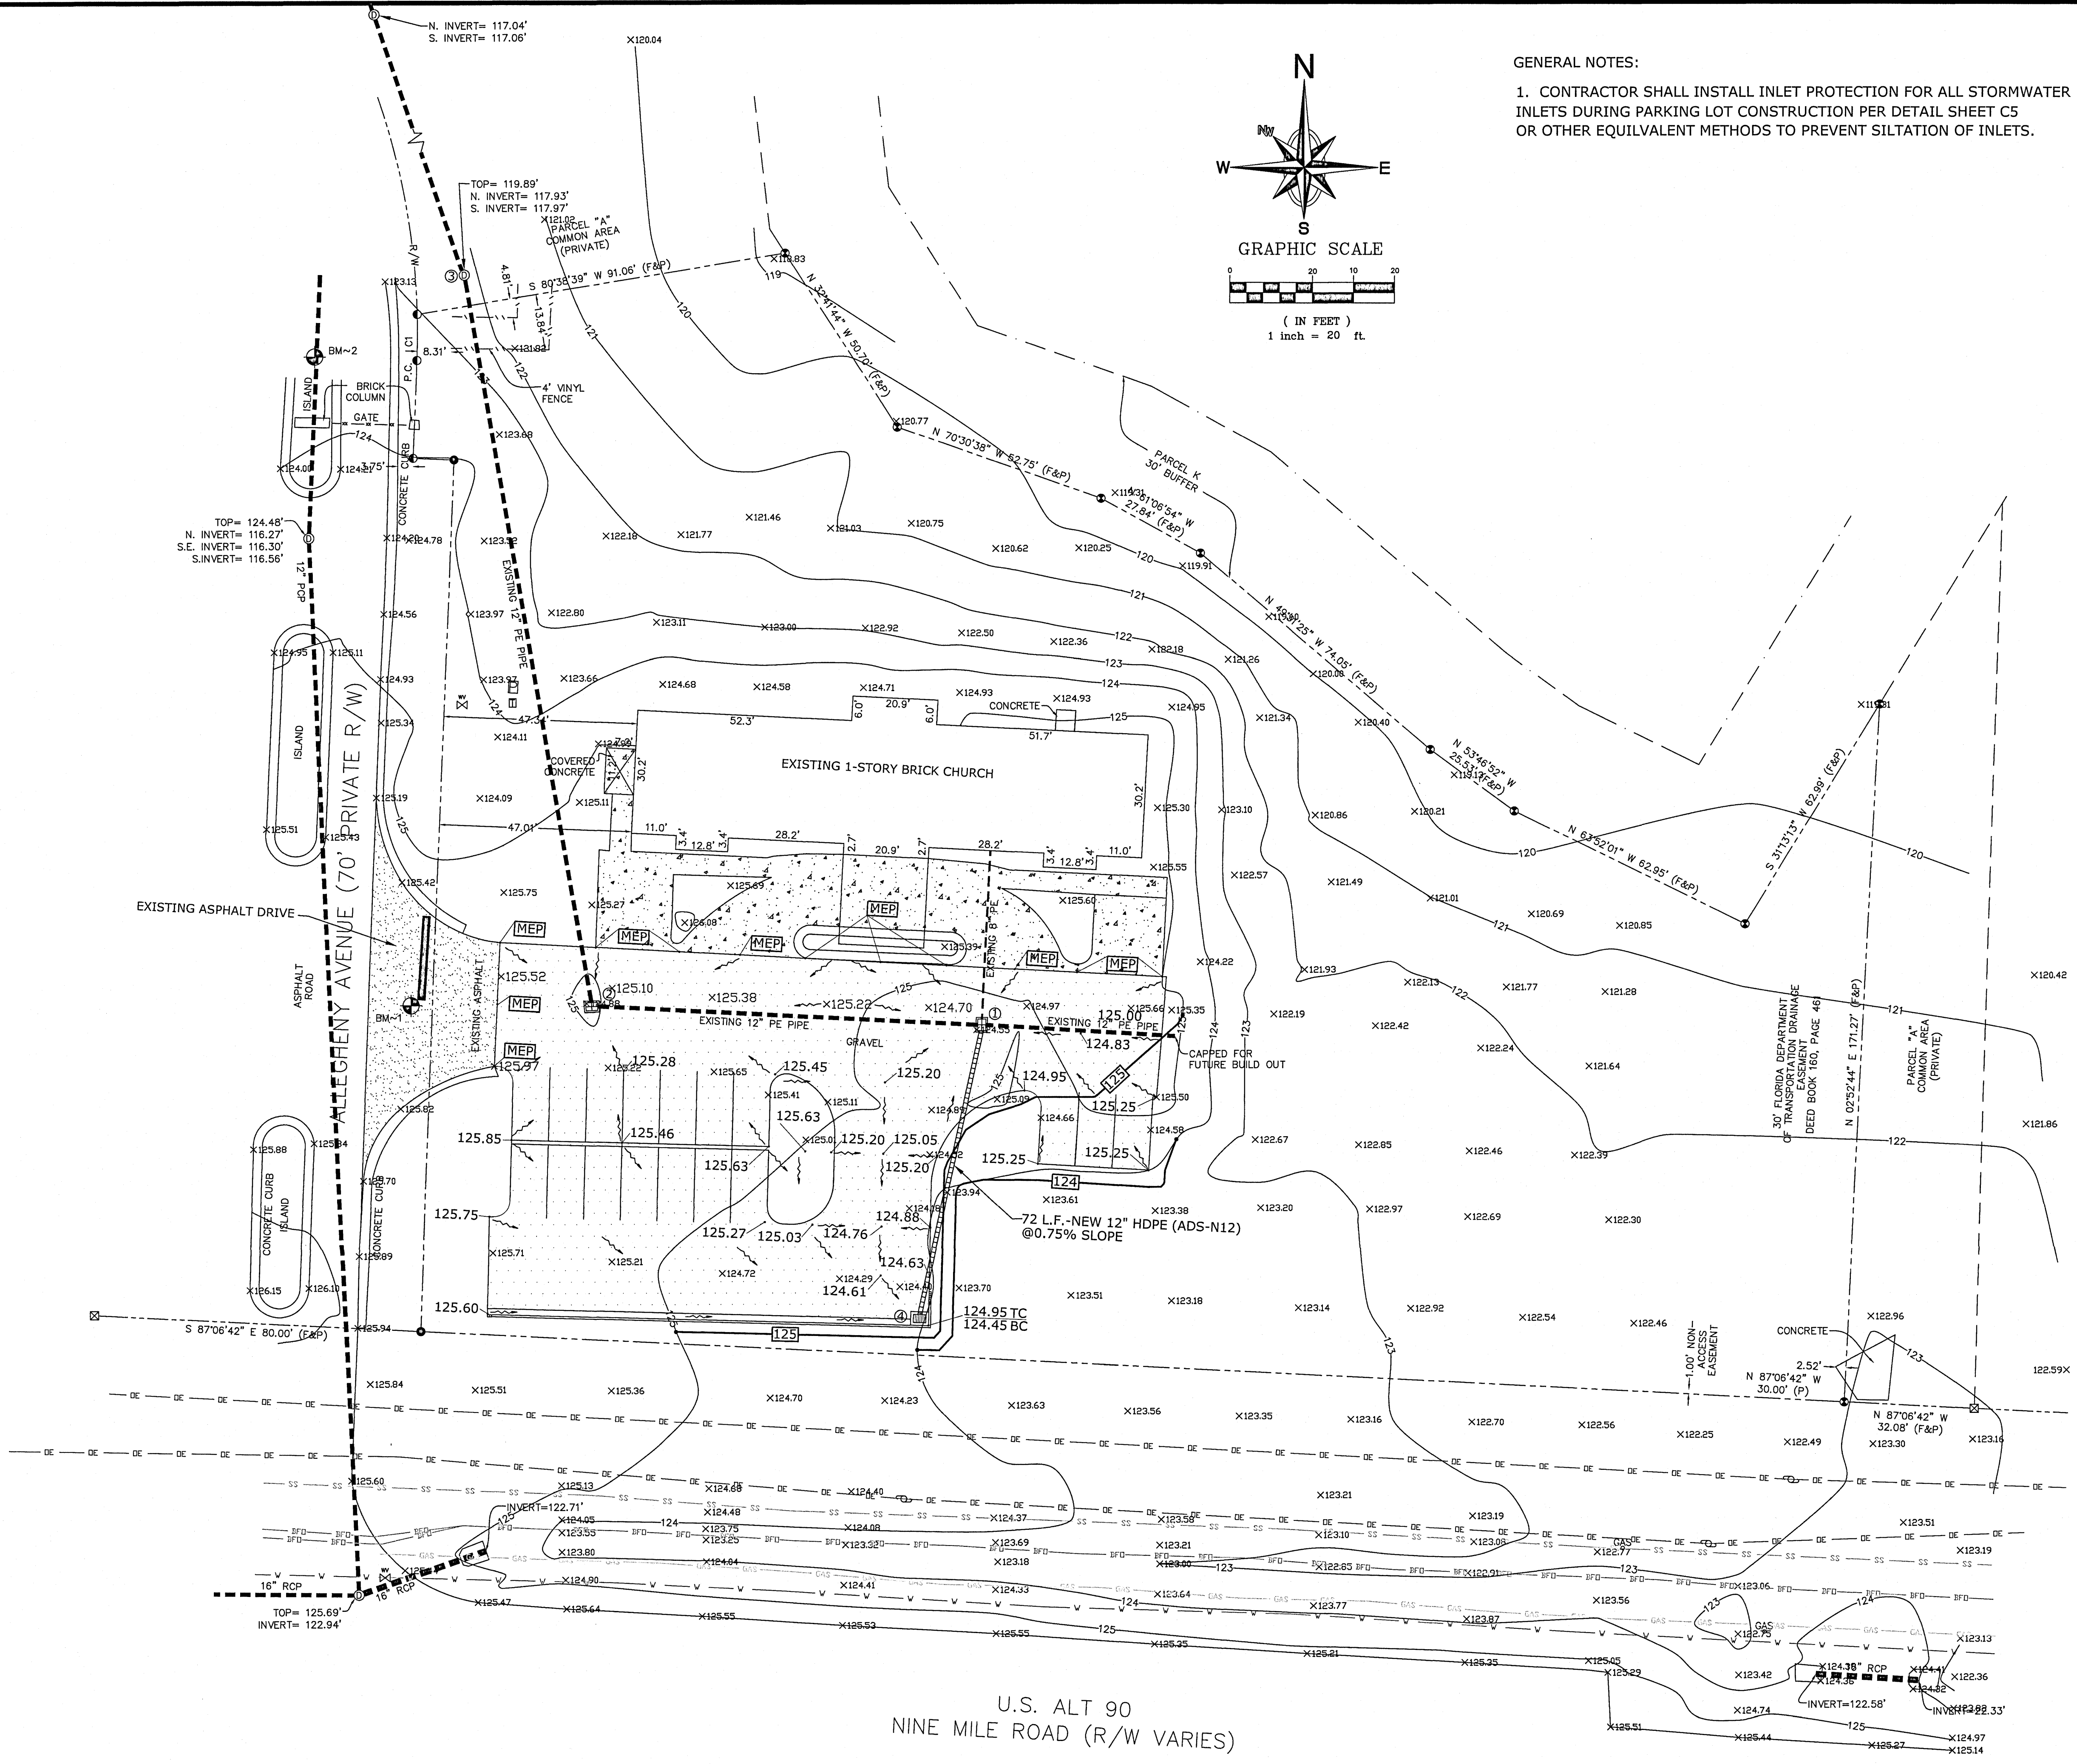


GENERAL NOTES:  
1. CONTRACTOR SHALL INSTALL INLET PROTECTION FOR ALL STORMWATER INLETS DURING PARKING LOT CONSTRUCTION PER DETAIL SHEET C5 OR OTHER EQUIVALENT METHODS TO PREVENT SILTATION OF INLETS.

NEW INLET SCHEDULE	
① EXISTING FDOT TYPE "C" DITCH BOTTOM INLET	
TOP EL. = 124.55'	
8" ADS N-12 PE PIPE INVERT ELEV (IN-N) = 122.11'	
12" ADS N-12 PE PIPE INVERT ELEV (IN-E) = 122.13'	
12" ADS N-12 PE PIPE INVERT ELEV (OUT-W) = 122.03'	
② EXISTING FDOT TYPE "C" DITCH BOTTOM INLET	
U.S.F. NO. 6611 STEEL TRAFFIC RATED GRATE	
GRATE TOP EL. = 124.88'	
12" ADS N-12 PE PIPE INVERT ELEV (IN-E) = 121.62'	
12" ADS N-12 PE PIPE INVERT ELEV (OUT-N) = 121.42'	
③ EXISTING STORMWATER JUNCTION BOX	
IRON MANHOLE COVER	
COVER TOP EL. = 119.89'	
12" ADS N-12 PE PIPE INVERT ELEV (IN-S) = 117.97'	
12" ADS N-12 PE PIPE INVERT ELEV (OUT-N) = 117.93'	
④ NEW FDOT TYPE "C" DITCH BOTTOM INLET	
U.S.F. NO. 6611 STEEL TRAFFIC RATED GRATE	
GRATE TOP EL. = 124.45'	
12" HDPE PIPE INVERT ELEV (OUT-N) = 122.65'	

LEGEND:	
R/W	RIGHT OF WAY
	DENOTES BENCHMARK
	MATCH EXISTING PAVEMENT
12.65	DENOTES PROPOSED SPOT ELEV.
x 11.30	DENOTES EXISTING SPOT ELEV.
13	DENOTES EXISTING SPOT ELEV.
13	DENOTES EXISTING ELEV CONTOUR
	DENOTES GRAVEL
	DENOTES CONCRETE
	DENOTES ASPHALT
---	DENOTES PROPERTY LINE
124.95 TC	DENOTES TOP OF CURB ELEV
124.45 BC	DENOTES BOTTOM OF CURB ELEV
	FLOW DIRECTION

U.S. ALT 90  
NINE MILE ROAD (R/W VARIES)

PROJECT TITLE:		SHEET TITLE:	
ENVIRONMENTAL ENGINEERING SERVICES FIRM REGISTRATION #: RY6515 2120 MARIA CIRCLE PENSACOLA, FLORIDA 32514 850-982-8606 (OFC) 850-477-1176 (FAX) GREGORY ALLEN CAMPBELL, P.E. FL PE LICENSE #: 38572		GRADING PLAN	
PROJECT TITLE:		SHEET TITLE:	
FIRST CHURCH OF CHRIST SCIENTIST PARKING LOT EXPANSION		GRADING PLAN	
DATE: 02-03-21		DATE: 02-03-21	
SCALE: 1"=20'		SCALE: 1"=20'	
SHEET NUMBER: C3		SHEET NUMBER: C3	
SHEET 4 OF 6		SHEET 4 OF 6	
ESCAMBIA COUNTY COMMENTS DATED 02-19-21		ESCAMBIA COUNTY COMMENTS DATED 02-19-21	
BY		BY	
REVISIONS		REVISIONS	
NO.		NO.	
DATE		DATE	

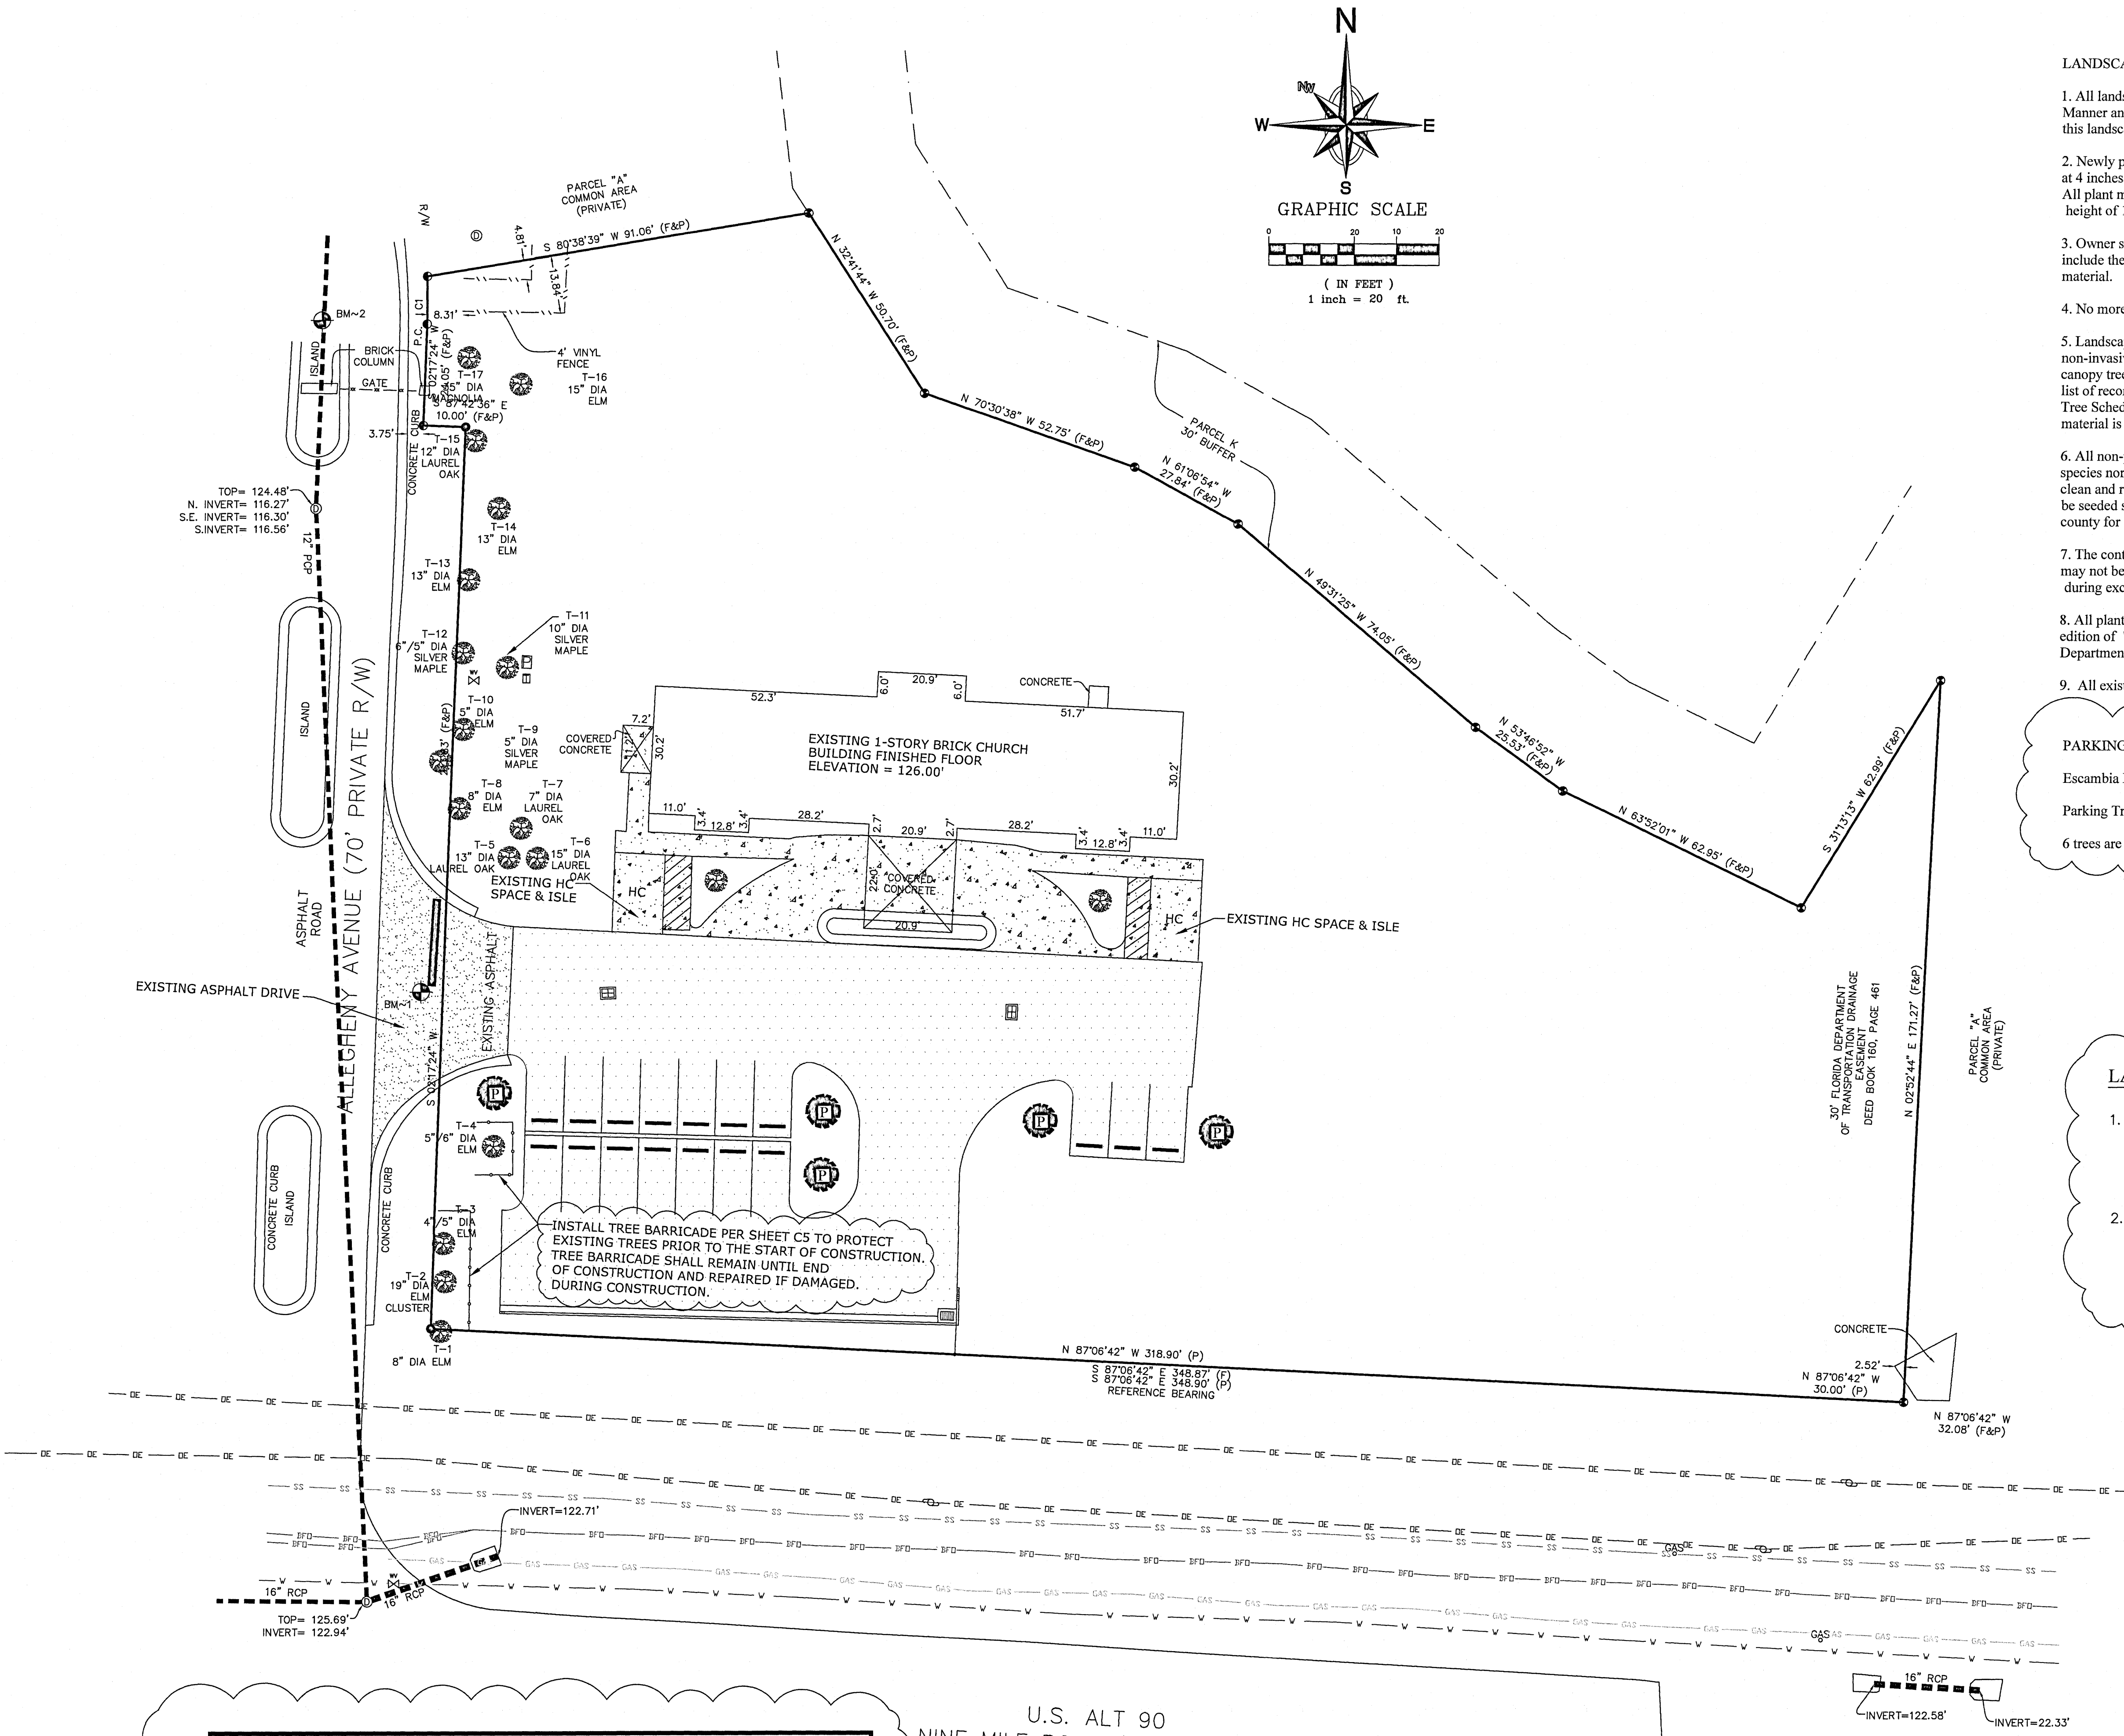

- LANDSCAPE NOTES:
1. All landscape material shall be installed in a sound workmanlike Manner and in accordance with the tree and shrub planting detail of this landscape plan.
  2. Newly planted canopy trees shall have a minimum caliper of 2.5 inches measured at 4 inches above root ball planting and normally attain a mature height of at least 20 feet. All plant material shall have a warranty of 2 years. All shrubs shall have a minimum height of 1 foot.
  3. Owner shall maintain all landscape areas at all times. Maintenance shall include the prompt replacement of all dead or damaged landscaped material.
  4. No more than 67% of landscaping material shall be of the same species.
  5. Landscaper shall refer to the Escambia County list of recommended native and non-invasive plant materials for selection of appropriate shrubs, understory and canopy trees. Developer may select any tree and shrub listed on Escambia County list of recommended native and non-invasive plant material in lieu of those designated Tree Schedule Table this sheet as long as no more than 67% of proposed landscaping material is the same species.
  6. All non-paved areas and exposed soil/dirt shall be regraded and sodded with grass species normally grown as permanent lawns in Escambia County. All sod shall be clean and reasonably free of weeds, noxious pests, and diseases. If grass areas are to be seeded sprigged, or plugged specifications must be submitted to the county for approval.
  7. The contractor is to be aware of underground utilities throughout landscaped areas that may not be illustrated on this plan. Contractor shall verify location and protect all utilities during excavation and/or finish grading activities.
  8. All plants shall conform to the standards for Florida Grade No. 1, or better, per latest edition of "Grades and Standards for Nursery Plants, Division of Plant Industry, Florida Department of Agriculture and Consumer Services".
  9. All existing trees are to remain. No trees are to be removed.

**PARKING LOT LANDSCAPE REQUIREMENTS**

Escambia LDC: 1 tree required per each end of parking row.

Parking Trees Required = 6 end of rows x 1 tree/end of parking row = 6 trees required

6 trees are proposed as shown on drawing and denoted in legend.

**LAND DISTURBANCE ACTIVITIES**

1. All trees shall remain onsite and any proposed land clearing or land disturbance activities, including the placement of fill/fill materials, grading, excavating, etc. shall not occur until such time as appropriate permit(s) are issued for such site work.
2. All land shall remain vegetated & in its natural state until such time as DRC Site Plan & any additional permitting approvals allow for such, per code. All tree removal, land clearing, placement of fill materials, or other Land Disturbing Activities, etc. shall be permitted or otherwise approved by the County prior to initiation.

**LEGEND:**

- PROPOSED GRAVEL
- PROPOSED CONCRETE
- PROPERTY LINE
- PROPOSED PARKING ROW TERMINUS TREE SOUTHERN MAGOLIA OR APPROVED PER NOTE #5 THIS SHEET. TREES REQUIRED = 5 TREES
- EXISTING TREE
- PROPOSED TREE BARRICADE

DATE: 02-03-20

SCALE: 1"=20'

SHEET NUMBER: C4

SHEET 5 OF 6

**LANDSCAPE PLAN**

PROJECT TITLE: ENVIRONMENTAL ENGINEERING SERVICES  
FIRM REGISTRATION #: RY6515  
2120 MARIA CIRCLE  
PENSACOLA, FLORIDA 32514  
850-982-8606 (OFC)  
850-477-1176 (FAX)  
GREGORY ALLEN CAMPBELL, P.E.  
FL PE LICENSE #: 38572

SHEET TITLE: FIRST CHURCH OF CHRIST SCIENTIST  
PARKING LOT EXPANSION  
5994 W NINE MILE ROAD  
PENSACOLA, FLORIDA  
ESCAMBIA COUNTY

NOTE: ALL EXISTING TREES ARE TO REMAIN.  
NO EXISTING TREES TO BE REMOVED.

U.S. ALT 90  
NINE MILE ROAD (R/W VARIES)







1. SILT FENCE SHALL BE ERECTED AND MAINTAINED AROUND ALL DRAINAGE STRUCTURES UNTIL DRAINAGE AREAS ARE PAVED OR STABILIZED TO PREVENT EROSION. SILT FENCE SHALL BE IN ACCORDANCE WITH DETAILS, AS SHOWN ON THIS SHEET.

2. FABRIC MAY BE ATTACHED TO POSTS BY STAPLES, NAILS, WIRE, CORD OR POCKETS. MINIMUM NUMBER OF FASTENERS SHALL BE 5, EQUALLY SPACED. NAILS SHALL BE 14 GAUGE, 1" LONG, 3/4" BUTTON HEADS. STAPLES SHALL BE 17 GAUGE, 3/4" WIDE, 1/2" LONG LEGS.

3. EROSION CONTROL IS TO BE CONSTRUCTED FIRST, STORMWATER POND IS SECOND, AND BOTH ARE TO BE IN-PLACE BEFORE ANY OTHER CONSTRUCTION IS BEGUN.

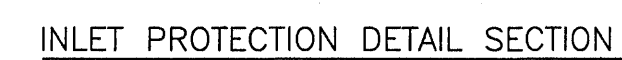


N.T.S.

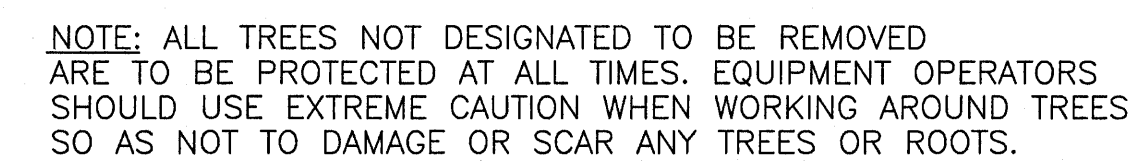

TREE PROTECTION DETAIL  
N.T.S.



	SHEET NUMBER:		C5			
	SHEET 6 OF 6					
	SCALE: 1"=20'		DATE: 02-03-21			
	SHEET TITLE:		PROJECT TITLE:			
	CONSTRUCTION DETAILS		FIRST CHURCH OF CHRIST SCIENTIST PARKING LOT EXPANSION  5994 W NINE MILE ROAD PENSACOLA, FLORIDA ESCAMBIA COUNTY			
ENVIRONMENTAL ENGINEERING SERVICES FIRM REGISTRATION #: RY6515 2120 MARIA CIRCLE PENSACOLA, FLORIDA 32514 850-982-8606 (OFC) 850-477-1176 (FAX) GREGORY ALLEN CAMPBELL, P.E. FL PE LICENSE #: 38572		1		ESCAMBIA COUNTY COMMENTS DATED 02-19-21	GAC	02-21-21
NO.		REVISIONS		BY		DATE