THE CONTRACTOR IS RESPONSIBLE FOR OBTAINING "RELEASED FOR CONSTRUCTION" DRAWINGS FROM REBOL-BATTLE & ASSOCIATES BEFORE BEGINNING CONSTRUCTION. REBOL-BATTLE & ASSOCIATES WILL NOT BE RESPONSIBLE FOR ANY CONSTRUCTION BASED ON PLANS THAT HAVE NOT BEEN RELEASED FOR CONSTRUCTION.

# CONSTRUCTION PLANS FALLSCHASE AT PATHSTONE PHASE 4

**RBA PROJECT NO.: 2017.103** 

	SITE INFORMATION
OWNER:	PATHSTONE FL 2017 LLC 29891 WOODROW LN STE 300 SPANISH FORT, AL 36527
DEVELOPER:	PATHSTONE FL 2017 LLC 29891 WOODROW LN STE 300 SPANISH FORT, AL 36527
PROPERTY REFERENCE NO:	10-1S-31-1401-001-002
PROPERTY ADDRESS:	NINE MILE ROAD
PROPERTY AREA:	16.29 ACRES
PROJECT AREA:	10.51 ACRES
PROPERTY ZONING:	COMMERCIAL
FUTURE LAND USE:	MU-U
PROPOSED ACTIVITY:	SUBDIVISION
REQUIRED BUILDING SETBACKS COMMERCAIL:	FRONT YARD - 15 FT. SIDE YARD - 10 FEET OR 10% OF LOT WIDTH AT STREET R/W WHICHEVER IS LESS BUT NOT LESS THAN 5' REAR YARD - 15 FT.


FEMA FLOOD INSURANCE RATE MAP INFORMAT						
	THE PARCEL SHOWN FOR DEVELOPMENT IS LOCATED WITHIN THE FOLLOWING FLOOD ZONE(S AS DETAILED BY FEMA FIRM (FLOOD INSURANCE RATE MAP) INFORMATION DESCRIBED BELOW					
	FLOOD ZONE(S)	COMMUNITY No.	MAP No.	PANEL No.	SUFFIX	MAP REVISION DATE
	Х	120080	12033C	290	G	SEPT 29, 2006

FLOOD NOTE: BY GRAPHIC PLOTTING ONLY; THE PROPERTY SHOWN HEREON IS IN ZONE 'X' AS PER THE FEDERAL EMERGENCY MANAGEMENT AGENCY'S FLOOD INSURANCE RATE FOR ESCAMBIA COUNTY, FLORIDA; SEE COMMUNITY PANEL No.12033C 0290 G; WHICH BEARS A MAP REVISED DATE OF SEPTEMBER 29, 2006. ALL PROPOSED DEVELOPMENT WITHIN THE SUBDIVISION IS LOCATED IN FLOOD ZONE 'X'

SITE ENVIRONMENTAL INFORM	MATION
OVERALL SITE AREA	16.29 ACRES
ACOE/NWFWMD/ESCAMBIA COUNTY JURISDICTIONAL WETLANDS	5.24 ACRES
EXISTING WETLAND BUFFER	0.76 ACRES
WETLAND IMPACT (RETENTION POND)	0.11 ACRES
EXISTING WETLAND BUFFER IMPACT	0.22 ACRES
ADDITIONAL WETLAND BUFFER	0 ACRES
AVERAGE BUFFER WIDTH	0 FT
CONSERVATION EASEMENT	0 ACRES
MERS BUFFER	0 ACRES

CONTACTS				
GULF POWER 5120 DOGWOOD DRIVE MILTON, FLORIDA 32570	CONTACT: CHAD SWAILS PHONE: 850.429.2446 FAX: 850.429.2432			
COX CABLE 3405 McLEMORE DR. PENSACOLA, FLORIDA 32514	CONTACT: TROY YOUNG PHONE: 850.857.4510 FAX: 850.475.0621			
ECUA 9255 STURDEVANT ST. PENSACOLA, FLORIDA 32514	CONTACT: JACOB KEARLEY, P.E. PHONE: 850.969.5823			
ENERGY SERVICES GAS 1625 ATWOOD DRIVE PENSACOLA, FLORIDA 32504	CONTACT: DIANE MOORE PHONE: 850.474.5319 FAX: 850.474.5331			
AT&T, INC. 605 W. GARDEN STREET PENSACOLA, FLORIDA 32501	CONTACT: JONATHAN BLANKINCHIP PHONE: 850.436.1489			
ESCAMBIA COUNTY PUBLIC WORKS 3363 WEST PARK PLACE PENSACOLA, FLORIDA 32501	CONTACT: MRS. JOHNNY PETTIGREW PHONE: 850.595.3404			
MCI	PHONE: 800.624.9675			
SUNSHINE UTILITIES	PHONE: 800.432.4770			

# AN 47 LOT SUBDIVISION HIGHWAY 90 ESCAMBIA COUNTY, FLORIDA June 16, 2022

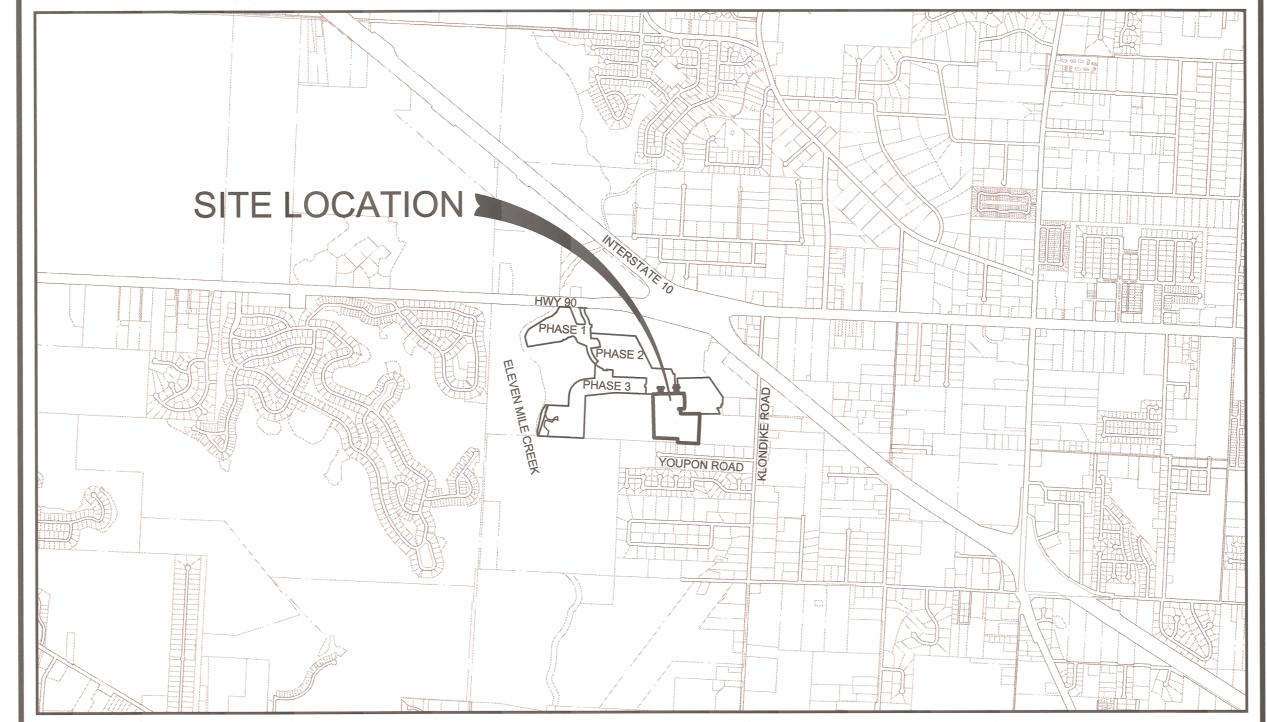

## VICINITY MAP

SCALE: 1" = 2000'

PROFESSIONAL SURVEYOR AND MAPPER MARK A. NORRIS P.S.M. REBOL-BATTLE & ASSOCIATES, LLC 2301 NORTH NINTH AVE., SUITE 300 PENSACOLA, FL 32503 TELEPHONE 850.438.0400

> CIVIL ENGINEER JEREMY R. KING, P.E. REBOL-BATTLE & ASSOCIATES, LLC 2301 NORTH NINTH AVE., SUITE 300 PENSACOLA, FL 32503 TELEPHONE 850.438.0400



# REBOL-BATTLE & ASSOCIATES

## Civil Engineers and Surveyors

2301 N. Ninth Avenue, Suite 300 Pensacola, Florida 32503 Telephone 850.438.0400 Fax 850.438.0448 EB 00009657 LB 7916

Imperv. Surf. 63075.0 Sq ft Stormwater Ret. 0.87 % (F) Pond Maint. Fee: MSBU

#### **ECUA ENGINEERING MANUAL REFERENCE NOTE** \*NOTES SHALL BE INSERTED IN THE UPPER RIGHT CORNER OF TITLE SHEET

\*APPLICABLE ONLY TO ECUA INFRASTRUCTURE TO BE CONSTRUCTED IN PUBLIC ROW OR IN UTILITY

#### B. ADDITIONAL DOCUMENTS (TO BE COMPLETED BY THE ENGINEER OF RECORD

DOES THIS PROJECT HAVE ADDITIONAL TECHNICAL SPECIFICATIONS OR CONSTRUCTION DETAILS THAT SUPERSED

IF YES, CONTRACTOR SHALL CONSTRUCT PROJECT IN ACCORDANCE WITH SAID DOCUMENTS AS LISTED AND

	DOCUMENT NAME	DOCUME	ENT TYPE	LOCATION	
DOCON	DOCUMENT NAME	SPECIFICATION	DETAIL	PLANS	PROJECT MANUAL*

### INDEX OF DRAWINGS


C1.0 ~ C1.1	EXISTING SITE, DEMOLITION AND EROSION CONTROL PLAN
C1.2	EROSION CONTROL DETAILS
C1.3	NPDES-STORMWATER POLLUTION PREVENTION PLAN
C2.0 ~ C2.3	SITE LAYOUT AND DIMENSION PLAN
C3.0 ~ C3.6	GRADING, DRAINAGE PLAN AND DETAILS
C4.0 ~ C4.1	UTILITY PLAN
C5.0 ~ C5.3	PLAN AND PROFILE
C6.0 ~ C6.1	STORMWATER PLAN AND PROFILE
$C7.0 \sim C7.2$	CROSS SECTIONS


#### LEGAL DESCRIPTION

DESCRIPTION: (PREPARED BY REBOL-BATTLE & ASSOCIATES) (2017.103 PHASE 4)

COMMENCING AT THE NORTHEAST CORNER OF SECTION 10, TOWNSHIP 1 SOUTH, RANGE 31 WEST, ESCAMBIA COUNTY, FLORIDA; THENCE PROCEED SOUTH 03°16'19" WEST ALONG THE EAST LINE OF SAID SECTION 10 FOR A DISTANCE OF 2647.04 FEET TO THE SOUTHEAST CORNER OF THE NORTHEAST QUARTER OF SAID SECTION 10: THENCE DEPARTING SAID EAST LINE PROCEED NORTH 87°05'55" WEST ALING THE SOUTH LINE OF THE NORTH HALF OF SAID SECTION 10 FOR A DISTANCE OF 1127.27 FEET TO THE POINT OF BEGINNING; THENCE PROCEED NORTH 87°08'55" WEST ALONG SAID SOUTH LINE FOR A DISTANCE OF 404.57 FEET; THENCE DEPARTING SAID SOUTH LINE PROCEED NORTH 02°36'38" WEST FOR A DISTANCE OF 72.08 FEET: THENCE PROCEED NORTH 87°08'42" WEST FOR A DISTANCE OF 464.14 FEET: THENCE PROCEED NORTH 01°23'02" WEST FOR A DISTANCE OF 849.91 FEET: THENCE PROCEED NORTH 88°37'30" EAST FOR A DISTANCE OF 130.27 FEET; THENCE PROCEED NORTH 01°22'30" WEST FOR A DISTANCE OF 95.95 FEET TO THE POINT OF CURVATURE ON A CIRCULAR CURVE CONCAVE SOUTHWESTERLY, SAID CURVE HAVING A RADIUS OF 25.00 FEET; THENCE PROCEED NORTHWESTERLY ALONG THE ARC OF SAID CURVE FOR AN ARC DISTANCE OF 37.59 FEET (DELTA ANGLE = 86°09'30", CHORD = 34.15 FEET, CHORD BEARING = NORTH 44°27'15" WEST); THENCE DEPARTING SAID CURVE PROCEED SOUTH 87°32'27" EAST FOR A DISTANCE OF 46.70 FEET TO THE POINT OF CURVATURE OF A CIRCULAR CURVE CONCAVE NORTHERLY, SAID CURVE HAVING A RADIUS OF 970.30 FEET; THENCE PROCEED EASTERLY ALONG THE ARC OF SAID CURVE AN ARC DISTANCE OF 52.11 FEET (DELTA ANGLE = 03°04'38". CHORD DISTANCE = 52.11 FEET. CHORD BEARING = SOUTH 89°03'43" EAST); TO A NON-TANGENT POINT OF A CIRCULAR CURVE CONCAVE SOUTHEASTERLY, SAID CURVE HAVING A RADIUS OF 25.00 FEET; THENCE PROCEED SOUTHWESTERLY ALONG THE ARC OF SAID CURVE AN ARC DISTANCE OF 39.60 FEET (DELTA ANGLE = 90°46'03", CHORD DISTANCE = 35.59 FEET, CHORD BEARING = SOUTH 44°00'32" WEST) TO THE POINT OF TANGENCY; THENCE DEPARTING SAID CURVE PROCEED SOUTH 01°22'30" EAST FOR A DISTANCE OF 90.67 FEET; THENCE PROCEED NORTH 88°37'30" EAST FOR A DISTANCE OF 260.00 FEET; THENCE PROCEED NORTH 01'22'30" WEST FOR A DISTANCE OF 90.58 FEET TO THE POINT OF CURVATURE OF A CIRCULAR CURVE CONCAVE TO THE SOUTHWEST, SAID CURVE HAVING A RADIUS OF 25.00 FEET; THENCE PROCEED NORTHWESTERLY ALONG THE ARC OF SAID CURVE AN ARC DISTANCE OF 39.27 FEET (DELTA ANGLE = 90°00'00", CHORD DISTANCE = 35.36 FEET, CHORD BEARING = NORTH 46°22'30" WEST); THENCE DEPARTING SAID CURVE PROCEED NORTH 88°37'30" EAST FOR A DISTANCE OF 100.00 FEET TO A NON-TANGENT POINT ON A CIRCULAR CURVE CONCAVE SOUTHEASTERLY, SAID CURVE HAVING A RADIUS OF 25.00 FEET; THENCE PROCEED SOUTHWESTERLY ALONG THE ARC OF SAID CURVE AN ARC DISTANCE OF 39.27 FEET (DELTA ANGLE = 90°00'00", CHORD DISTANCE = 35.36 FEET, CHORD BEARING = SOUTH 43°37'30" WEST) TO THE POINT OF TANGENCY: THENCE DEPARTING SAID CURVE PROCEED SOUTH 01°22'30" EAST FOR A DISTANCE OF 90.58 FEET; THENCE PROCEED NORTH 88°37'30" EAST FOR A DISTANCE OF 120.00 FEET; THENCE PROCEED SOUTH 01°22'30" EAST FOR A DISTANCE OF 50.00 FEET; THENCE 108.79 FEET TO A NON-TANGENT POINT ON A CIRCULAR CURVE CONCAVE TO THE NORTHEAST, SAID CURVE HAVING A RADIUS OF 15.00 FEET; THENCE PROCEED SOUTHEASTERLY ALONG THE ARC OF SAID CURVE AN ARC DISTANCE OF 15.12 FEET (DELTA ANGLE = 57°45'22", CHORD DISTANCE = 14.49 FEET. CHORD BEARING = SOUTH 30°15'11" EAST) TO A POINT OF REVERSE CURVATURE OF A CIRCULAR CURVE CONCAVE TO SOUTHWESTERLY, SAID CURVE HAVING A RADIUS OF 60.00 FEET; THENCE PROCEED SOUTHEASTERLY ALONG THE ARC OF SAID CURVE AN ARC DISTANCE OF 85.30 FEET (DELTA ANGLE = 81°27'29", CHORD DISTANCE = 78.30 FEET, CHORD BEARING = SOUTH 18°24'07" EAST); THENCE DEPARTING SAID CURVE PROCEED SOUTH 57°43'30" EAST FOR A DISTANCE OF 15.09 FEET; THENCE PROCEED SOUTH 89°28'21" EAST FOR A DISTANCE OF 368.19 FEET; THENCE PROCEED SOUTH 02°51'05" WEST FOR A DISTANCE OF 579.46 TO THE POINT OF BEGINNING LYING IN AND BEING A PORTION OF SECTION 10. TOWNSHIP 1 SOUTH, RANGE 31 WEST, ESCAMBIA COUNTY, FLORIDA, AND CONTAINING 16.29 ACRES MORE OR LESS.

This document has been reviewed in accordance with requirements of applicable Escambia County Regulations and Ordinances and does not in any way relieve the submitting Architect, Engineer, Surveyor, or other signatory from responsibility of details as drawn.

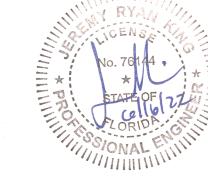

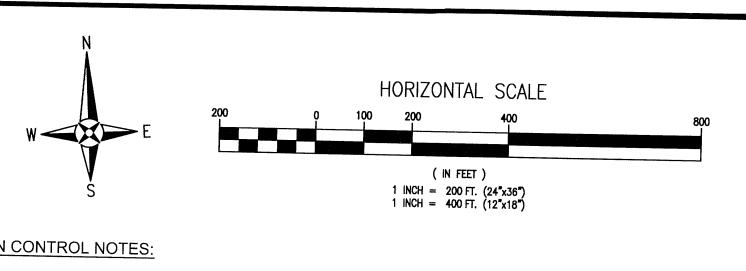

#### **EROSION CONTROL NOTES:**

1. THE CONTRACTOR SHALL ESTABLISH EROSION CONTROL PRIOR TO COMMENCING ANY CONSTRUCTION OR DEMOLITION ON THE PROJECT. EROSION CONTROL BARRIER PLACEMENT AS INDICATED IS SUGGESTED ONLY AND DOES NOT RELIEVE THE CONTRACTOR FROM CONTROLLING EROSION AND SEDIMENT WITHIN THE PROJECT SITE. EROSION CONTROL MEASURES ARE TO REMAIN IN PLACE AND BE MAINTAINED DURING THE ENTIRE TIME OF CONSTRUCTION AND DEMOLITION ON THE PROJECT.

2. AN EROSION CONTROL BARRIER IS TO BE PLACED ALONG ALL BOUNDARIES OF THE PROJECT AREA AS SHOWN BEFORE CONSTRUCTION BEGINS AND REMAIN IN PLACE UNTIL CONSTRUCTION IS FINISHED AND ACCEPTED AND FINAL STABILIZATION IS COMPLETE.

3. INSPECT AND REESTABLISH EROSION CONTROL BARRIERS WEEKLY AND AFTER EVERY SIGNIFICANT STORM EVENT.

4. THE CONTRACTOR IS REQUIRED TO SUBMIT A NOTICE OF INTENT TO USE GENERIC PERMIT FOR STORMWATER DISCHARGE FROM LARGE AND

**GENERAL NOTES:** 1. ALL WORK SHALL BE PERFORMED IN ACCORDANCE WITH THESE PLANS AND SPECIFICATIONS AND THE REQUIREMENTS AND STANDARDS OF ALL GOVERNING AUTHORITIES.

2. PRIOR TO STARTING CONSTRUCTION, THE CONTRACTOR SHALL BE RESPONSIBLE TO CONFIRM THAT ALL REQUIRED PERMITS AND APPROVALS HAVE BEEN OBTAINED. NO CONSTRUCTION OR FABRICATION SHALL BEGIN UNTIL THE CONTRACTOR HAS RECEIVED AND THOROUGHLY REVIEWED ALL PLANS AND OTHER DOCUMENTS APPROVED BY ALL OF THE PERMITTING AGENCIES.

3. THE LOCATION OF UNDERGROUND FACILITIES SHOWN ON THESE PLANS ARE BASED ON INFORMATION PROVIDED BY THE UTILITIES AND SHALL BE CONSIDERED APPROXIMATE. IT SHALL BE THE CONTRACTOR'S FULL RESPONSIBILITY TO CONTACT THE VARIOUS UTILITY COMPANIES TO LOCATE THEIR FACILITIES PRIOR TO STARTING CONSTRUCTION. NO ADDITIONAL COMPENSATION SHALL BE PAID TO THE CONTRACTOR FOR DAMAGE AND REPAIR TO THESE FACILITIES CAUSED BY HIS WORK FORCE.

4. THE CONTRACTOR SHALL NOTIFY THE SUPERINTENDENTS OF THE WATER, SANITARY SEWER GAS, TELEPHONE, CABLE TELEVISION, AND POWER COMPANIES 10 DAYS IN ADVANCE THAT HE INTENDS TO START WORK IN A SPECIFIED AREA. THE OWNER DISCLAIMS ANY RESPONSIBILITY FOR THE SUPPORT AND PROTECTION OF SEWERS, DRAINS, WATER PIPES, GAS PIPES, CONDUITS OF ANY KIND, UTILITIES OR OTHER STRUCTURES OWNED BY THE CITY, COUNTY, STATE OR BY PRIVATE OR PUBLIC UTILITIES LEGALLY OCCUPYING ANY STREET, ALLEY, PUBLIC PLACE OR RIGHT-OF-WAY.

5. SITE CLEARING SHALL INCLUDE THE LOCATION AND REMOVAL OF ALL UNDERGROUND STRUCTURES, WHICH ARE NOT IN SERVICE AS NECESSARY FOR THE INSTALLATION OF PROPOSED IMPROVEMENTS. THESE INCLUDE PIPES, VALVES, DRAINAGE STRUCTURES, ETC., AS INDICATED ON THE CONTRACT PLANS. CONTRACTOR SHALL NOTIFY THE PROJECT OWNER AND ENGINEER OF ALL DISCOVERED UNDERGROUND

8. ALL AREAS, NOT PAVED, DISTURBED DURING CONSTRUCTION SHALL BE CLEANED OF DEBRIS AND CONSTRUCTION MATERIAL AND RAKED SMOOTH.

9. ALL EXCESS MATERIAL SHALL BE HAULED AWAY AND DISPOSED OF APPROPRIATELY AT THE CONTRACTOR'S EXPENSE.

10. CONTRACTOR SHALL VISIT SITE TO FAMILIARIZE HIMSELF WITH EXISTING CONDITIONS AND THE EXTENT OF CLEARING & GRUBBING REQUIRED.

11. ALL DIMENSIONS AND GRADES SHOWN ON THE PLANS SHALL BE FIELD VERIFIED BY THE CONTRACTOR PRIOR TO CONSTRUCTION. CONTRACTOR SHALL NOTIFY THE ENGINEER IF ANY DISCREPANCIES EXIST PRIOR TO PROCEEDING WITH CONSTRUCTION FOR NECESSARY PLAN OR GRADE CHANGES. NO EXTRA COMPENSATION SHALL BE PAID TO THE CONTRACTOR FOR WORK HAVING TO BE REDONE DUE TO DIMENSIONS OR GRADES SHOWN INCORRECTLY ON THESE PLANS IF SUCH NOTIFICATION HAS NOT BEEN

12. CONTRACTOR TO COORDINATE WITH RESPONSIBLE UTILITY FOR PROTECTION/HOLDING OF UTILITY POLES, GUY WIRES, AND GUY ANCHORS IN AREAS OF CONSTRUCTION. CONTRACTOR SHALL INCLUDE THE COST OF PROTECTING UTILITY POLES IN THEIR OVERALL PRICE TO THE OWNER.


13. DAMAGE TO EXISTING ROADS DURING CONSTRUCTION SHALL BE REPAIRED BY THE CONTRACTOR PRIOR TO FINAL "AS-BUILT" SIGN-OFF FROM THE COUNTY.

14. THE CONTRACTOR SHALL NOTIFY FDOT 48 HOURS IN ADVANCE PRIOR TO INITIATING ANY WORK IN THE STATE RIGHT-OF-WAY.

POINT CHART POINT # DESCRIPTION NORTHING EASTING ELEVATION 2" DIA ROUND CONC MONUMENT | 567494.7602 | 1075466.8797 | 107.85' BM NO.15 BM NO.16 2" DIA ROUND CONC MONUMENT 566647.1295 1075487.3576 | 102.84' **TBM NO.17** 567397.5930 | 1076011.5910 | 100.76' NAIL AND DISK SET


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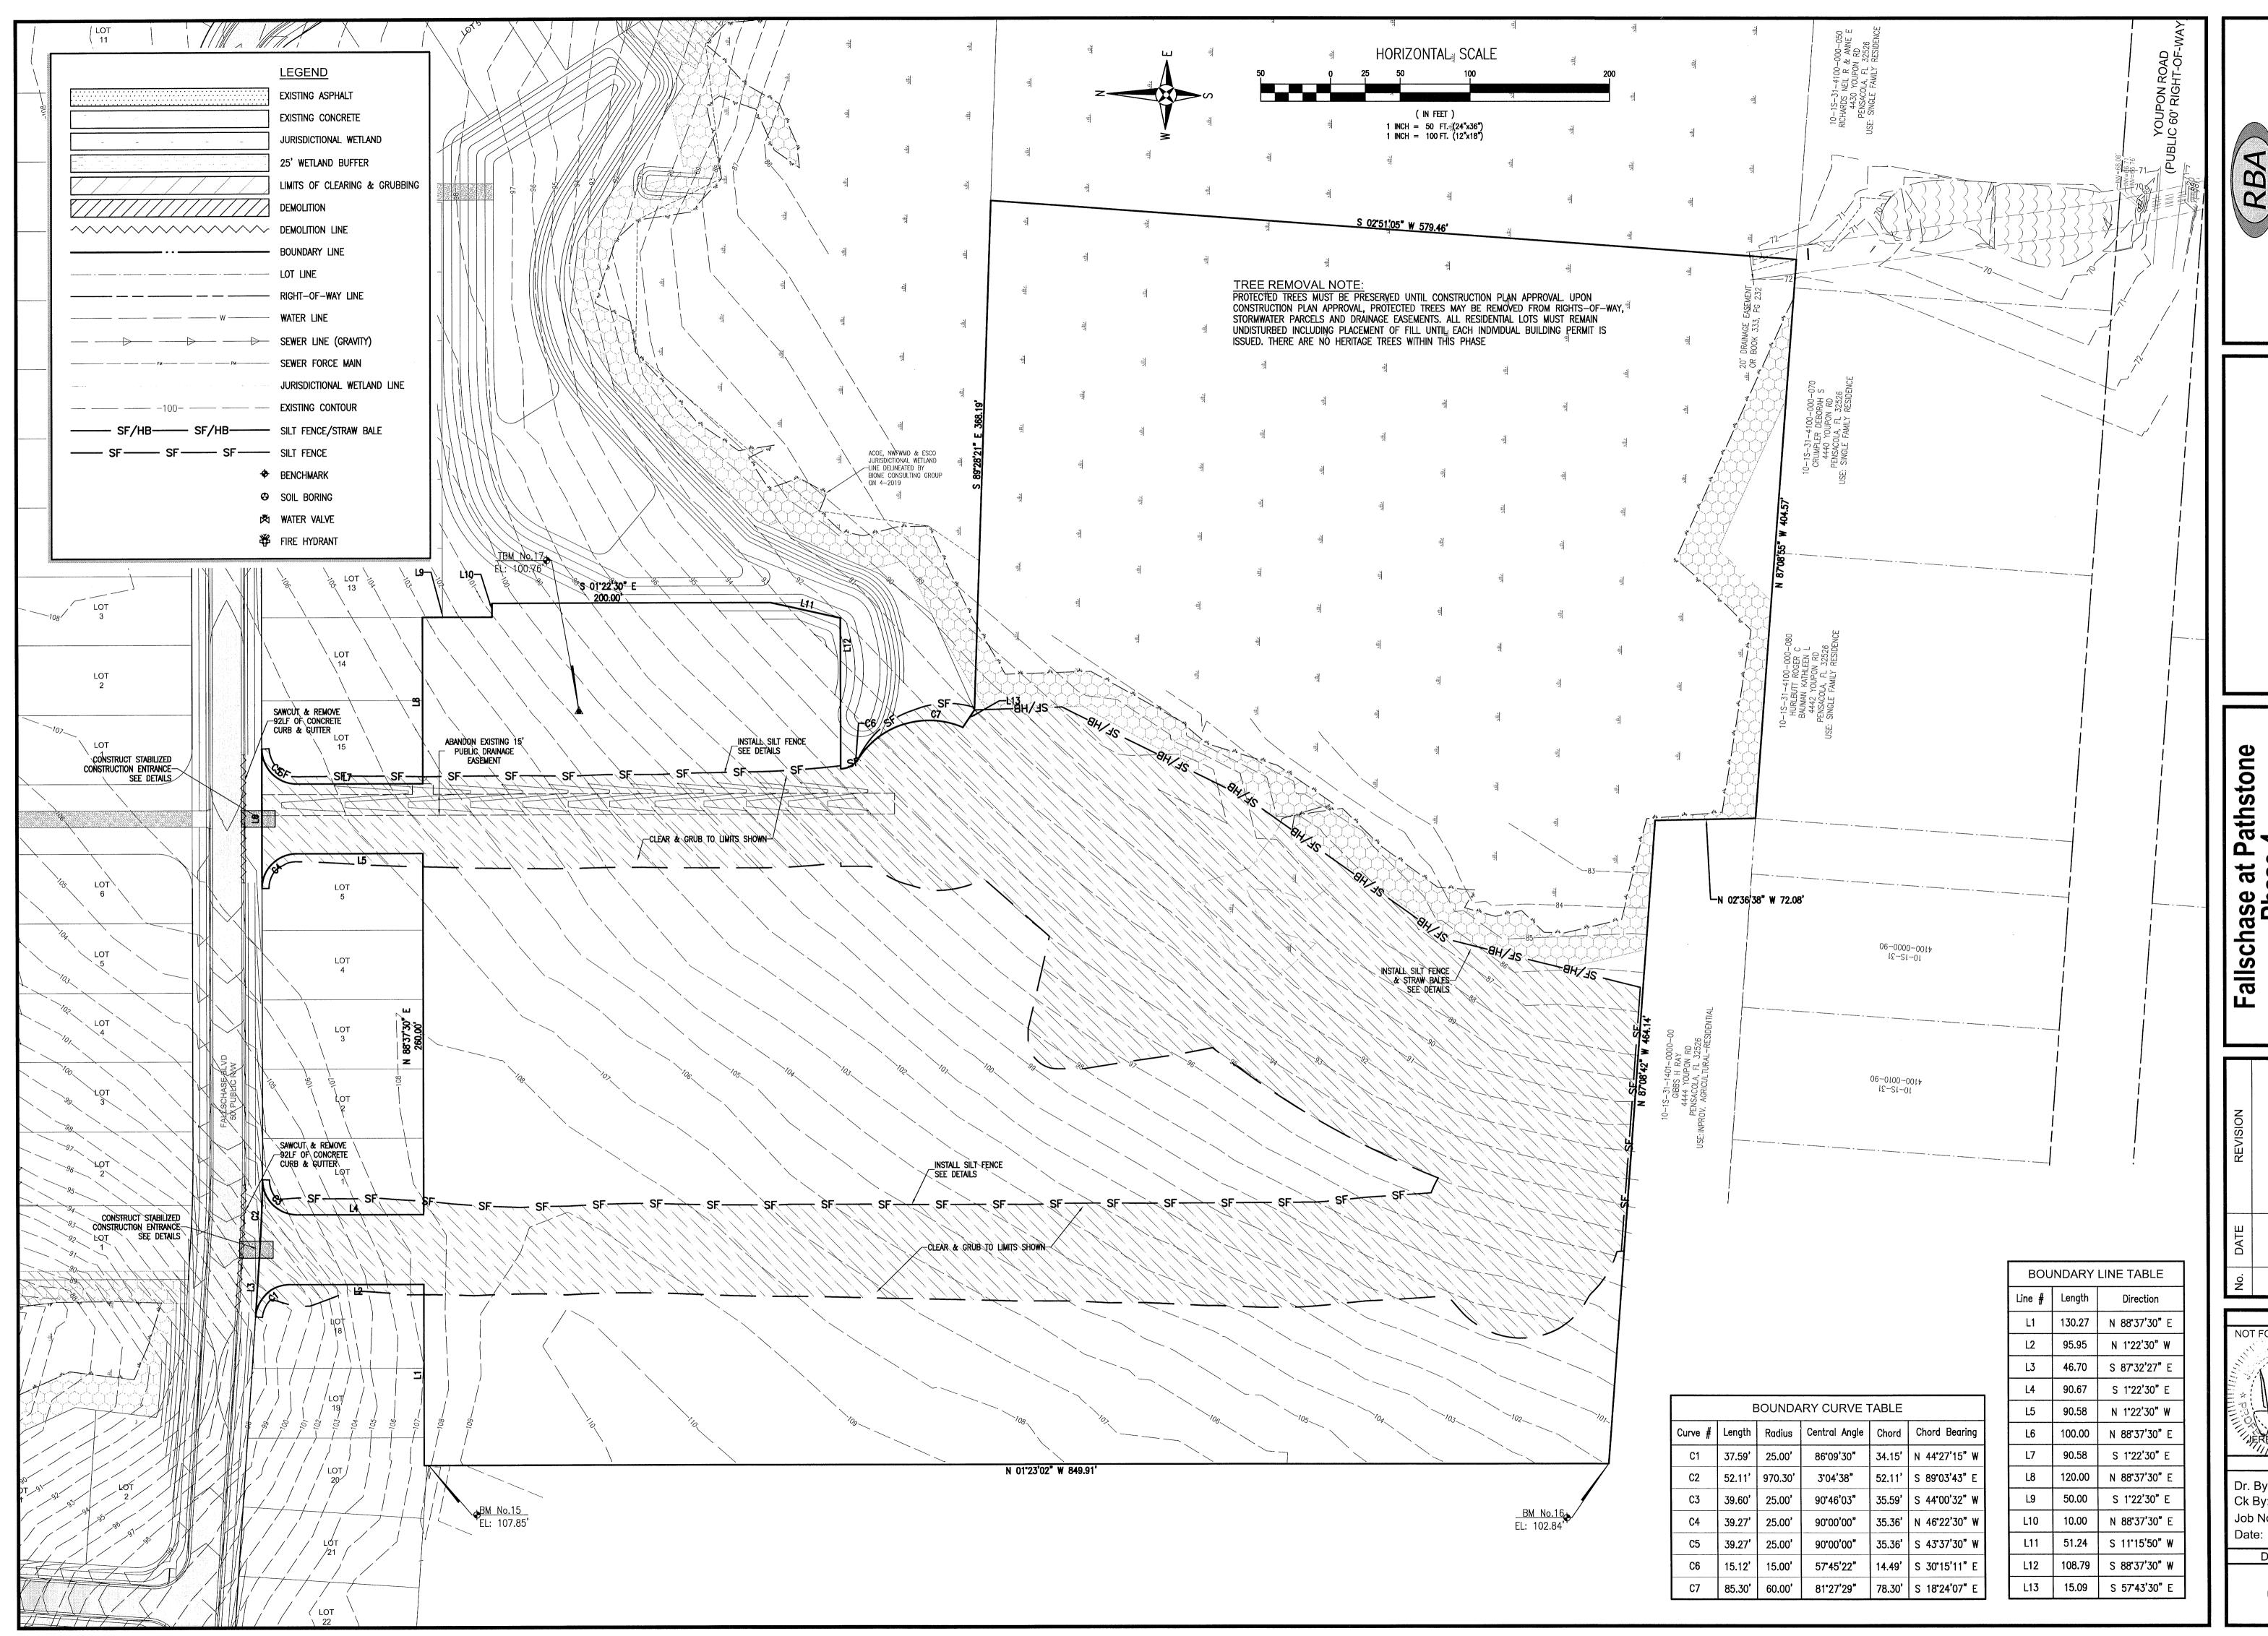
ithston RIDA Sio 0 ase at Pa Phase 4 ot Subdi Mile Roa cha a = |

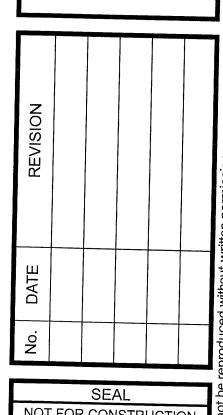

NOT FOR CONSTRUCTION JEREMY R. KING R

Dr. By: CBD Ck By: JRK Job No.: 2017.103 Date: 6/16/2022 DRAWING No.



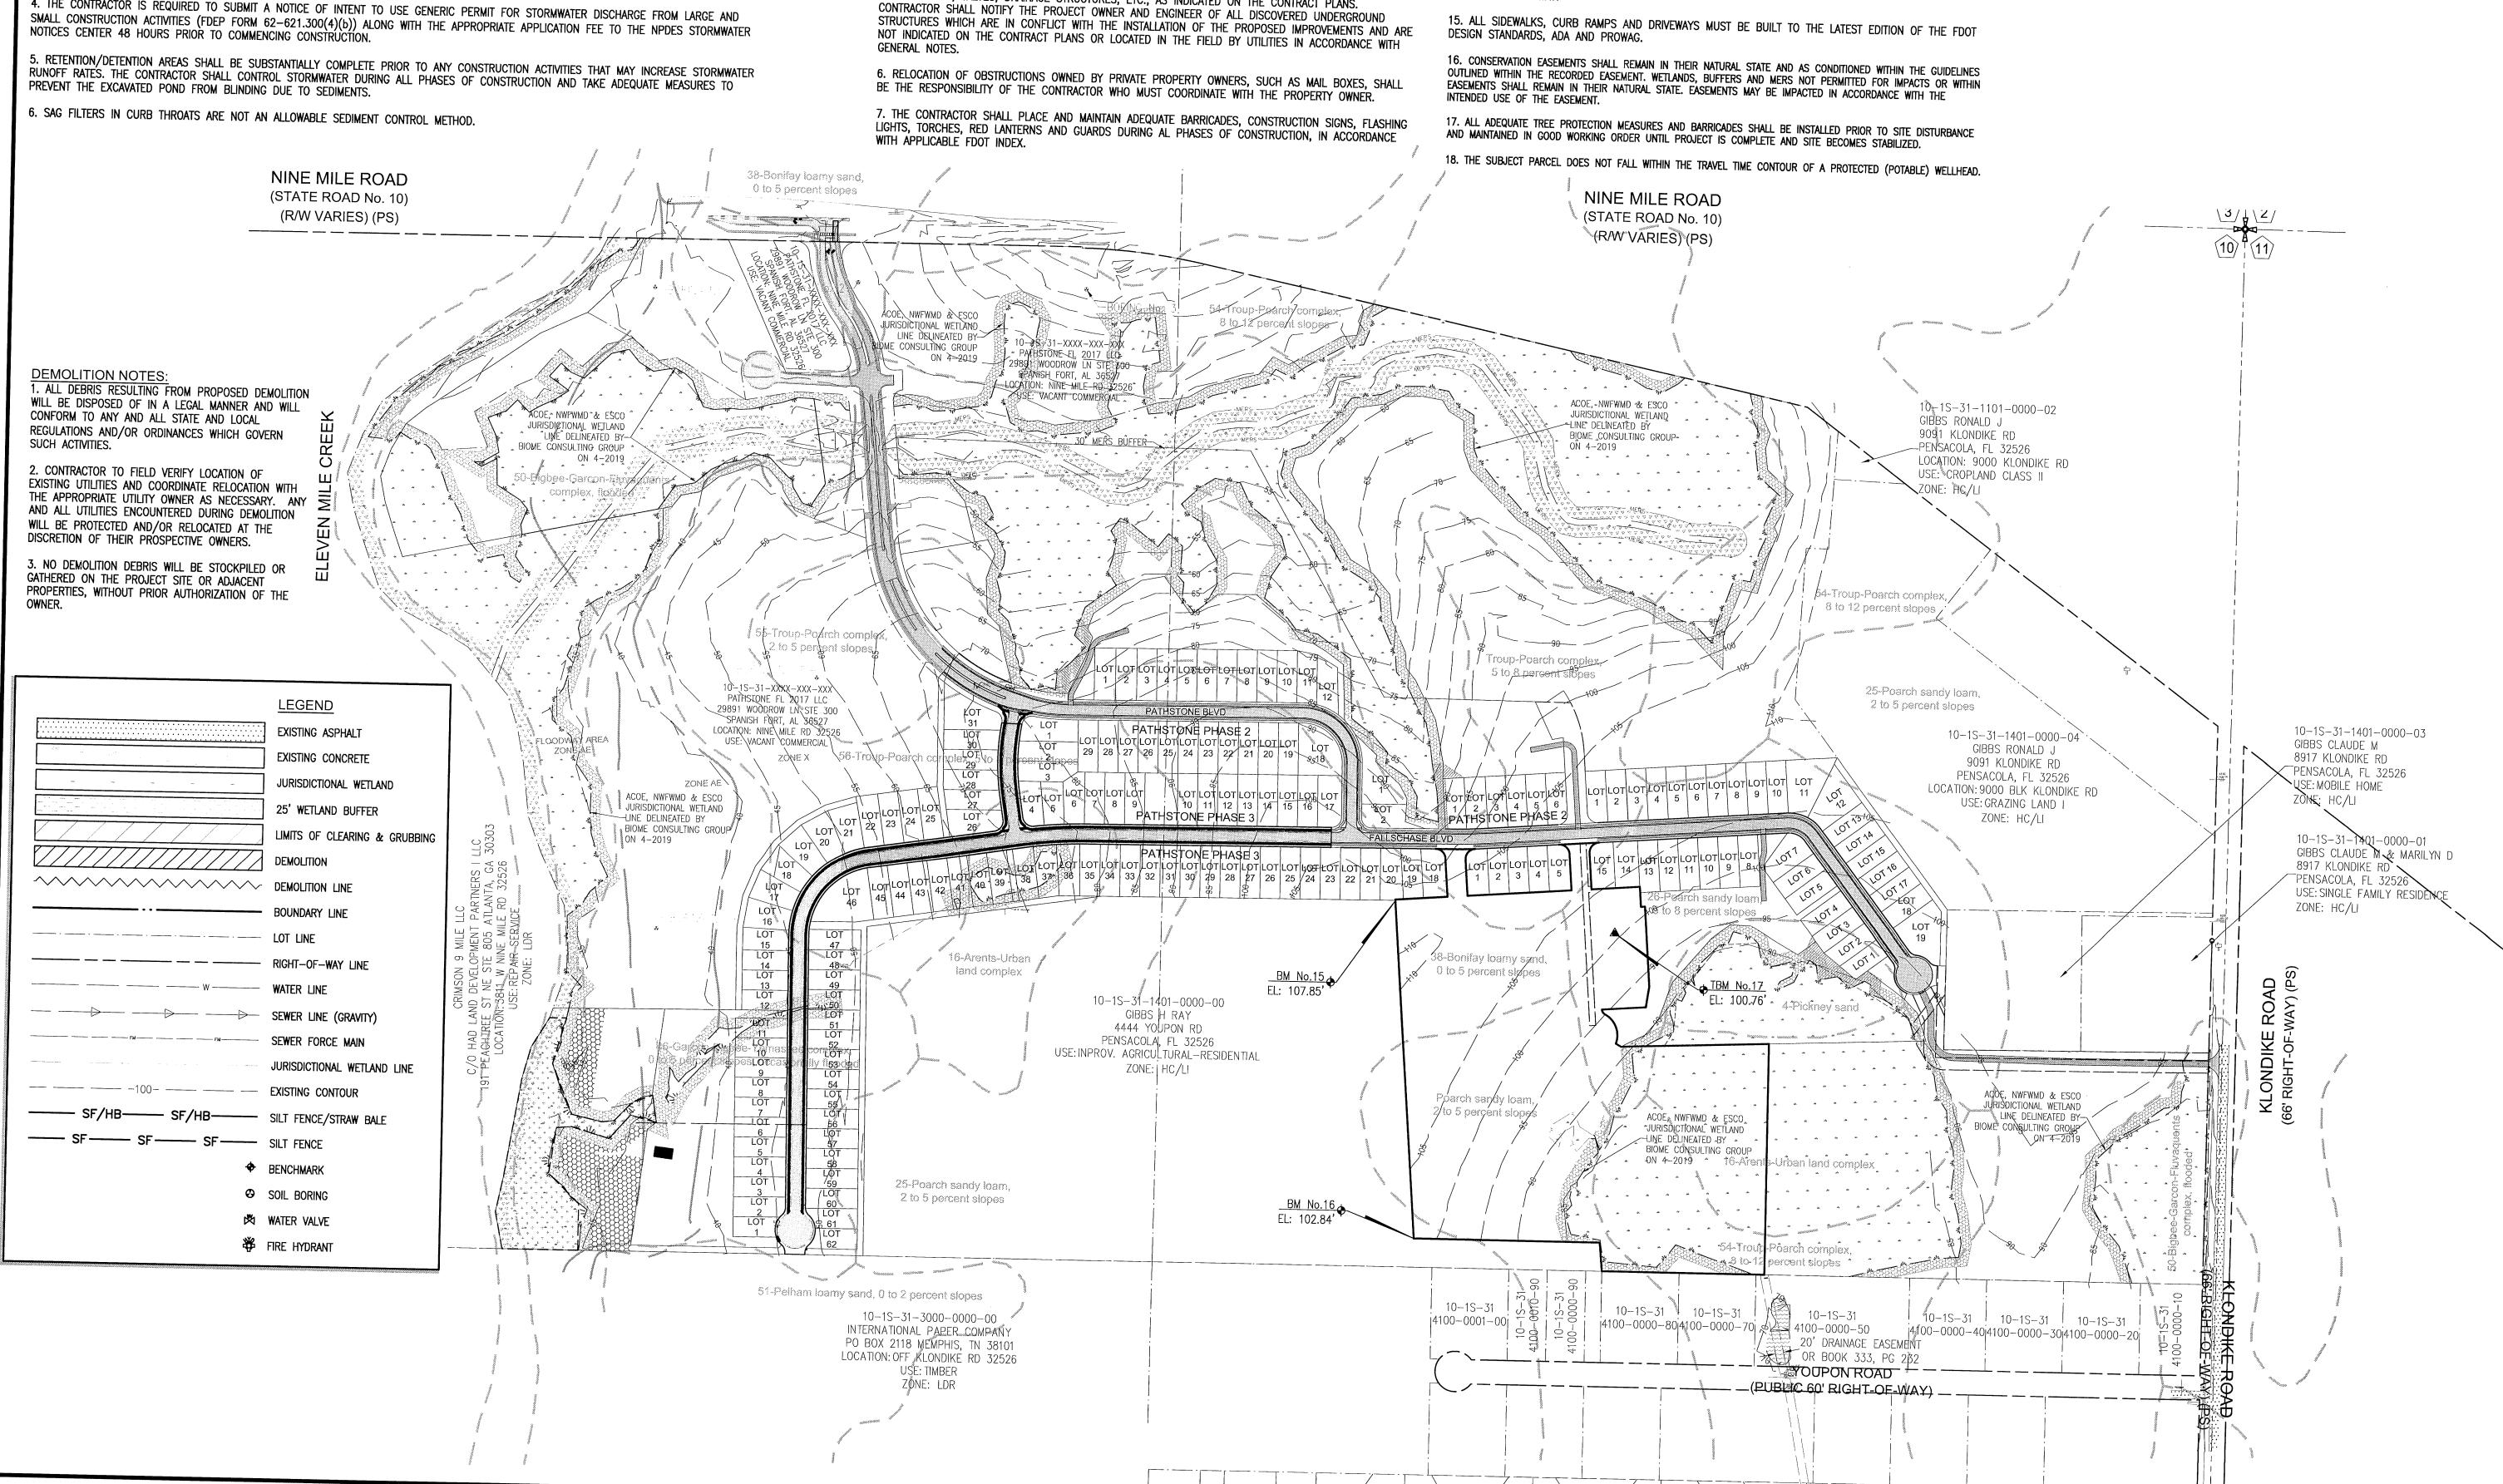

REBOL-BATTLE & ASSOCIATE
Civil Engineers and Surveyors
2301 N. Ninth Avenue, Suite 300
Pensacola, Florida 32503
Telephone 850.438.0400 Fax 850.438.0448

EXISTING SITE, DEMOLITION & EROSION CONTROL PLAN

Fallschase at Pathstone
Phase 4
A 47 Lot Subdivision
9 Mile Road
ESCAMBIA COUNTY, FLORIDA

4o. DATE REVISION

SEAL

NOT FOR CONSTRUCTION

NOT 6144

STATE OF 2011

JEREMY R. KING RE.

Dr. By: CBD
Ck By: JRK
Job No.: 2017.103
Date: 6/16/2022

DRAWING No.

1. ALL EROSION AND SEDIMENT CONTROL PRACTICES TO BE INSTALLED PRIOR TO ANY MAJOR SOIL DISTURBANCE, OR IN THEIR PROPER SEQUENCE, AND MAINTAINED UNTIL PERMANENT PROTECTION IS ESTABLISHED.

2. ANY DISTURBED AREAS THAT WILL BE LEFT EXPOSED MORE THAN 30 DAYS, AND NOT SUBJECT TO CONSTRUCTION TRAFFIC, WILL IMMEDIATELY RECEIVE A TEMPORARY SEEDING. IF THE SEASON PREVENTS THE ESTABLISHMENT OF A TEMPORARY COVER, THE DISTURBED AREAS WILL BE MULCHED WITH STRAW, OR EQUIVALENT MATERIAL, AT A RATE OF TWO (2) TONS PER ACRE, ACCORDING TO STATE STANDARDS.

3. PERMANENT VEGETATION TO BE SEEDED OR SODDED ON ALL EXPOSED AREAS WITHIN TEN (10) DAYS AFTER GRADING. MULCH TO BE USED AS NECESSARY FOR PROTECTION UNTIL SEEDING IS ESTABLISHED.

4. ALL WORK AND MATERIALS TO BE IN ACCORDANCE WITH THE FDOT "STANDARD SPECIFICATIONS FOR ROAD AND BRIDGE CONSTRUCTION", LATEST EDITION, SECTIONS 104, 570, 981, 982, 983, 985, & 987.

\*5. A BITUMINOUS CONCRETE BASE COURSE WILL BE APPLIED IMMEDIATELY FOLLOWING ROUGH GRADING AND INSTALLATION OF IMPROVEMENTS IN ORDER TO STABILIZE STREETS, ROADS, DRIVEWAYS AND PARKING AREAS. IN AREAS WHERE NO UTILITIES ARE PRESENT, THE BITUMINOUS CONCRETE BASE SHALL BE INSTALLED WITHIN 15

\*6. IMMEDIATELY FOLLOWING INITIAL DISTURBANCE OR ROUGH GRADING, ALL CRITICAL AREAS SUBJECT TO EROSION (I.E. STEEP SLOPES AND ROADWAY EMBANKMENTS) WILL RECEIVE A TEMPORARY SEEDING IN COMBINATION WITH STRAW MULCH OR A SUITABLE EQUIVALENT, AT A THICKNESS OF TWO (2) TO FOUR (4) INCHES MIXED WITH THE TOP TWO (2) INCHES OF SOIL, ACCORDING TO STATE STANDARDS.

\*7. ANY STEEP SLOPES RECEIVING PIPELINE INSTALLATION WILL BE BACKFILLED AND STABILIZED DAILY, AS THE INSTALLATION PROCEEDS (I.E. SLOPES GREATER THAN 3:1).

\*8. A CRUSHED LIMEROCK, VEHICLE WHEEL-CLEANING BLANKET SHALL BE INSTALLED AT THE CONTRACTOR'S STAGING YARD AND/OR STOCKPILE AREAS TO PREVENT OFF-SITE TRACKING OF SEDIMENT BY CONSTRUCTION VEHICLES ONTO PUBLIC ROADS. BLANKET SHALL BE 15FT. X 50FT. X 6IN. (MINIMUM), CRUSHED LIMEROCK 2 1/2 INCHES IN DIAMETER. SAID BLANKET SHALL BE UNDERLAIN WITH A FDOT CLASS 3 SYNTHETIC FILTER FABRIC AND MAINTAINED IN GOOD ORDER.

9. AT THE TIME WHEN THE SITE PREPARATION FOR PERMANENT VEGETATIVE STABILIZATION IS GOING TO BE ACCOMPLISHED, ANY SOIL THAT WILL NOT PROVIDE A SUITABLE ENVIRONMENT TO SUPPORT ADEQUATE VEGETATIVE GROUND COVER, SHALL BE REMOVED OR TREATED IN SUCH A WAY THAT WILL PERMANENTLY ADJUST SUITABLE FOR VEGETATIVE GROUND COVER. IF THE REMOVAL OR TREATMENT OF THE SOIL WILL NOT PROVIDE SUITABLE CONDITIONS, NON-VEGETATIVE MEANS OF PERMANENT GROUND STABILIZATION WILL HAVE TO BE

\*10. CONDUIT OUTLET PROTECTION MUST BE INSTALLED AT ALL REQUIRED OUTFALLS PRIOR TO THE DRAINAGE SYSTEM BECOMING OPERATIONAL.

11. UNFILTERED DEWATERING IS NOT PERMITTED. THE CONTRACTOR SHALL TAKE ALL NECESSARY PRECAUTIONS DURING ALL DEWATERING OPERATIONS TO MINIMIZE SEDIMENT TRANSFER.

12. SHOULD THE CONTROL OF DUST AT THE SITE BE NECESSARY, THE SITE WILL BE SPRINKLED UNTIL THE SURFACE IS WET, TEMPORARY VEGETATION COVER SHALL BE ESTABLISHED OR MULCH SHALL BE APPLIED IN ACCORDANCE WITH STATE STANDARDS FOR EROSION CONTROL.

13. ALL SOIL WASHED, DROPPED, SPILLED OR TRACKED OUTSIDE THE LIMIT OF DISTURBANCE OR ONTO PUBLIC RIGHTS-OF-WAY WILL BE REMOVED IMMEDIATELY.

14. THE CONTRACTOR SHALL BE RESPONSIBLE FOR ANY EROSION OR SEDIMENTATION THAT MAY OCCUR BELOW STORMWATER OUTFALLS OR OFFSITE AS A RESULT OF CONSTRUCTION OF THE PROJECT.

15. ALL SOIL STOCKPILES ARE TO BE TEMPORARILY STABILIZED IN ACCORDANCE WITH SOIL EROSION AND SEDIMENT CONTROL NOTE NUMBER 2 (ABOVE). 16. THE SITE SHALL AT ALL TIMES BE GRADED AND MAINTAINED SUCH THAT ALL STORM WATER RUNOFF IS

DIVERTED TO SOIL EROSION AND SEDIMENT CONTROL FACILITIES.

17. ALL SEDIMENTATION STRUCTURES SHALL BE INSPECTED AND MAINTAINED REGULARLY.

18. ALL CATCH BASIN INLETS SHALL BE PROTECTED WITH HAY BALES AS SHOWN ON DETAIL. 19. THE CONTRACTOR SHALL PREPARE A PLAN FOR THE PROPER DEWATERING AND DOWNSTREAM SILTATION PROTECTION OF EACH STREAM CROSSING PRIOR TO EXCAVATING THE STREAM BED. PLAN SHALL BE FORWARDED

20. ANY AREAS USED FOR THE CONTRACTOR'S STAGING, INCLUDING BUT NOT LIMITED TO, TEMPORARY STORAGE OF STOCKPILED MATERIALS (E.G. CRUSHED STONE, QUARRY PROCESS STONE, SELECT FILL, EXCAVATED MATERIALS, ETC.), SHALL BE ENTIRELY PROTECTED BY A SILT FENCE ALONG THE LOW ELEVATION SIDE TO CONTROL SEDIMENT RUNOFF.

TO THE ENGINEER FOR APPROVAL. THE ENGINEER SHALL BE NOTIFIED FOR INSPECTION PRIOR TO EACH STREAM

\* WHERE APPLICABLE

CROSSING CONSTRUCTION.

#### TEMPORARY SEEDING DETAILS:

SEED BED PREPARATION:

SOIL TO BE THOROUGHLY PULVERIZED BY DISK-HARROWING AND BE LOOSE AND REASONABLY SMOOTH. APPLY FERTILIZER AT A RATE OF 260 LBS/ACRE OF 16-16-16 OR EQUIVALENT, APPLY DOLOMITIC LIMESTONE AT A RATE OF 800 TO 1000 LBS./ACRE TO PROVIDE A SOIL pH OF 5.5 TO 6.5, LIME & FERTILIZER TO BE WORKED INTO THE TOPSOIL TO A DEPTH OF 4". ADD SANDY LOAM TOPSOIL TO A MINIMUM OF TWO (2) INCHES WHERE REQUIRED.

SEED MIXTURE

CONSISTING OF ANNUAL RYE (LOLIUM MULTIFLORUM) AT A RATE OF 174 LBS/ACRE.

#### PERMANENT SEEDING DETAILS:

SEED BED PREPARATION:

SOIL TO BE THOROUGHLY PULVERIZED BY DISK-HARROWING AND BE LOOSE AND REASONABLY SMOOTH. APPLY FERTILIZER AT A RATE OF 260 LBS/ACRE OF 16-16-16 OR EQUIVALENT, APPLY DOLOMITIC LIMESTONE AT A RATE OF 800 TO 1000 LBS./ACRE TO PROVIDE A SOIL pH OF 5.5 TO 6.5, LIME & FERTILIZER TO BE WORKED INTO THE TOPSOIL TO A DEPTH OF 4". ADD SANDY LOAM TOPSOIL TO A MINIMUM OF TWO (2) INCHES WHERE REQUIRED.

SEED MIXTURE CONSISTING OF <u>RATE</u> <u>Purity</u> <u>GERMINATION</u> 260 LBS/AC. 95% 80% ARGENTINE BAHIA 260 LBS/AC. 95% 40%(MIN.) - 80%(TOTAL)PENSACOLA BAHIA

SOD SHALL BE WELL ROOT MATTED CENTIPEDE OR BAHIA GRASS COMMERCIALLY CUT TO A MINIMUM DIMENSION OF 12" x 24" A MAXIMUM OF 72 HOURS PRIOR TO PLACEMENT. SOD SHALL BE LIVE, FRESH AND UNINJURED, REASONABLY FREE OF WEEDS AND OTHER GRASSES, WITH A HEAVY SOIL MAT ADHERING TO THE ROOT SYSTEM. SOD SHALL BE GROWN, CUT, AND SUPPLIED BY A STATE CERTIFIED GROWER.

TRAFFIC CONTROL STANDARDS:

1. CONSTRUCTION TRAFFIC SHALL BE RESTRICTED TO ONSITE ACCESS BY MEANS SO DESIGNATED BY THE ENGINEER, POLICE/SHERIFF DEPARTMENT, ESCAMBIA COUNTY HIGHWAY DEPARTMENT, AND/OR THE FLORIDA DEPARTMENT OF TRANSPORTATION.

2. TRAFFIC DURING WET WEATHER SHALL BE MINIMIZED AND APPROPRIATE ROADWAY AND SITE CLEAN-UP SHALL BE PROVIDED BY THE CONTRACTOR AS SOON AS WEATHER CONDITIONS PERMIT.

1. DAMAGED TRUNKS OR EXPOSED ROOTS WILL BE PAINTED IMMEDIATELY WITH A GOOD GRADE OF "TREE

2. TREE LIMB REMOVAL, WHERE NECESSARY, WILL BE DONE FLUSH TO TRUNK OR MAIN BRANCH AND THAT AREA PAINTED IMMEDIATELY WITH A GOOD GRADE OF TREE PAINT.

1. ALL AREAS OF CLEARING AND EMBANKMENT AS WELL AS CONSTRUCTION HAUL ROADS SHALL BE TREATED AND MAINTAINED IN SUCH A MANNER AS TO MINIMIZE ANY DUST GENERATION.

2. DISTURBED AREAS SHALL BE MAINTAINED IN A ROUGH GRADED CONDITION AND TEMPORARILY SEEDED AND/OR MULCHED UNTIL PROPER WEATHER CONDITIONS EXIST FOR THE ESTABLISHMENT OF PERMANENT VEGETATION COVER.

3. IN EVENT OF EMERGENCY CONDITIONS, TILLAGE WILL BE SATISFACTORY FREE BEFORE SOIL BLOWING STARTS.

4. CALCIUM CHLORIDE MAY BE APPLIED TO UNPAVED ROADWAY AREAS, ONLY, SUBJECT TO THE ENGINEER'S APPROVAL AND CONFORMANCE WITH FDOT STANDARD SPECIFICATIONS, SECTION 104, LATEST EDITION.

PROPOSED SEQUENCE OF CONSTRUCTION:

THE INSTALLATION OF ALL SEDIMENT AND EROSION CONTROL DEVICES THAT CAN BE PLACED PRIOR TO ANY MAJOR SOIL DISTURBANCES.

CLEAR AND REMOVE ALL EXISTING VEGETATION IN THOSE AREAS WHERE NECESSARY. ALL REMAINING VEGETATION IS TO BE PROPERLY PROTECTED AND IS TO REMAIN IN ITS NATURAL STATE. TOPSOIL IN AREAS TO BE DISTURBED IS TO BE STRIPPED TO A MINIMUM DEPTH OF SIX (6) INCHES AND STOCKPILED SEPARATELY FROM OTHER EXCAVATED SOIL(S)

5. THE IMMEDIATE INSTALLATION OF ALL REMAINING SEDIMENT AND EROSION CONTROL DEVICES.

4. PERFORM ALL DEMOLITION WORK.

FILTER FABRIC

(SEE GENERAL NOTE 8)

. CONSTRUCT ROUGH GRADING OF STORMWATER PONDS.

6. CONSTRUCT ALL UNDERGROUND UTILITIES AND STORM DRAIN SYSTEMS.

7. CONSTRUCT ROADS (SUBGRADE, CURB & GUTTER, BASE, PAVEMENT, SIDEWALKS AND LANDSCAPING).

UPON THE COMPLETION OF THE CONSTRUCTION ACTIVITIES, PROVIDE RESTORATION, FINE GRADE REMAINDER OF SITE, RESPREAD STOCKPILED TOPSOIL AND STABILIZE WITH PERMANENT VEGETATIVE COVER AND

BETWEEN STABILIZED CONSTRUCTION

ENTRANCE AND PUBLIC R.O.W.

9. COMPLETE STORMWATER PONDS I.E. INSTALL UNDERDRAIN SYSTEM.

10. THE REMOVAL OF APPROPRIATE TEMPORARY SEDIMENT AND EROSION CONTROL DEVICES.

STABILIZED CONSTRUCTION

**ENTRANCE DETAIL** 

ALL PROTECTED TREES AS SHOWN ON THE PLANS TO REMAIN ARE TO BE PROTECTED DURING CONSTRUCTION.

THE CONTRACTOR SHALL INSTALL ORANGE CONSTRUCTION

FENCING AT THE DRIP LINE OF EACH PROTECTED TREE

TREE BARRICADE DETAIL

N.T.S.

FILTER BAGS WILL BE USED AS AN EFFECTIVE FILTER MEDIUM TO CONTAIN SAND, SILT

WETLAND FILTER BAGS MAY REPLACE HAY BALE CORRALS DURING TRENCH DEWATERING,

CUTTING A SMALL HOLE IN THE CORNER OF THE BAG, INSERTING THE PUMP DISCHARGE

HOSE, AND THEN SECURING THE DISCHARGE HOSE TO THE BAG WITH A HOSE CLAMP.

FILTER BAGS WILL BE PLACED AS FAR AWAY FROM FLOWING STREAMS AND WETLANDS

PRIOR TO REMOVING A BAG FROM THE HOSE, THE BAG WILL BE TIED OFF BELOW THE

END OF THE HOSE ALLOWING THE BAG TO DRAIN. DRAINAGE WILL NOT BE ALLOWED

THROUGH THE INLET HOLE. TO AVOID RUPTURE, THE BAGS WILL BE ATTENDED AND

PUMPING RATES MONITORED. ONCE THE BAG IS INFLATED TO A HEIGHT OF 4 FEET,

WILL BE BUNDLED AND REMOVED FOR PROPER DISPOSAL.

PUMPING WILL STOP TO AVOID RUPTURE. FILTER BAGS USED DURING CONSTRUCTION

FILTER BAGS ARE CONSTRUCTED OF NON-WOVEN GEOTEXTILE FABRIC. A MAXIMUM OF

ONE SIX INCH DISCHARGE HOSE WILL BE ALLOWED PER FILTER BAG. BAG CAPACITY

WILL BE EXCEEDED BEYOND 2,000 GALLONS PER MINUTE. TYPICAL BAG DIMENSIONS

FILTER BAGS WILL BE ENCIRCLED WITH A HAY BALE OR SILT FENCE CORRAL. HOSE

CLAMPS WILL BE USED TO SECURE THE DISCHARGE HOSE, WIRE OR STRING WILL NOT

ARE 15 FEET BY 13.25 FEET. TO HELP PREVENT PUNCTURES, GEOTEXTILE FABRIC WILL

BE PLACED BENEATH THE FILTER BAG WHEN USED IN WOODED LOCATIONS. UNATTENDED

AT THE DISCRETION OF THE ENGINEER INSPECTOR. TO INSURE PROPER INSTALLATION,

FILTER BAGS WILL BE PLACED ON RELATIVELY FLAT TERRAIN FREE OF BRUSH AND

STUMPS TO AVOID RUPTURES AND PUNCTURES. PROPER INSTALLATION REQUIRES

AND FINES WHEN TRENCH DEWATERING. THE WETLAND FILTER BAG CONTAINS THESE


MATERIALS WHILE ALLOWING THE WATER TO FLOW THROUGH THE FABRIC.

AS POSSIBLE.

BE USED.


BEFORE WORKING IN THE VICINITY OF THE TREE.

N.T.S.

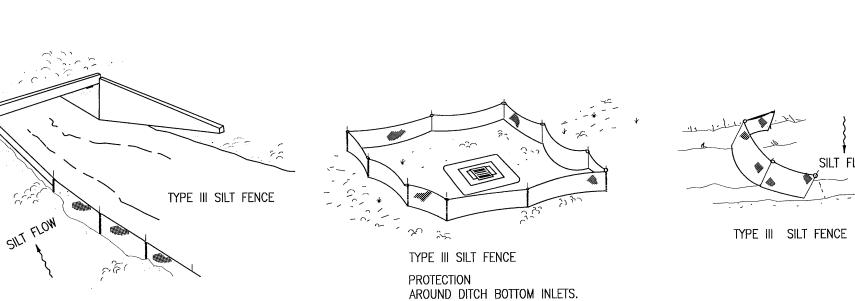


SILT FENCE APPLICATIONS

DO NOT DEPLOY IN A MANNER THAT SILT FENCES WILL ACT AS A DAM ACROSS PERMANENT FLOWING WATERCOURSES. SILT FENCES ARE TO BE USED AT UPLAND LOCATIONS AND TURBIDITY BARRIERS USED AT PERMANENT BODIES OF WATER.

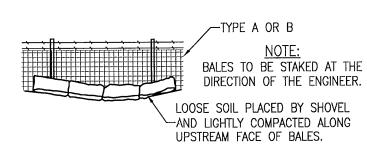

STRAW BALES BACKED BY FENCE

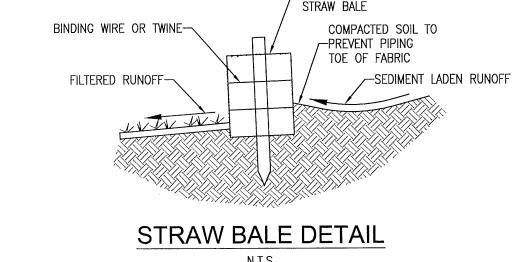

COMPACTED SOIL-

SILT FENCE DETAIL

STAKED &

--ENTRENCHED

FIBERTEX (OR

APPROVED EQUAL).

MATERIAL ATTACHED

TO WIRE FENCE

2"x4" OR 3"ø TREATED


-TIMBER POST @ 6' O.C.

TO BE USED AT SELECTED SITES WHERE THE NATURAL GROUND SLOPES TOWARD THE TOE OF SLOPE

**ELEVATION** 

ANCHOR BALES WITH


STAKES PER BALE.

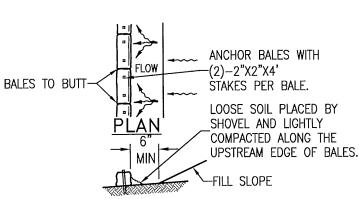

**ELEVATION** 


TO BE USED AT SELECTED SITES WHERE THE NATURAL GROUND SLOPES AWAY FROM THE TOE OF SLOPE

BARRIERS FOR FILL SLOPES N.T.S.

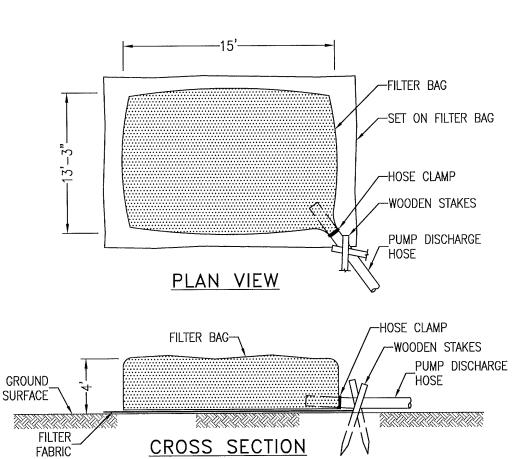

FILTER BAG DETAIL FOR TRENCH DEWATERING OPERATIONS


N.T.S.

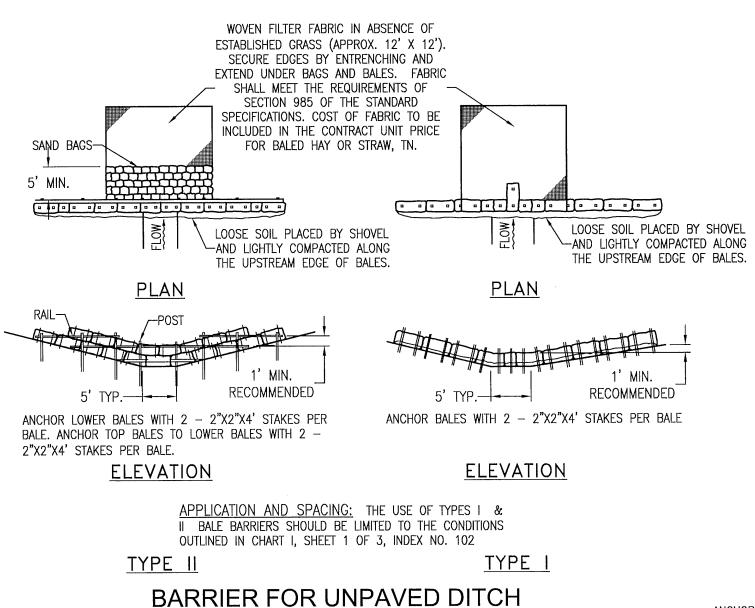

N.T.S. LOOSE SOIL PLACED BY SHOVEL AND LIGHTLY COMPACTED ALONG UPSTREAM ANCHOR BALES WITH EDGE OF BALES. (2)-2"X2"X4'-MIN. RECOMMENDED STAKES PER BALE. ELEVATION

BALE BARRIERS FOR PAVED DITCHES SHOULD BE SPACED IN ACCORDANCE WITH CHART I, SHEET 1 OF 3, INDEX NO. 102 BARRIER FOR PAVED DITCH N.T.S.

PARTIAL INLET

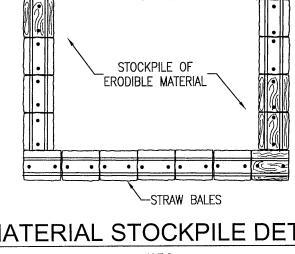


ANCHOR PINS


/-No. 5 STEEL BARS

TWO PER STRAW BALE

MATERIAL STOCKPILE DETAIL

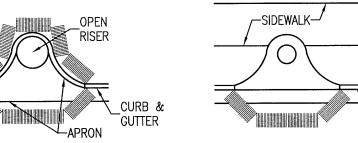


COMPLETED INLET

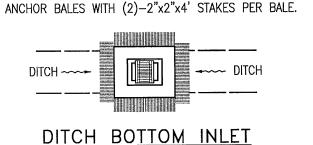

PROTECTION AROUND INLETS OR SIMILAR STRUCTURES

CONTROL ROSION

C 

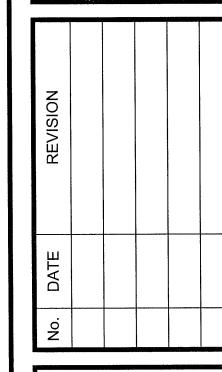

NOT FOR CONSTRUCTION JEREMY-R. KING R.F

Dr. By: CBD Ck By: JRK Job No.: 2017.103

Date: 6/16/2022 DRAWING No.

#### 1.0 BACKGROUND & REQUIREMENTS:

#### 1.1 INTRODUCTION:

THE REFERENCED SUPPORT DOCUMENTATION FOR THIS STORM WATER POLLUTION PREVENTION PLAN (SWPPP) IS THE UNITED STATES ENVIRONMENTAL PROTECTION AGENCY'S (EPA) STORM WATER MANAGEMENT FOR CONSTRUCTION ACTIVITIES, DEVELOPING POLLUTION PREVENTION PLANS AND BEST MANAGEMENT PRACTICES SUMMARY GUIDANCE (EPA 833-R-92-001) AND STORM WATER MANAGEMENT FOR CONSTRUCTION ACTIVITIES, DEVELOPING POLLUTION PREVENTION PLANS AND BEST MANAGEMENT PRACTICES (EPA 832-R-92-005). THIS SWPPP IS DESIGNED TO PROTECT ONSITE AND ADJACENT NATURAL RESOURCES, INCLUDING BUT NOT LIMITED TO, WETLANDS, MARSHES, BAYOUS AND BAYS, WHILE PRESERVING WILDLIFE AND ARCHEOLOGICAL RESOURCES.

AN ENVIRONMENTAL RESOURCE PERMIT APPLICATION WILL BE SUBMITTED TO THE NWFWMD JUNE 2018

#### 1.2 NOTICE OF INTENT (NOI):

RULE 62-621.300(4), FAC REQUIRES THE CONSTRUCTION OPERATOR OF A SITE THAT DISTURBS ONE OR MORE ACRES TO OBTAIN COVERAGE FROM THE GENERIC PERMIT FOR STORMWATER DISCHARGE FROM LARGE AND SMALL CONSTRUCTION ACTIVITIES. THE CONTRACTOR IS REQUIRED TO SUBMIT A NOTICE OF INTENT TO USE GENERIC PERMIT FOR STORMWATER DISCHARGE FROM LARGE AND SMALL CONSTRUCTION ACTIVITIES (FDEP FORM 62-621.300(4)(B)) ALONG WITH THE APPROPRIATE APPLICATION FEE TO THE FOLLOWING ADDRESS 48 HOURS PRIOR TO COMMENCING CONSTRUCTION:

NPDES STORMWATER NOTICES CENTER, MS # 2510 FLORIDA DEPARTMENT OF ENVIRONMENTAL PROTECTION 2600 BLAIR STONE ROAD TALLAHASSEE, FLORIDA 32399-2400

THIS FORM CAN BE OBTAINED FROM FDEP'S WEBSITE (WWW.DEP.STATE.FL.US) OR BY CONTACTING FDEP. PLEASE NOTE THAT THE CURRENT APPLICATION FEE IS \$300; HOWEVER, THIS FEE IS SUBJECT TO CHANGE WITHOUT NOTICE. ALWAYS REFER TO THE MOST CURRENT VERSION OF RULE 62-4.050(4)(D), FAC TO CONFIRM THE AMOUNT BEFORE SUBMITTING PAYMENT. IF CONSTRUCTION ACTIVITY EXCEEDS FIVE YEARS, THE CONTRACTOR MUST RE-APPLY FOR COVERAGE.

#### 1.3 STORMWATER POLLUTION PREVENTION PLAN (SWPPP):

THE CONTRACTOR IS REQUIRED TO CERTIFY THIS STORMWATER POLLUTION PREVENTION PLAN (SWPPP) BELOW PRIOR TO SUBMITTING THE NOI. THIS SWPPP IS NOT REQUIRED TO BE SUBMITTED WITH THE NOI, BUT IS REQUIRED TO BE KEPT ON SITE DURING ALL PHASES OF CONSTRUCTION. BECAUSE EROSION AND SEDIMENT CONTROLS AND CONSTRUCTION METHODS VARY SIGNIFICANTLY FROM CONTRACTOR TO CONTRACTOR, THE CONTRACTOR CAN PROPOSE ALTERNATIVE METHODS TO THIS SWPPP THAT ARE EQUAL OR BETTER AT CONTROLLING EROSION AND SEDIMENTATION. AT A MINIMUM, THE CONTRACTOR MUST FOLLOW THE EROSION CONTROL PLAN SPECIFIED IN THE CONSTRUCTION PLANS AND DOCUMENTS. ANY MODIFICATIONS TO THIS SWPPP MUST BE DOCUMENTED AND KEPT WITH THE PLAN AS PART OF THE RECORDS KEEPING PROCESS TO BE IN FULL COMPLIANCE WITH THE CGP.

### 1.4 CONTRACTOR'S / SUBCONTRACTOR CERTIFICATION:

I CERTIFY UNDER PENALTY OF LAW THAT I UNDERSTAND, AND SHALL COMPLY WITH, THE TERMS AND CONDITIONS OF THE STATE OF FLORIDA GENERIC PERMIT FOR STORMWATER DISCHARGE FROM LARGE AND SMALL CONSTRUCTION ACTIVITIES AND THIS STROMWATER POLLUTION PREVENTION PLAN PREPARED THEREUNDER.

PRINT & SIGN NAME		COMPANY & ADDRESS
NAME & TITLE (PRINT)		
SIGNATURE	DATE	

#### 1.5 RESPONSIBLE AUTHORITY CERTIFICATION:

SIGNATURE

I CERTIFY UNDER PENALTY OF LAW THAT THIS DOCUMENT AND ALL ATTACHMENTS WERE PREPARED UNDER MY DIRECTION OR SUPERVISION IN ACCORDANCE WITH A SYSTEM DESIGNED TO ASSURE THAT QUALIFIED PERSONNEL GATHERED AND EVALUATED THE INFORMATION SUBMITTED. BASED ON MY INQUIRY OF THE PERSON OR PERSONS WHO MANAGE THE SYSTEM, OR THOSE PERSONS DIRECTLY RESPONSIBLE FOR GATHERING THE INFORMATION, THE INFORMATION SUBMITTED IS, TO THE BEST OF MY KNOWLEDGE AND BELIEF, TRUE, ACCURATE, AND COMPLETE. I AM AWARE THAT THERE ARE SIGNIFICANT PENALTIES FOR SUBMITTING FALSE INFORMATION, INCLUDING THE POSSIBILITY OF FINE AND IMPRISONMENT FOR KNOWING VIOLATIONS.

PRINT & SIGN NAME	COMPANY & ADDRESS
NAME & TITLE (PRINT)	

#### 1.6 NOTICE OF TERMINATION (NOT):

THE CONTRACTOR IS REQUIRED TO SUBMIT A NOTICE OF TERMINATION OF GENERIC PERMIT COVERAGE (FDEP FORM 62-621.300(6)) UPON CONSTRUCTION COMPLETION TO DISCONTINUE PERMIT COVERAGE. THE NOT IS TO BE SUBMITTED TO THE FOLLOWING ADDRESS:

NPDES STORMWATER NOTICES CENTER, MS # 2510 FLORIDA DEPARTMENT OF ENVIRONMENTAL PROTECTION 2600 BLAIR STONE ROAD TALLAHASSEE, FLORIDA 32399-2400

THIS FORM CAN BE OBTAINED FROM FDEP'S WEBSITE (WWW.DEP.STATE.FL.US) OR BY CONTACTING FDEP. THE NOT CAN NOT BE SUBMITTED UNTIL ALL DISTURBED SOILS AT THE CONSTRUCTION SITE HAVE BEEN FINALLY STABILIZED AND TEMPORARY EROSION AND SEDIMENT CONTROL MEASURES HAVE BEEN REMOVED OR WILL BE REMOVED AT AN APPROPRIATE TIME. FINAL STABILIZATION MEANS THAT ALL SOIL DISTURBING ACTIVITIES AT THE SITE HAVE BEEN COMPLETED AND THAT A UNIFORM PERENNIAL VEGETATIVE COVER WITH A DENSITY OF 70 PERCENT OF THE COVER FOR UNPAVED AREAS AND AREAS NOT COVERED BY PERMANENT STRUCTURES HAS BEEN ESTABLISHED, OR EQUIVALENT STABILIZATION MEASURES HAVE BEEN EMPLOYED. IF CONSTRUCTION ACTIVITY EXCEEDS FIVE YEARS, THE CONTRACTOR MUST RE—APPLY FOR COVERAGE.

#### 1.7 APPLICATION INFORMATION:

PROJECT ADDRESS:

NINE MILE ROAD PENSACOLA, FL 32526

LATITUDE: LONGITUDE: N 30.528982° W 87.335724°

WATER MANAGEMENT DISTRICT:

NORTHWEST FLORIDA (NWFWMD)

MS4 OPERATOR NAME:

RECEIVING WATER NAME:

ESCAMBIA COUNTY

ELEVEN MILE CREEK

#### 2.0 SITE DESCRIPTION:

#### 2.1 NATURE OF CONSTRUCTION ACTIVITIES:

THIS PROJECT INVOLVES THE CONSTRUCTION OF A PHASED RESIDENTIAL AND COMMERCIAL SUBDIVISION. CONSTRUCTION INCLUDES ROADS, UTILITIES AND STORMWATER COLLECTION SYSTEMS.

#### 2.2 SEQUENCE OF MAJOR SOIL DISTURBING ACTIVITIES:

THE FOLLOWING SEQUENCE OF MAJOR ACTIVITIES SHALL BE FOLLOWED UNLESS THE CONTRACTOR CAN PROPOSE AN ALTERNATIVE THAT IS EQUAL TO OR BETTER AT CONTROLLING EROSION AND SEDIMENTATION. THE DETAILED SEQUENCE FOR THE ENTIRE PROJECT CAN VARY SIGNIFICANTLY FROM CONTRACTOR TO CONTRACTOR. THE CONTRACTOR IS RESPONSIBLE FOR DOCUMENTING ANY CHANGES.

- 1. CLEAR, GRUB AND PERFORM ALL DEMOLITION WORK.
- 2. COMPLETE ROUGH GRADING OF THE POND AND DIRECT ALL STORMWATER RUNOFF TO THE POND(S).
- 3. CONSTRUCT ALL UNDERGROUND UTILITIES AND STORM DRAIN SYSTEM.
- 4. CONSTRUCT ROADS (SUBGRADE, CURB & GUTTER, BASE, PAVEMENT, SIDEWALKS, AND LANDSCAPING).
- 5. COMPLETE STORMWATER PONDS.
- 2.3 AREA ESTIMATES:

ONSITE AREA: OFFSITE AREA: TOTAL AREA: AREA TO BE DISTURBED:

8.49 ACRES 1.73 ACRES 10.22 ACRES 4.50 ACRES

#### 2.4 RUNOFF DATA:

RUNOFF COEFFICIENTS (C):

BEFORE: TOTAL COMPOSITE C = 0.20

OURING: VARIES BETWEEN = 0.20 AND 0.61

AFTER: TOTAL COMPOSITE = 0.61

SOILS DATA:
THE SOILS LOCATED AT THE SITE ARE PREDOMINATELY VERY LOOSE TO LOOSE SLIGHTLY SILTY SANDS. GROUNDWATER WAS NOT ENCOUNTERED IN THE 15 FT TO 20 FT DEEP TEST BORING. FOR MORE DETAILED SOILS INFORMATION, REFER TO THE GEOTECHNICAL SERVICES REPORT PREPARED BY UNIVERSAL ENGINEERING SERVICES.

DRAINAGE AREAS FOR EACH OUTFALL:

OUTFALL LOCATION TOTAL AREA FLOWING TO POND(S) 'C' COEFFICIENT POND G 10.22 0.61

#### 2.5 SITE MAP:

- THE CONSTRUCTION PLANS ARE TO BE USED AS THE SITE MAPS. THE LOCATION OF THE REQUIRED INFORMATION IS DESCRIBED BELOW. THE SHEET NUMBERS FOR ALL THE ITEMS DISCUSSED BELOW ARE IDENTIFIED ON THE KEY SHEET OF THE CONSTRUCTION PLANS.
- <u>Drainage Patterns:</u> all drainage patterns are shown on the grading & drainage plans.
- <u>APPROXIMATE SLOPES:</u> APPROXIMATE SLOPES ARE SHOWN ON THE GRADING & DRAINAGE POND SIDE SLOPES ARE SHOWN ON THE POND CROSS—SECTIONS.
- AREAS OF SOIL DISTURBANCE: ALL DEMOLITION IS SHOWN ON THE EXISTING SITE CONDITIONS AND DEMOLITION AND EROSION CONTROL PLAN SHEET. ALL PROPOSED CONSTRUCTION IS SHOWN ON THE REMAINING PLANS. ANY AREAS WHERE DEMOLITION WORK OR PERMANENT FEATURES ARE SHOWN ABOVE OR BELOW GROUND WILL BE DISTURBED.
- AREAS NOT TO BE DISTURBED: ANY AREAS NOT SHOWING DEMOLITION WORK OR PERMANENT FEATURES ARE ASSUMED NOT TO BE DISTURBED. IT WILL BE THE CONTRACTOR'S RESPONSIBILITY TO INDICATE ON THE PLANS ANY OF THESE AREAS THAT DO GET DISTURBED AS WELL AS ANY AREAS USED FOR STAGING AND MATERIALS STORAGE.
- LOCATIONS OF CONTROLS: ALL PROPOSED TEMPORARY CONTROLS AND EXISTING PERMANENT CONTROLS ARE SHOWN ON THE EXISTING SITE, DEMOLITION AND EROSION CONTROL PLAN. ALL PROPOSED PERMANENT CONTROLS ARE SHOWN ON THE REMAINING PLANS. IT WILL BE THE CONTRACTOR'S RESPONSIBILITY TO INDICATE THE LOCATION OF ANY OTHER CONTROLS ON THE PLANS THAT ARE USED DURING CONSTRUCTION.
- PERMANENT STABILIZATION IS SHOWN ON THE PLANS. IT WILL BE THE CONTRACTOR'S RESPONSIBILITY TO INDICATE THE LOCATION ON THE PLANS OF ALL TEMPORARY STABILIZATION PRACTICES USED DURING CONSTRUCTION.
- SURFACE WATERS: N/A
- <u>DISCHARGE POINTS:</u> ONSITE WETLANDS WITH ULTIMATE DISCHARGE TO ELEVEN MILE CREEK

#### 2.6 RECEIVING WATERS:

EVENTUAL OUTFALL TO PERDIDO BAY

3.0 CONTROLS:

#### 3.1 EROSION AND SEDIMENT CONTROLS:

ALL EROSION AND SEDIMENT CONTROLS SPECIFIED ON THE DEMOLITION AND EROSION CONTROL PLAN SHEETS, AND THE EROSION CONTROL DETAILS SHALL BE INSTALLED PRIOR TO ANY CONSTRUCTION OR DEMOLITION. SILT FENCING AND STAKED HAY BALES SHALL BE INSTALLED ALONG DOWN-GRADIENT LIMITS.

TEMPORARY SEEDING AND MULCHING SHALL BE APPLIED AFTER 14—DAY INTERVALS OF CEASED DISTURBANCE ACTIVITIES THAT WILL EXCEED 20—DAY PERIODS. GRADED AREAS SHALL BE STABILIZED WITH PERMANENT SEEDING, MULCHING, AND FERTILIZING, OR SODDING WITHIN FIVE DAYS OF FINAL GRADING. LANDSCAPING, INCLUDING SODDING, SHALL BE INSTALLED BY AN EXPERIENCED LANDSCAPE CONTRACTOR. PROPOSED DISTURBED AREAS WILL NOT EXCEED 8 ACRES IN ANY DRAINAGE AREA.

#### 3.2 STORMWATER MANAGEMENT:

PROPOSED STORMWATER MANAGEMENT FACILITIES FOR THIS SITE INCLUDE: A DRY RETENTION POND FOR THE ENTIRE PROPERTY.

THE PROPOSED STORMWATER MANAGEMENT FACILITIES MEET ALL STORMWATER TREATMENT REQUIREMENTS AND ALL RATE CONTROL REQUIREMENTS SET FORTH BY THE LOCAL AND STATE REGULATORY AGENCIES.

#### 3.3 OTHER CONTROLS:

WASTE DISPOSAL: THE CONTRACTOR IS RESPONSIBLE FOR ALL WASTE DISPOSAL FROM THE SITE. THE CONTRACTOR SHALL EMPLOY WASTE DISPOSAL PRACTICES THAT MEET ALL LOCAL, STATE, AND FEDERAL GUIDELINES AND PREVENT DISCHARGE OF SOLID MATERIALS TO WATERS OF THE UNITED STATES. THE CONTRACTOR IS RESPONSIBLE FOR DOCUMENTING THIS PORTION OF THE SWPPP.

OFFSITE VEHICLE TRACKING: IF OFF SITE TRACKING OF SEDIMENTS BY CONSTRUCTION VEHICLES OCCURS, THE CONTRACTOR IS REQUIRED TO INSTALL A SOIL TRACKING PREVENTION DEVICE (STPD) AS PER FDOT STANDARD INDEX 106 AT ALL EXITS TO THE SITE WHERE SEDIMENT TRACKING IS OCCURRING. THE CONTRACTOR IS ALSO RESPONSIBLE FOR DOCUMENTING THIS PORTION OF THE SWPPP.

HAZARDOUS MATERIALS: ALL POLLUTANTS AND HAZARDOUS MATERIALS INCLUDING BUT NOT LIMITED TO FERTILIZERS, HERBICIDES, PESTICIDES, SOLVENTS, OILS AND OIL FILTERS, PETROLEUM PRODUCTS, PAINT, AND EQUIPMENT MAINTENANCE FLUIDS, SHALL BE STORED INDOORS OR UNDER COVER IN AREAS WITH SECONDARY CONTAINMENT. SECONDARY CONTAINMENT PREVENTS A SPILL FROM SPREADING ACROSS THE SITE AND INCLUDES DIKES, BERMS, CURBING, OR OTHER CONTAINMENT METHODS. HAZARDOUS MATERIAL STORAGE AREAS SHALL BE INSPECTED WEEKLY AND AFTER STORM EVENTS. STORAGE AREAS SHALL BE KEPT CLEAN, WELL ORGANIZED, AND EQUIPPED WITH AMPLE CLEANUP SUPPLIES/SPILL KITS AS APPROPRIATE FOR THE MATERIALS BEING STORED. MATERIAL SAFETY DATA SHEETS, MATERIAL INVENTORY, AND EMERGENCY CONTACT INFORMATION SHALL BE MAINTAINED ON-SITE. ALL PERSONNEL SHALL RECEIVE INSTRUCTION REGARDING PROPER PROCEDURES FOR HAZARDOUS MATERIAL HANDLING AND DISPOSAL. HAZARDOUS MATERIALS SHALL NOT BE DISPOSED OF INTO ON-SITE DUMPSTERS; HAZARDOUS MATERIALS SHALL BE DISPOSED OF IN ACCORDANCE WITH FEDERAL, STATE, AND MUNICIPAL REGULATIONS. VEHICLES AND EQUIPMENT WILL BE MAINTAINED OFF-SITE. ALL VEHICLES AND EQUIPMENT INCLUDING SUBCONTRACTOR VEHICLES WILL BE CHECKED FOR LEAKING OIL AND FLUIDS. VEHICLES LEAKING FLUIDS WILL NOT BE ALLOWED ON-SITE. DRIP PANS SHALL BE PLACED UNDER ALL VEHICLES AND EQUIPMENT THAT ARE PARKED OVERNIGHT.

APPLICATION OF FERTILIZERS, HERBICIDES, AND PESTICIDES: FERTILIZERS, HERBICIDES, AND PESTICIDES SHALL BE DELIVERED TO THE SITE IN ORIGINAL, UNOPENED CONTAINERS BEARING MANUFACTURER'S CHEMICAL ANALYSIS, NAME, TRADE NAME, TRADEMARK, AND INDICATION OF CONFORMANCE TO STATE AND FEDERAL LAWS. FERTILIZERS, HERBICIDES, AND PESTICIDES SHALL BE IN APPLIED IN ACCORDANCE WITH THE MANUFACTURER'S SUGGESTED RATE.

#### 5.0 INSPECTIONS:

QUALIFIED PERSONNEL SHALL INSPECT THE FOLLOWING ITEMS, BUT NOT LIMITED TO, AT LEAST ONCE EVERY SEVEN CALENDAR DAYS AND WITHIN 24 HOURS OF THE END OF A STORM THAT IS 0.25 INCHES OR GREATER. WHERE SITES HAVE BEEN FINALLY STABILIZED, INSPECTIONS SHALL BE CONDUCTED AT LEAST ONCE EVERY MONTH.

- POINTS OF DISCHARGE TO WATERS OF THE UNITED STATES.
- POINTS OF DISCHARGE TO MUNICIPAL SEPARATE STORM SEWER SYSTEMS.
- DISTURBED AREAS OF THE SITE THAT HAVE NOT BEEN FINALLY STABILIZED.
  AREAS USED FOR STORAGE OF MATERIALS THAT ARE EXPOSED TO PRECIPITATION.
- STRUCTURAL CONTROLS.STORMWATER MANAGEMENT SYSTEMS.
- LOCATIONS WHERE VEHICLES ENTER OR EXIT THE SITE.

#### 6.0 NON-STORMWATER DISCHARGES:

THE CONTRACTOR SHALL BE RESPONSIBLE FOR REPORTING ANY HAZARDOUS SUBSTANCE SPILLS THAT MAY EQUAL OR EXCEED A REPORTABLE QUANTITY (RQ). REFER TO EPA'S LIST OF HAZARDOUS SUBSTANCES AND REPORTABLE QUANTITIES (EPA 40 CFR 302.4 & 117). V THIS LIST CAN BE OBTAINED FROM EPA'S WEBSITE (WWW.EPA.GO ) OR BY CONTACTING EPA. IF AN RQ RELEASE DOES OCCUR THE CONTRACTOR SHALL PERFORM THE FOLLOWING PROCEDURES:

NOTIFY THE NATIONAL RESPONSE CENTER IMMEDIATELY AT 800-424-8802.
 PROVIDE WRITTEN DESCRIPTION OF THE RELEASE WITHIN 14 DAYS PROVIDING DATES, CAUSE AND PREVENTION METHODS TO THE REGIONAL EPA OFFICE.
 MODIFY THE SWPPP AS NECESSARY TO ADDRESS ADDED PREVENTION METHODS.

#### 7.0 IMPLEMENTATION CHECKLIST:

#### 7.1 RECORDS:

THE CONTRACTOR SHALL MAINTAIN RECORDS OF CONSTRUCTION ACTIVITIES INCLUDING, BUT NOT LIMITED TO:

- DATES WHEN MAJOR GRADING ACTIVITIES OCCUR.
   DATES WHEN CONSTRUCTION ACTIVITIES TEMPORARILY CEASE ON A PORTION OF THE SITE.
   DATES WHEN CONSTRUCTION ACTIVITIES PERMANENTLY CEASE ON A
- PORTION OF THE SITE.

   DATES WHEN STABILIZATION MEASURES ARE INITIATED ON THE SITE.

#### 7.2 INSPECTION REPORTS:

THE CONTRACTOR SHALL PREPARE INSPECTION REPORTS SUMMARIZING THE FOLLOWING, BUT NOT LIMITED TO:

- NAME OF INSPECTOR.
- NAME OF INSPECTOR.
   QUALIFICATIONS OF INSPECTOR.
- MEASURES/AREAS INSPECTED.OBSERVED CONDITIONS.
- CHANGES NECESSARY TO THE SWPPP.

## 7.3 RELEASES OF REPORTABLE QUANTITIES OF OIL OR HAZARDOUS MATERIALS:

THE CONTRACTOR SHALL REPORT ANY RELEASES OF REPORTABLE QUANTITIES OF OIL OR HAZARDOUS MATERIALS IF THEY OCCUR AS PER THE MEASURES OUTLINED IN SECTION 6.0 OF THE SWPPP.

#### 7.4 SWPPP MODIFICATION:

THE CONTRACTOR SHALL MODIFY THE SWPPP AS NECESSARY TO:

COMPLY WITH MINIMUM PERMIT REQUIREMENTS WHEN NOTIFIED BY FDEP THAT THE PLAN DOES NOT COMPLY.
ADDRESS ANY CHANGES IN DESIGN, CONSTRUCTION OPERATIONS OR MAINTENANCE, WHICH HAS AN EFFECT ON THE POTENTIAL FOR DISCHARGE OF POLLUTANTS.
PREVENT REOCCURRENCE OF REPORTABLE QUANTITY RELEASES OF HAZARDOUS MATERIAL OR OIL

#### 8.0 TERMINATION CHECKLIST:


THE FOLLOWING ITEMS SHALL BE COMPLETE BEFORE SUBMITTING THE NOT:

ALL SOIL DISTURBING ACTIVITIES ARE COMPLETE.
 TEMPORARY EROSION AND SEDIMENT CONTROL MEASURES HAVE BEEN REMOVED OR WILL BE REMOVED AT AN APPROPRIATE TIME.
 ALL AREAS OF THE CONSTRUCTION SITE NOT OTHERWISE COVERED BY PERMANENT PAVEMENT OR STRUCTURE HAVE BEEN STABILIZED WITH UNIFORM PERENNIAL VEGETATIVE COVER WITH A DENSITY OF 70% OR EQUIVALENT MEASURES HAVE BEEN EMPLOYED.

SOL-BATTLE & ASSOC Civil Engineers and Surveyors 2301 N. Ninth Avenue, Suite 300 Pensacola, Florida 32503

NPDES - STORMWATER POLLUTION PREVENTION PLAN

Fallschase at Pathstone Phase 4 A 47 Lot Subdivision 9 Mile Road ESCAMBIA COUNTY, FLORIDA

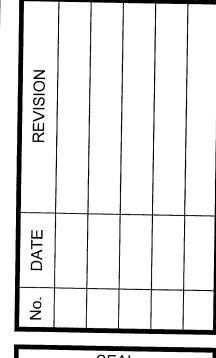

SEAL

NOT, FOR CONSTRUCTION

No. 75 44

STATE OF 22


ORIDA

JEREMY, RIKING, P.E.

Dr. By: CBD Ck By: JRK Job No.: 2017.103 Date: 6/16/2022

DRAWING No.

C1.3

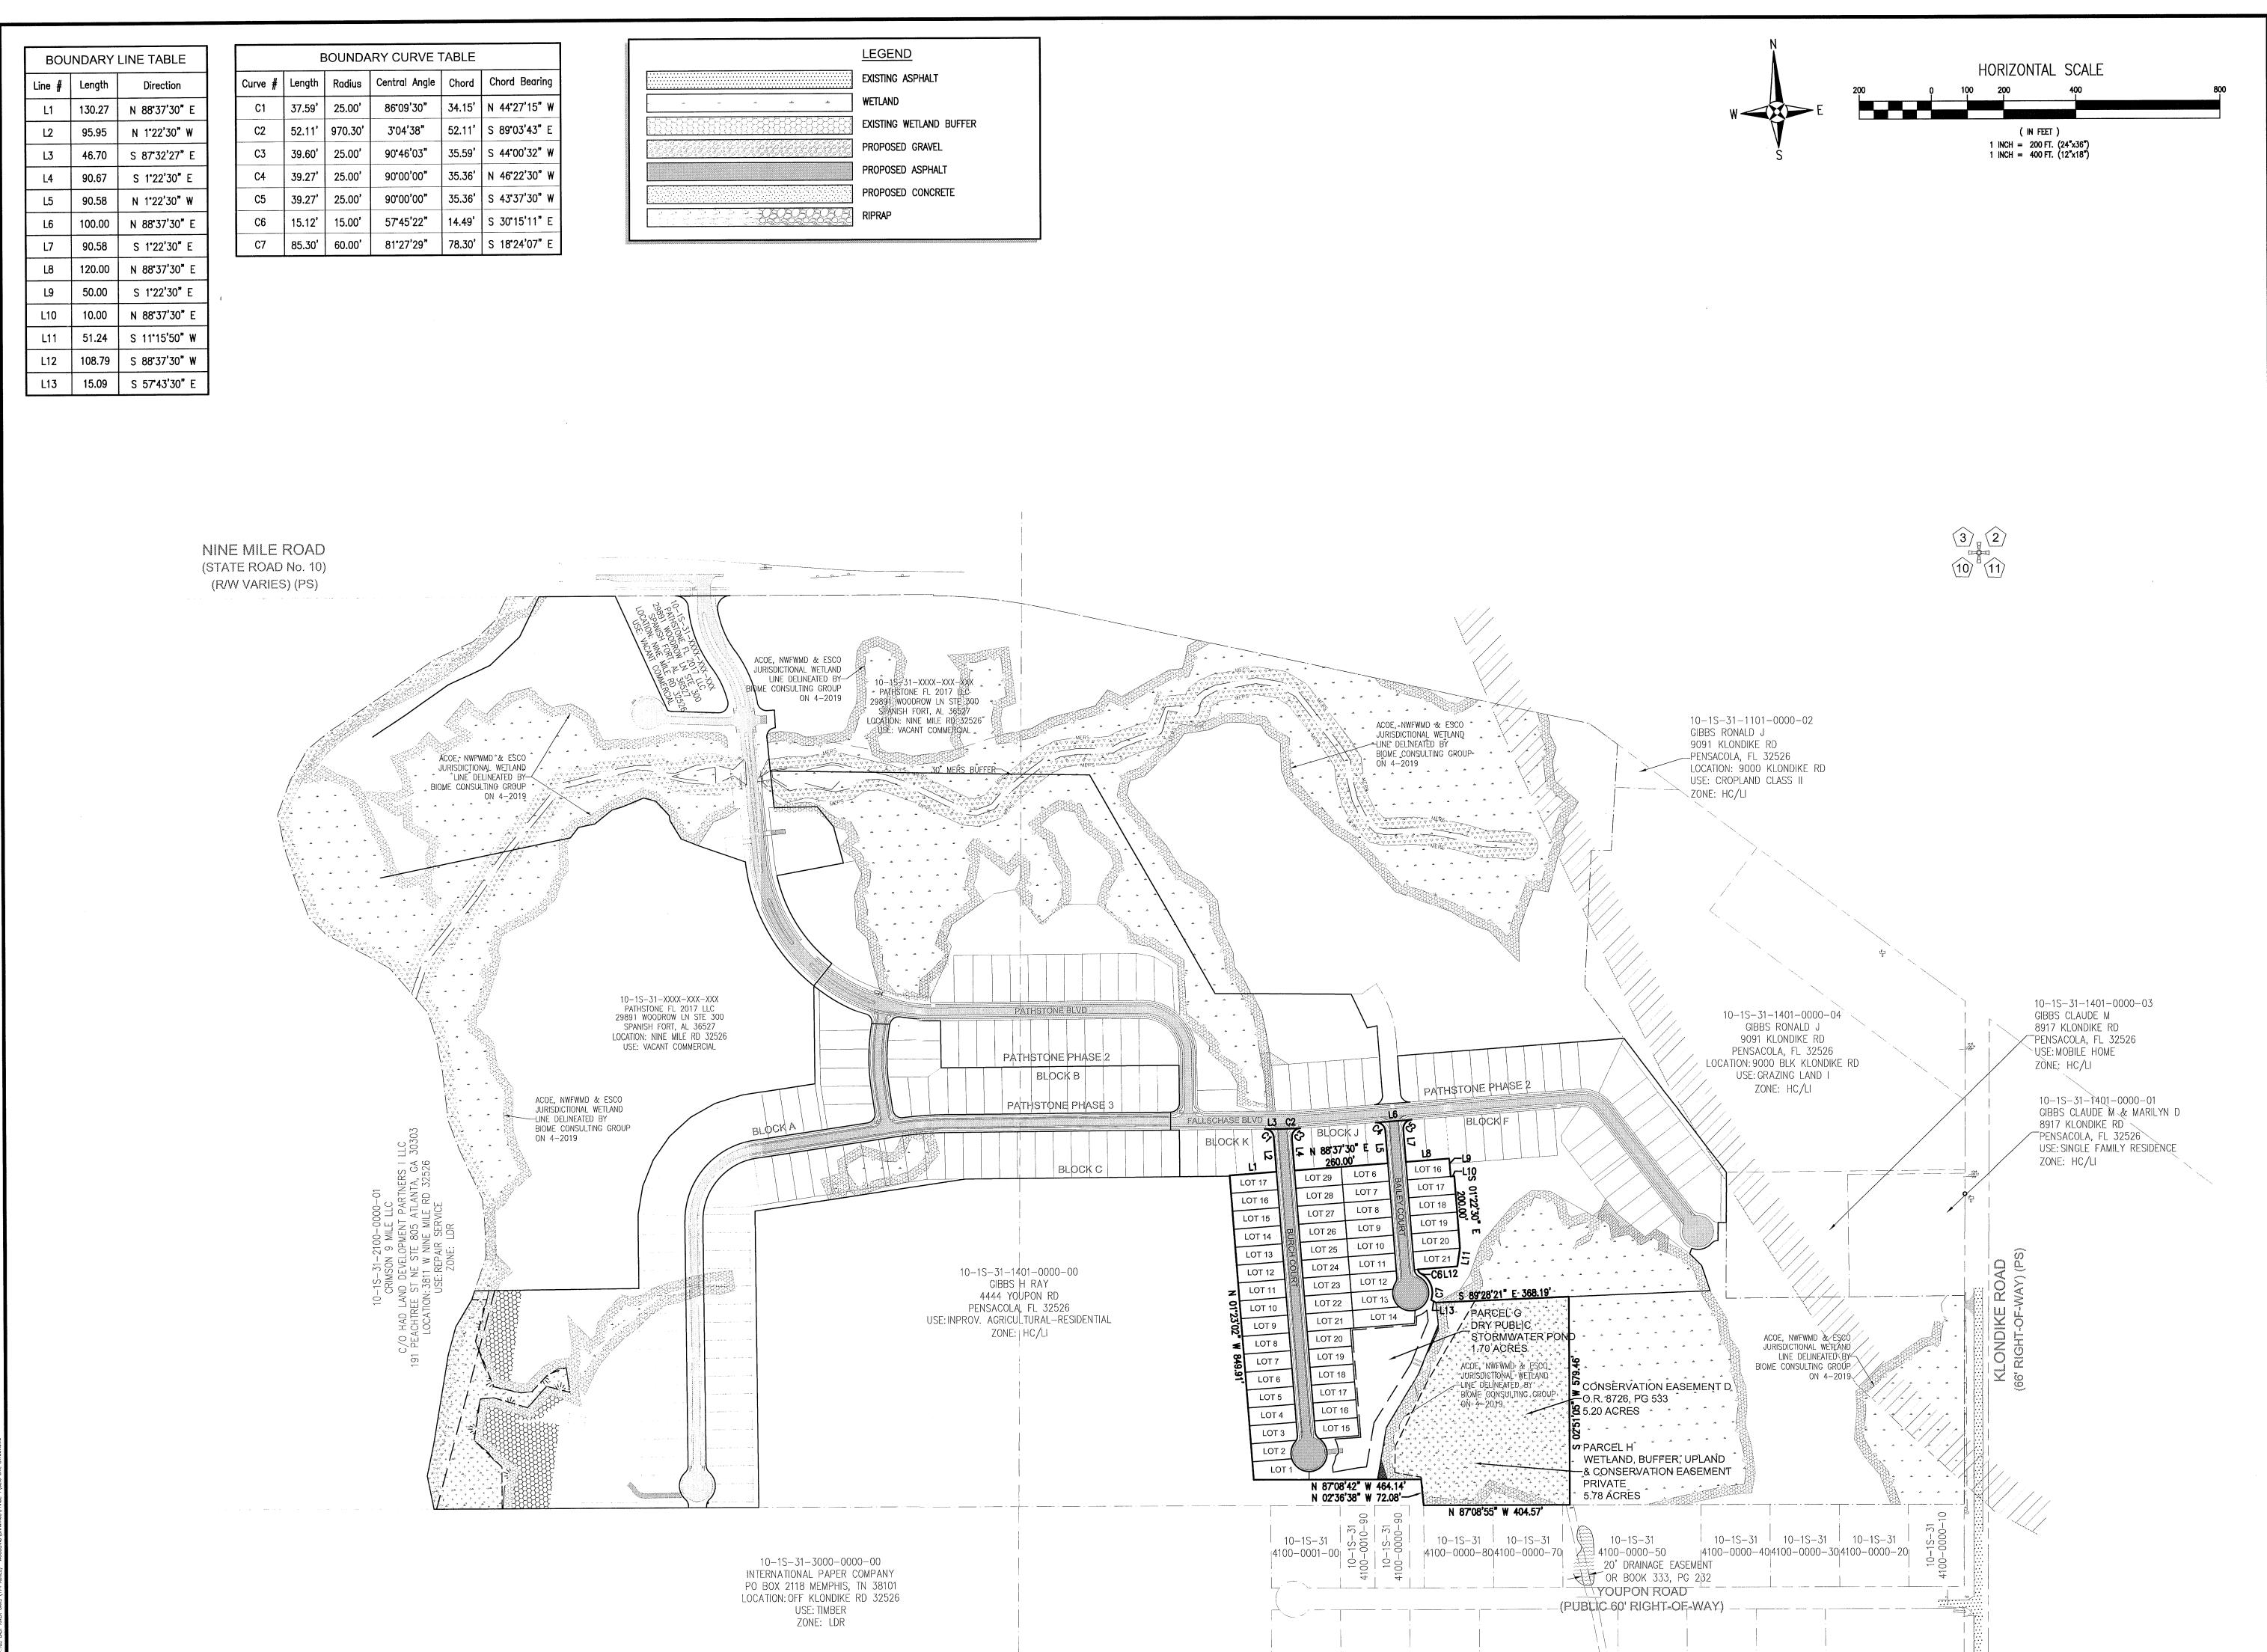

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Civil Engineers and Surveyors
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Pensacola, Florida 32503
Telephone 850.438.0400 Fax 850.438.0448
EB 00009657

LAYOUT


REBOL-BATTI

Civil Engine
2301 N. Ni
Pensar
Pensar
Telephone 850.

n OVERALL

SITE

Fallschase at Pathstone
Phase 4
A 47 Lot Subdivision
9 Mile Road
ESCAMBIA COUNTY, FLORIDA

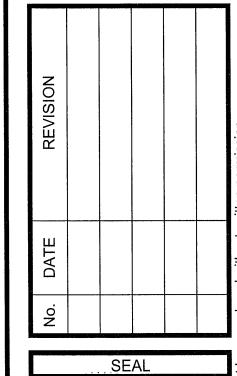

SEAL
NOT FOR CONSTRUCTION

No. 76 444

STATE OF 10


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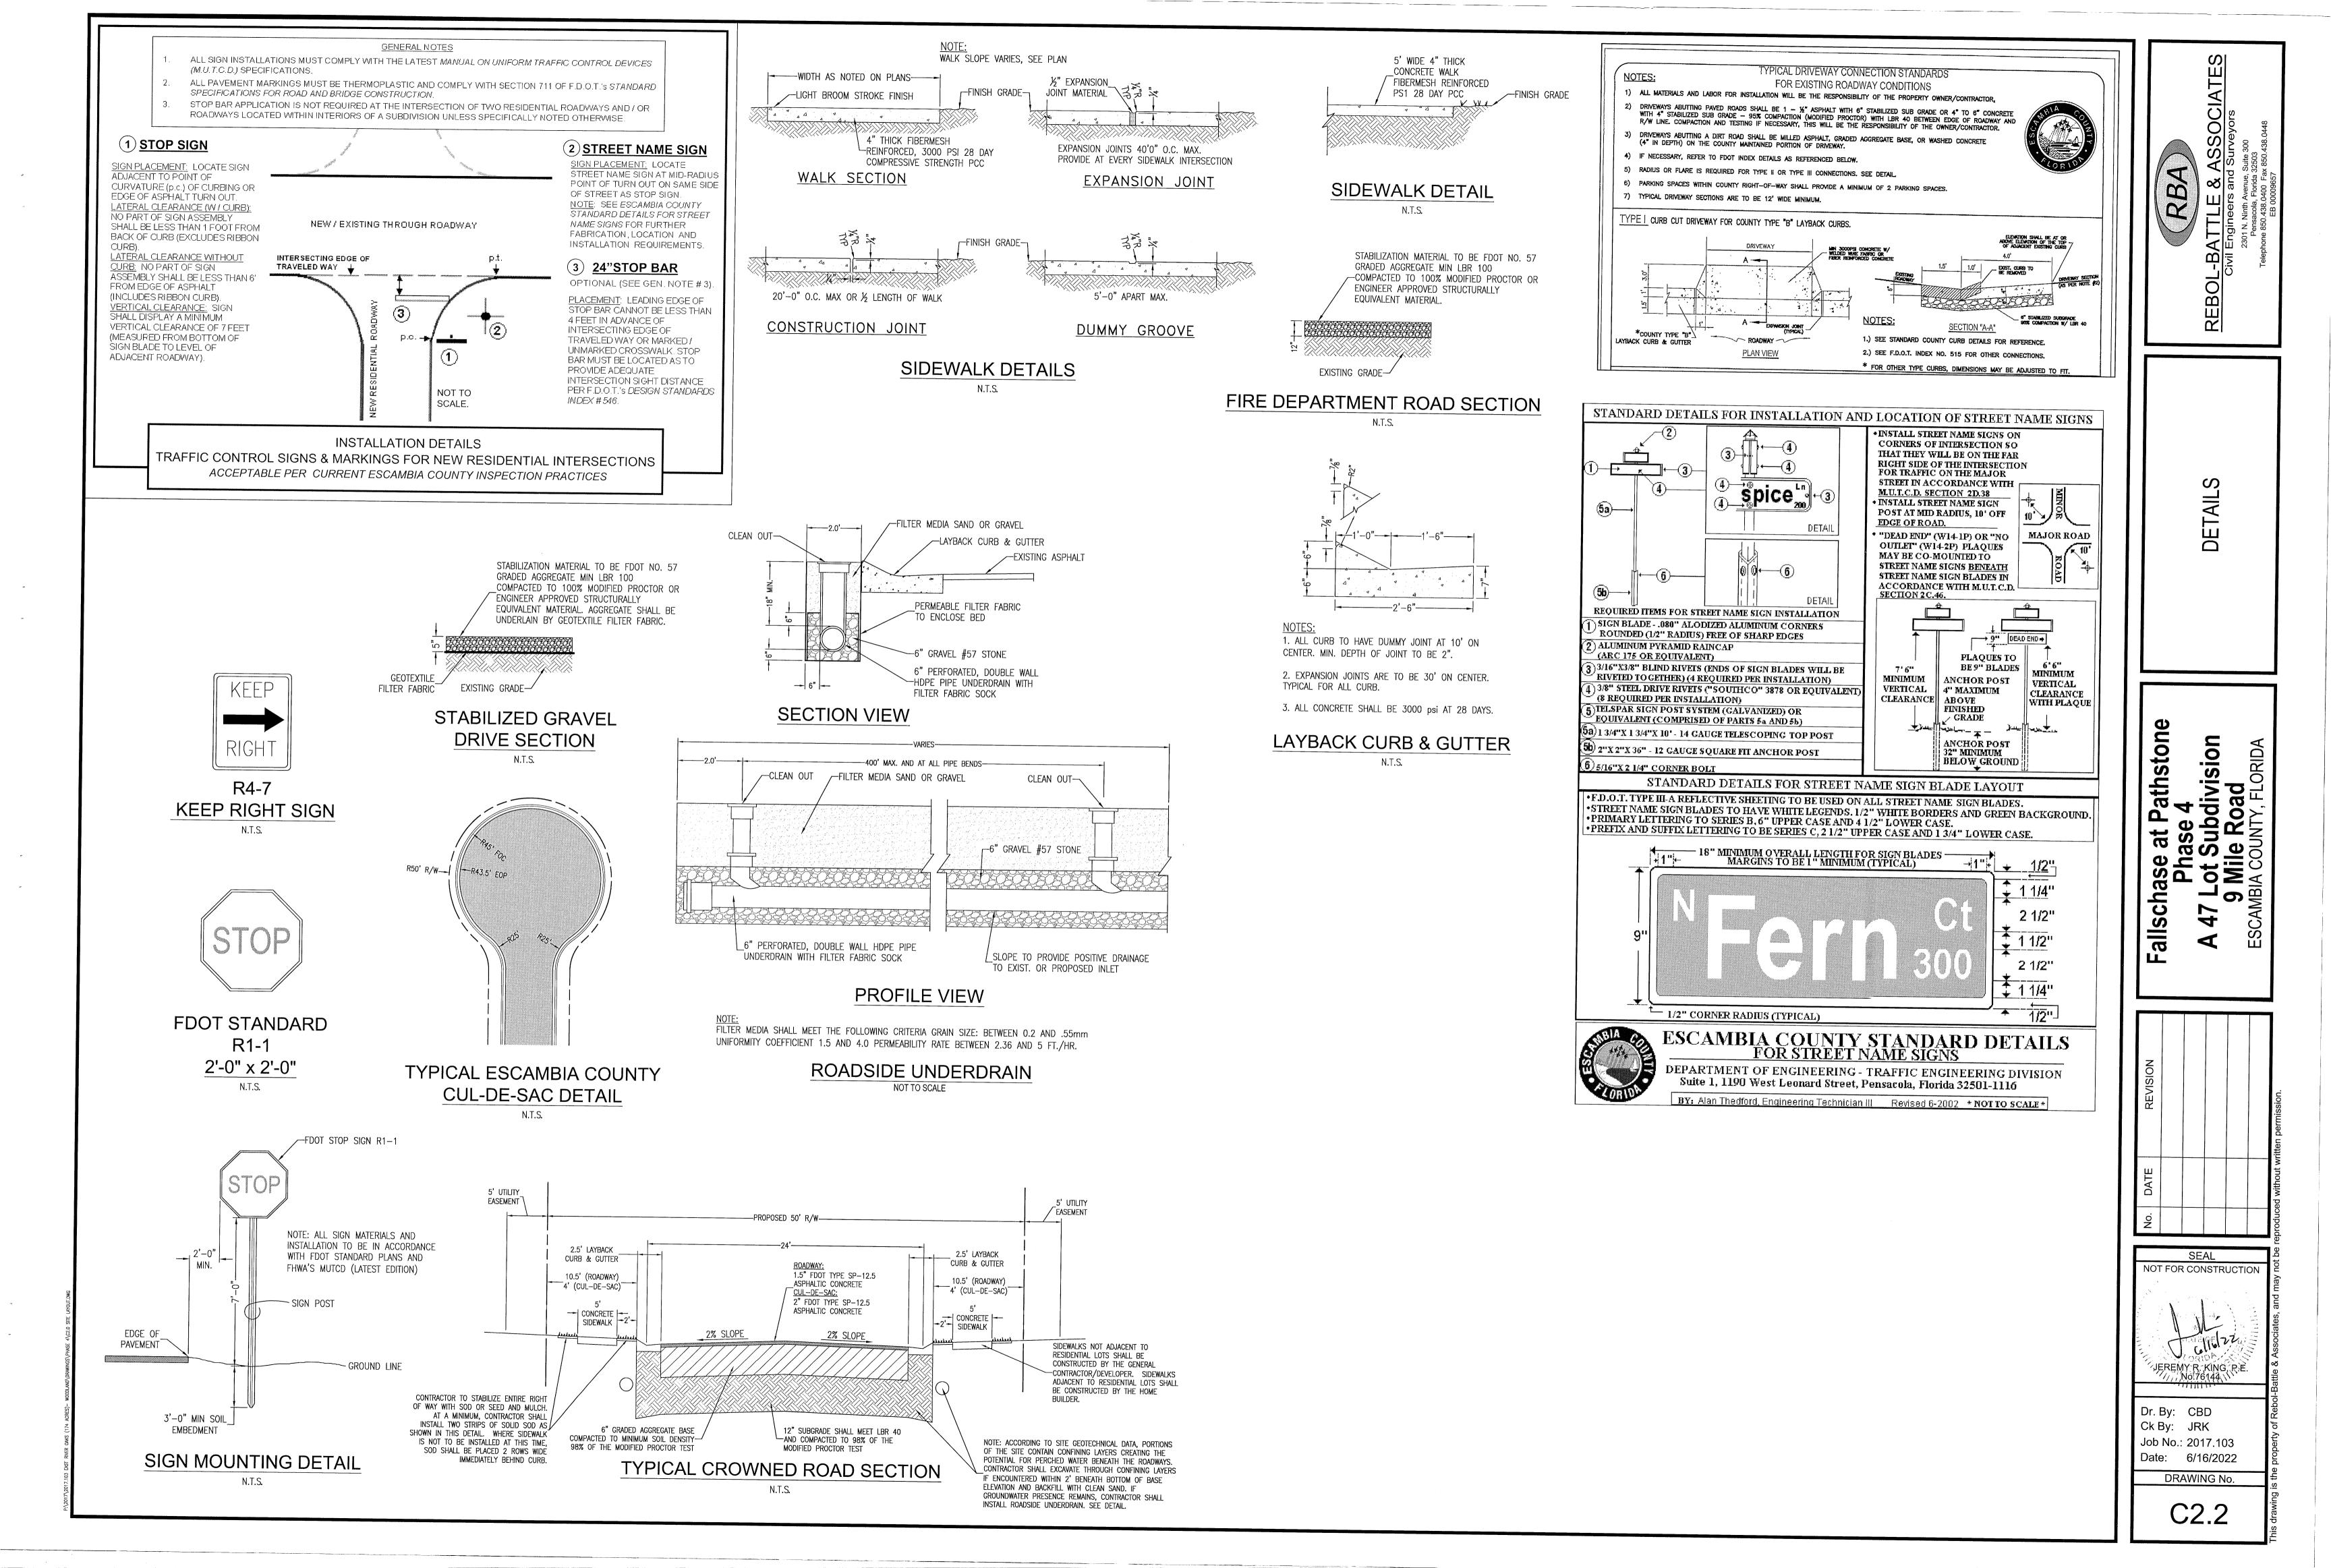
JEREMY R KING, P.E.


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Dr. By: CBD
Ck By: JRK
Job No.: 2017.103
Date: 6/16/2022
DRAWING No.

C2.0





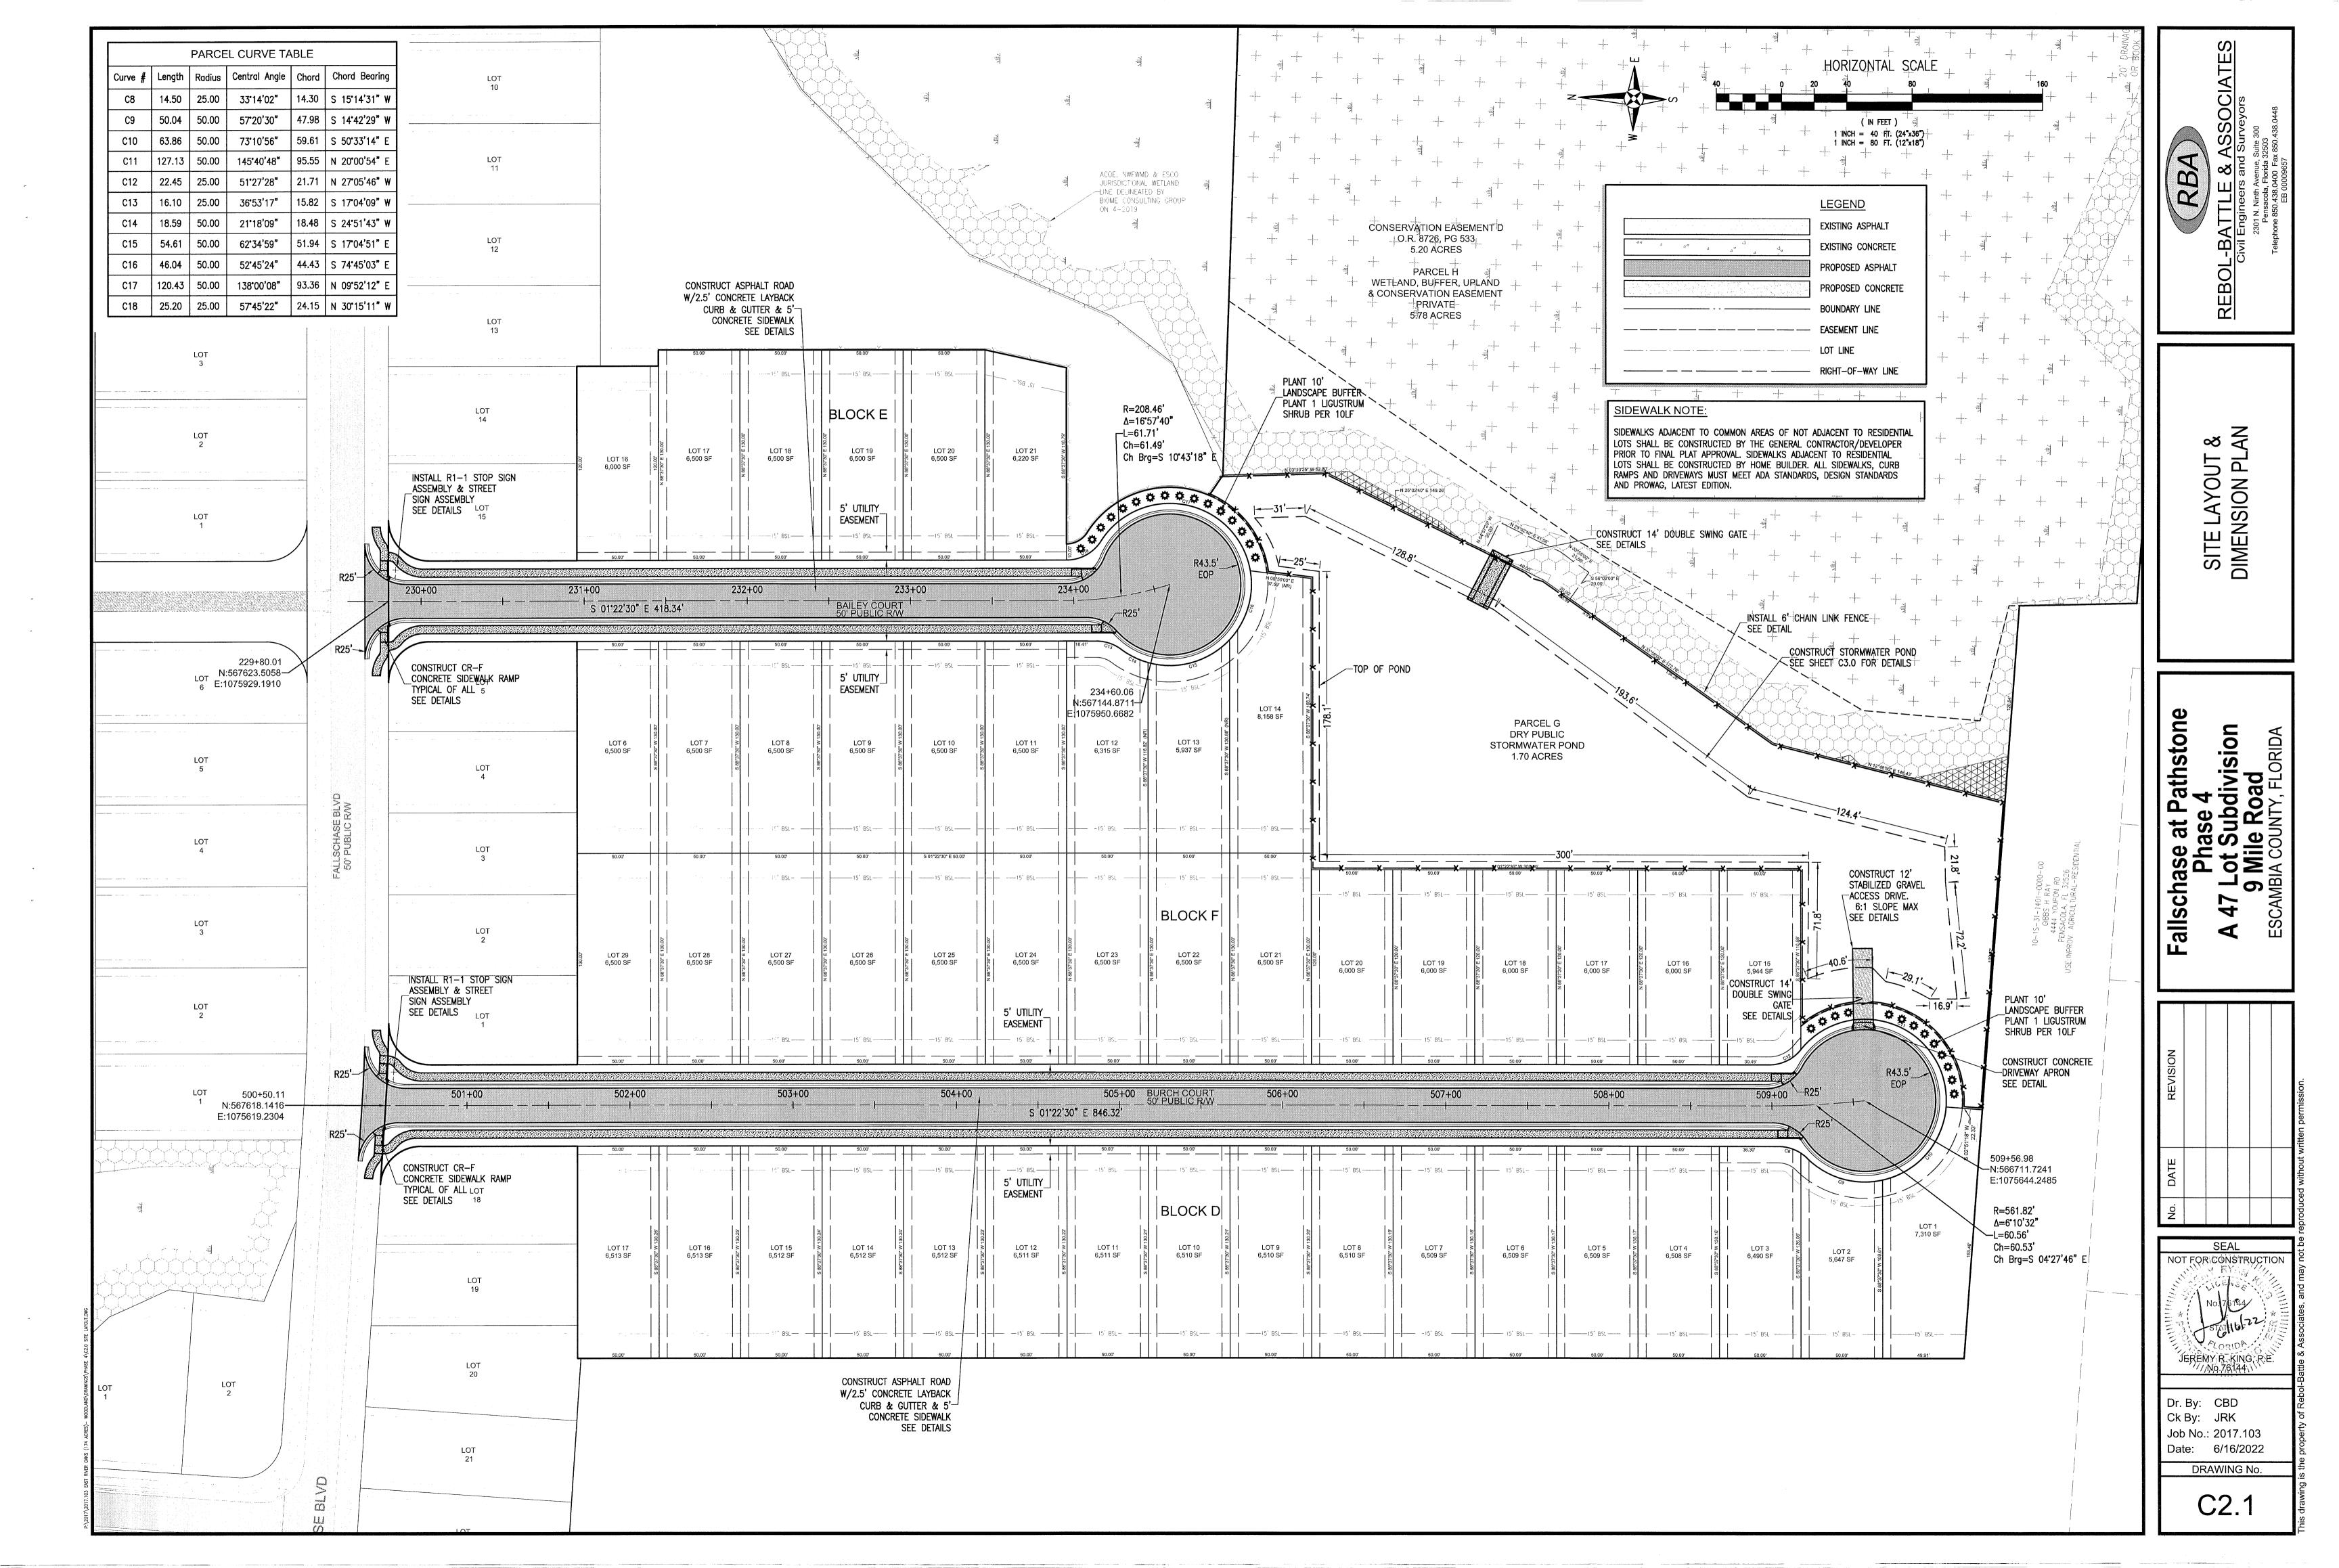

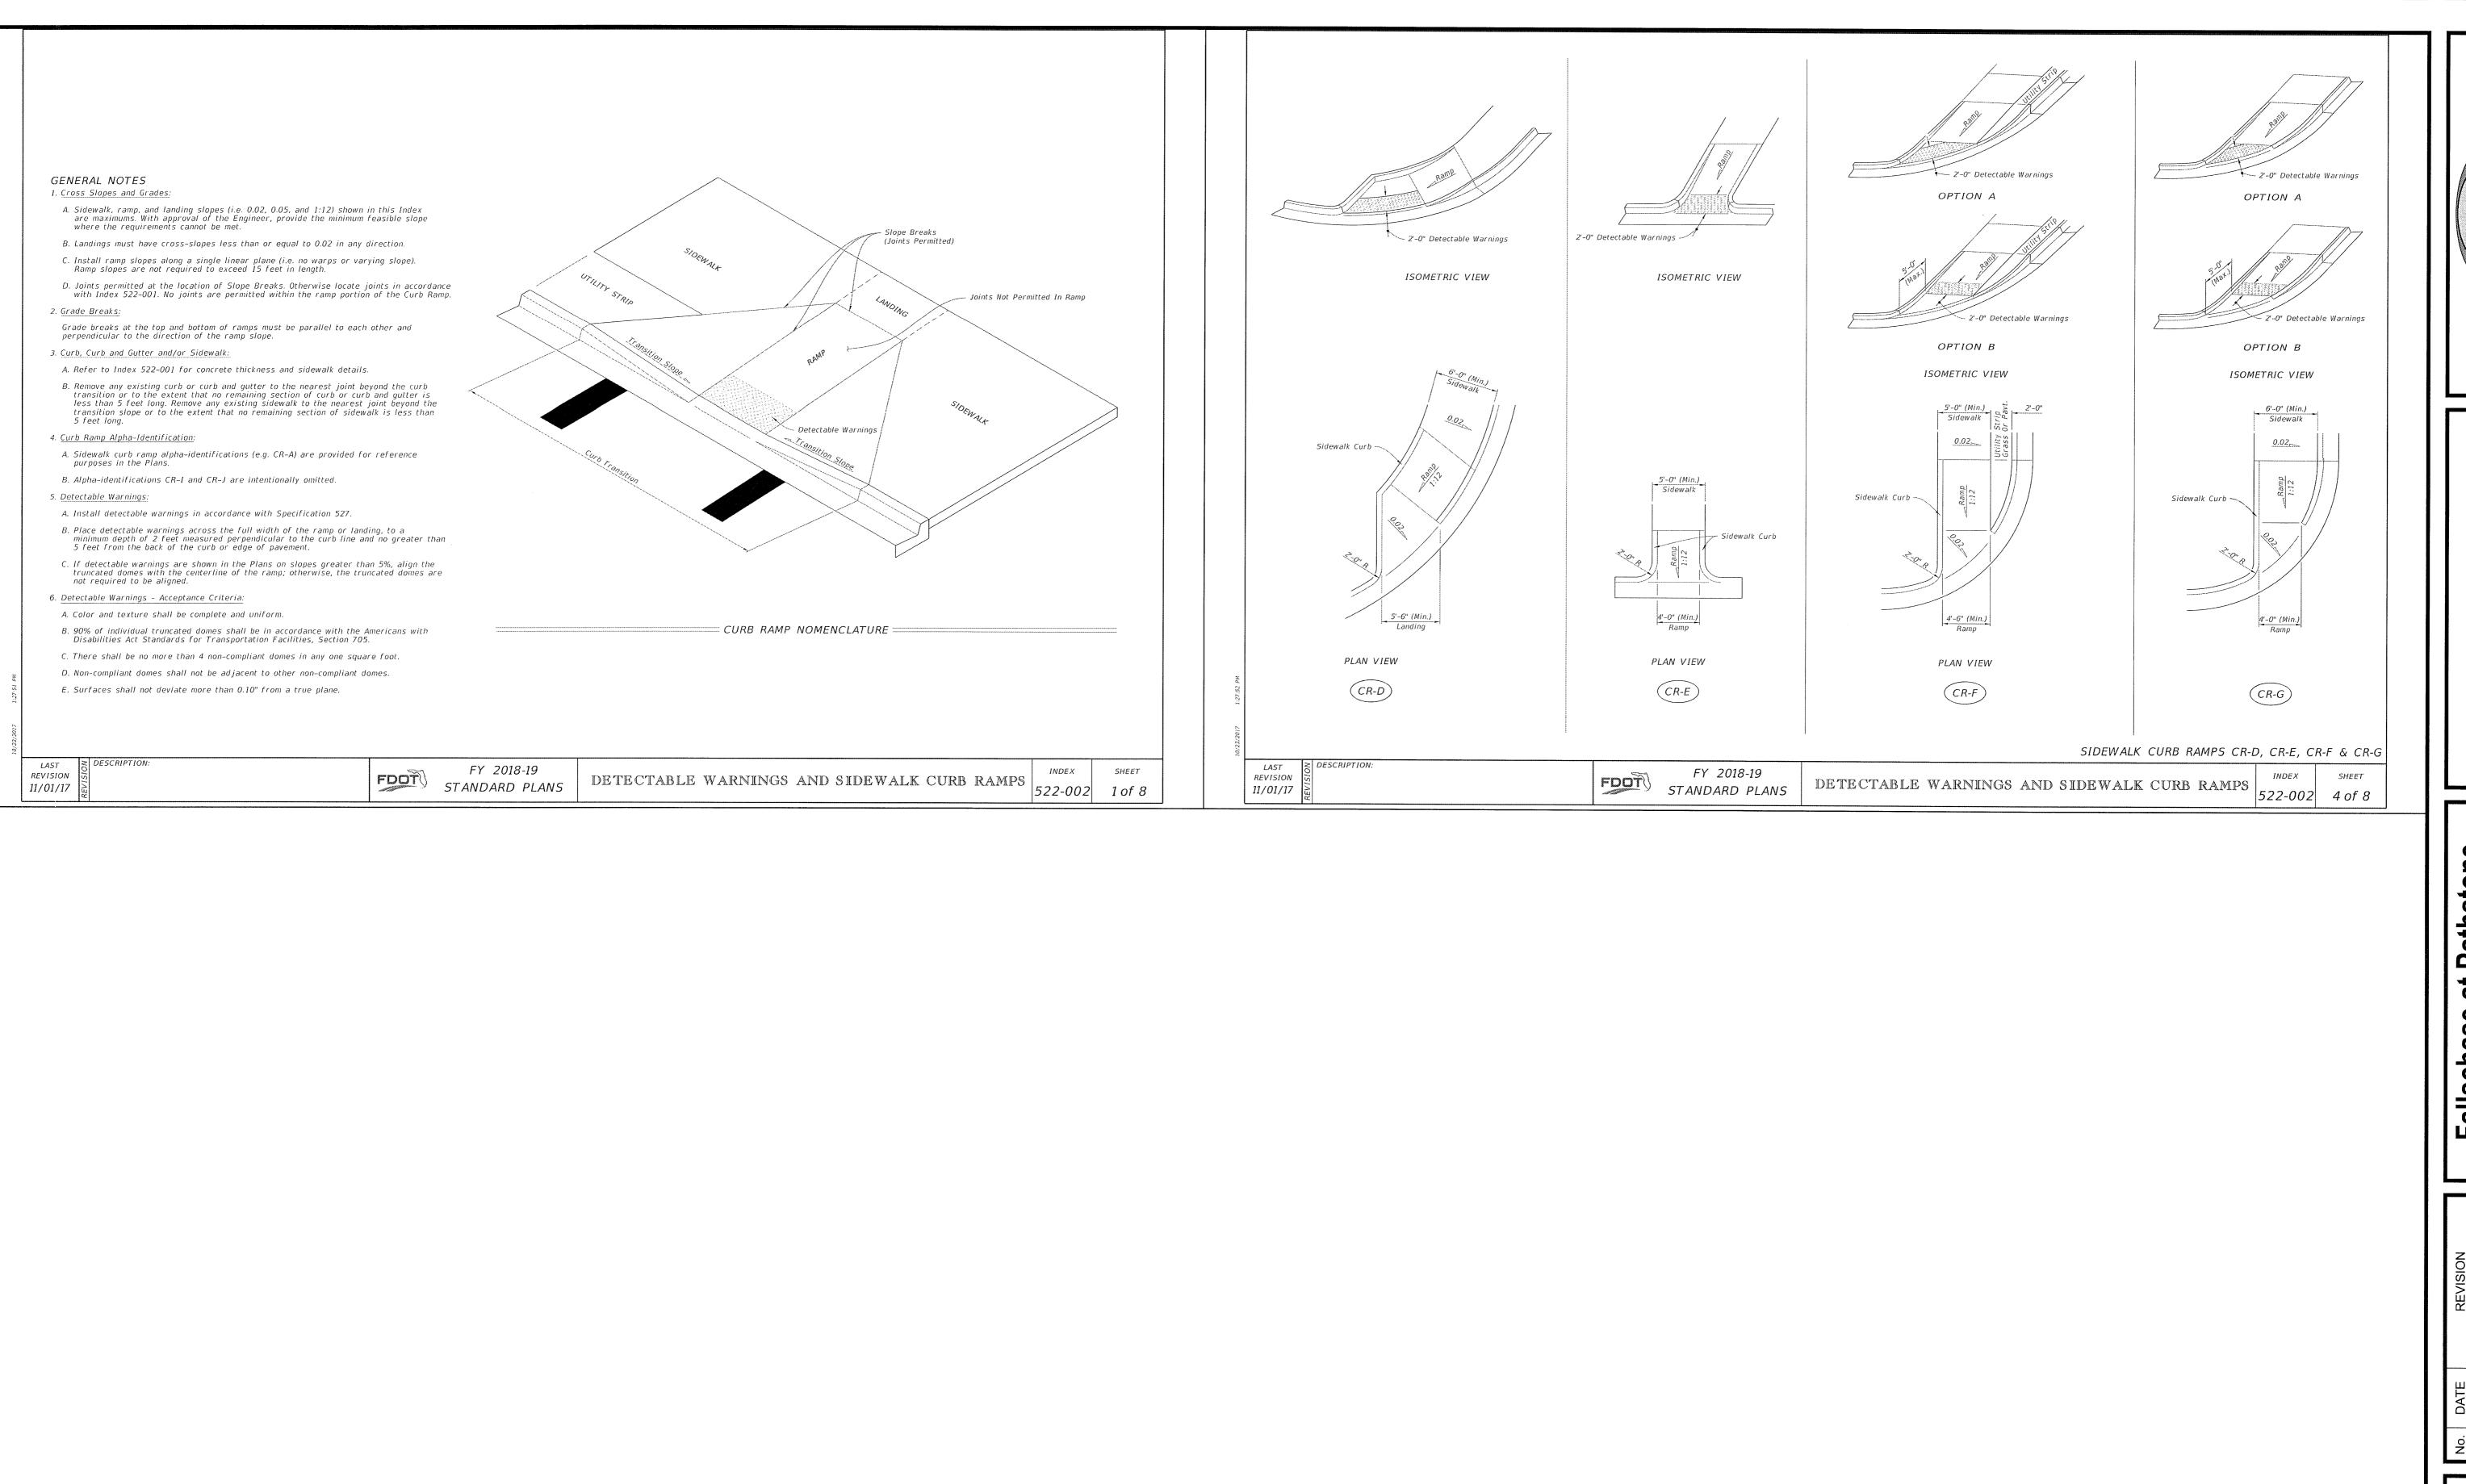REBOL-BATTLE & Civil Engineers and Pensacola, Florida Pensacola, Florida Telephone 850.438.0400 Fa EB 00009657

Phase at Pathistone
Phase 4

A 47 Lot Subdivision
9 Mile Road

No. DATE REVISION

SEAL

NOT FOR CONSTRUCTION

No. 75141

No. 75141

SEREMY R. RING, P.E. No. 76144

Dr. By: CBD Ck By: JRK Job No.: 2017.103 Date: 6/16/2022

DRAWING No.

C2.3

PO BOX 2118 MEMPHIS, TN 38101

LOCATION: OFF KLONDIKE RD 32526

USE: TIMBER

ZONE: LDR

**EXISTING ASPHALT EXISTING CONCRETE EXISTING GRAVEL** PROPOSED ASPHALT PROPOSED CONCRETE 25' WETLAND BUFFER ADDITIONAL WETLAND BUFFER 30' MERS BUFFER -----100----- EXISTING CONTOUR PROPOSED CONTOUR ◆ 100.00 PROPOSED SPOT ELEVATION

OR BOOK 333, PG 232

YOUPON ROAD

(PUBLIC 60' RIGHT-OF-WAY)


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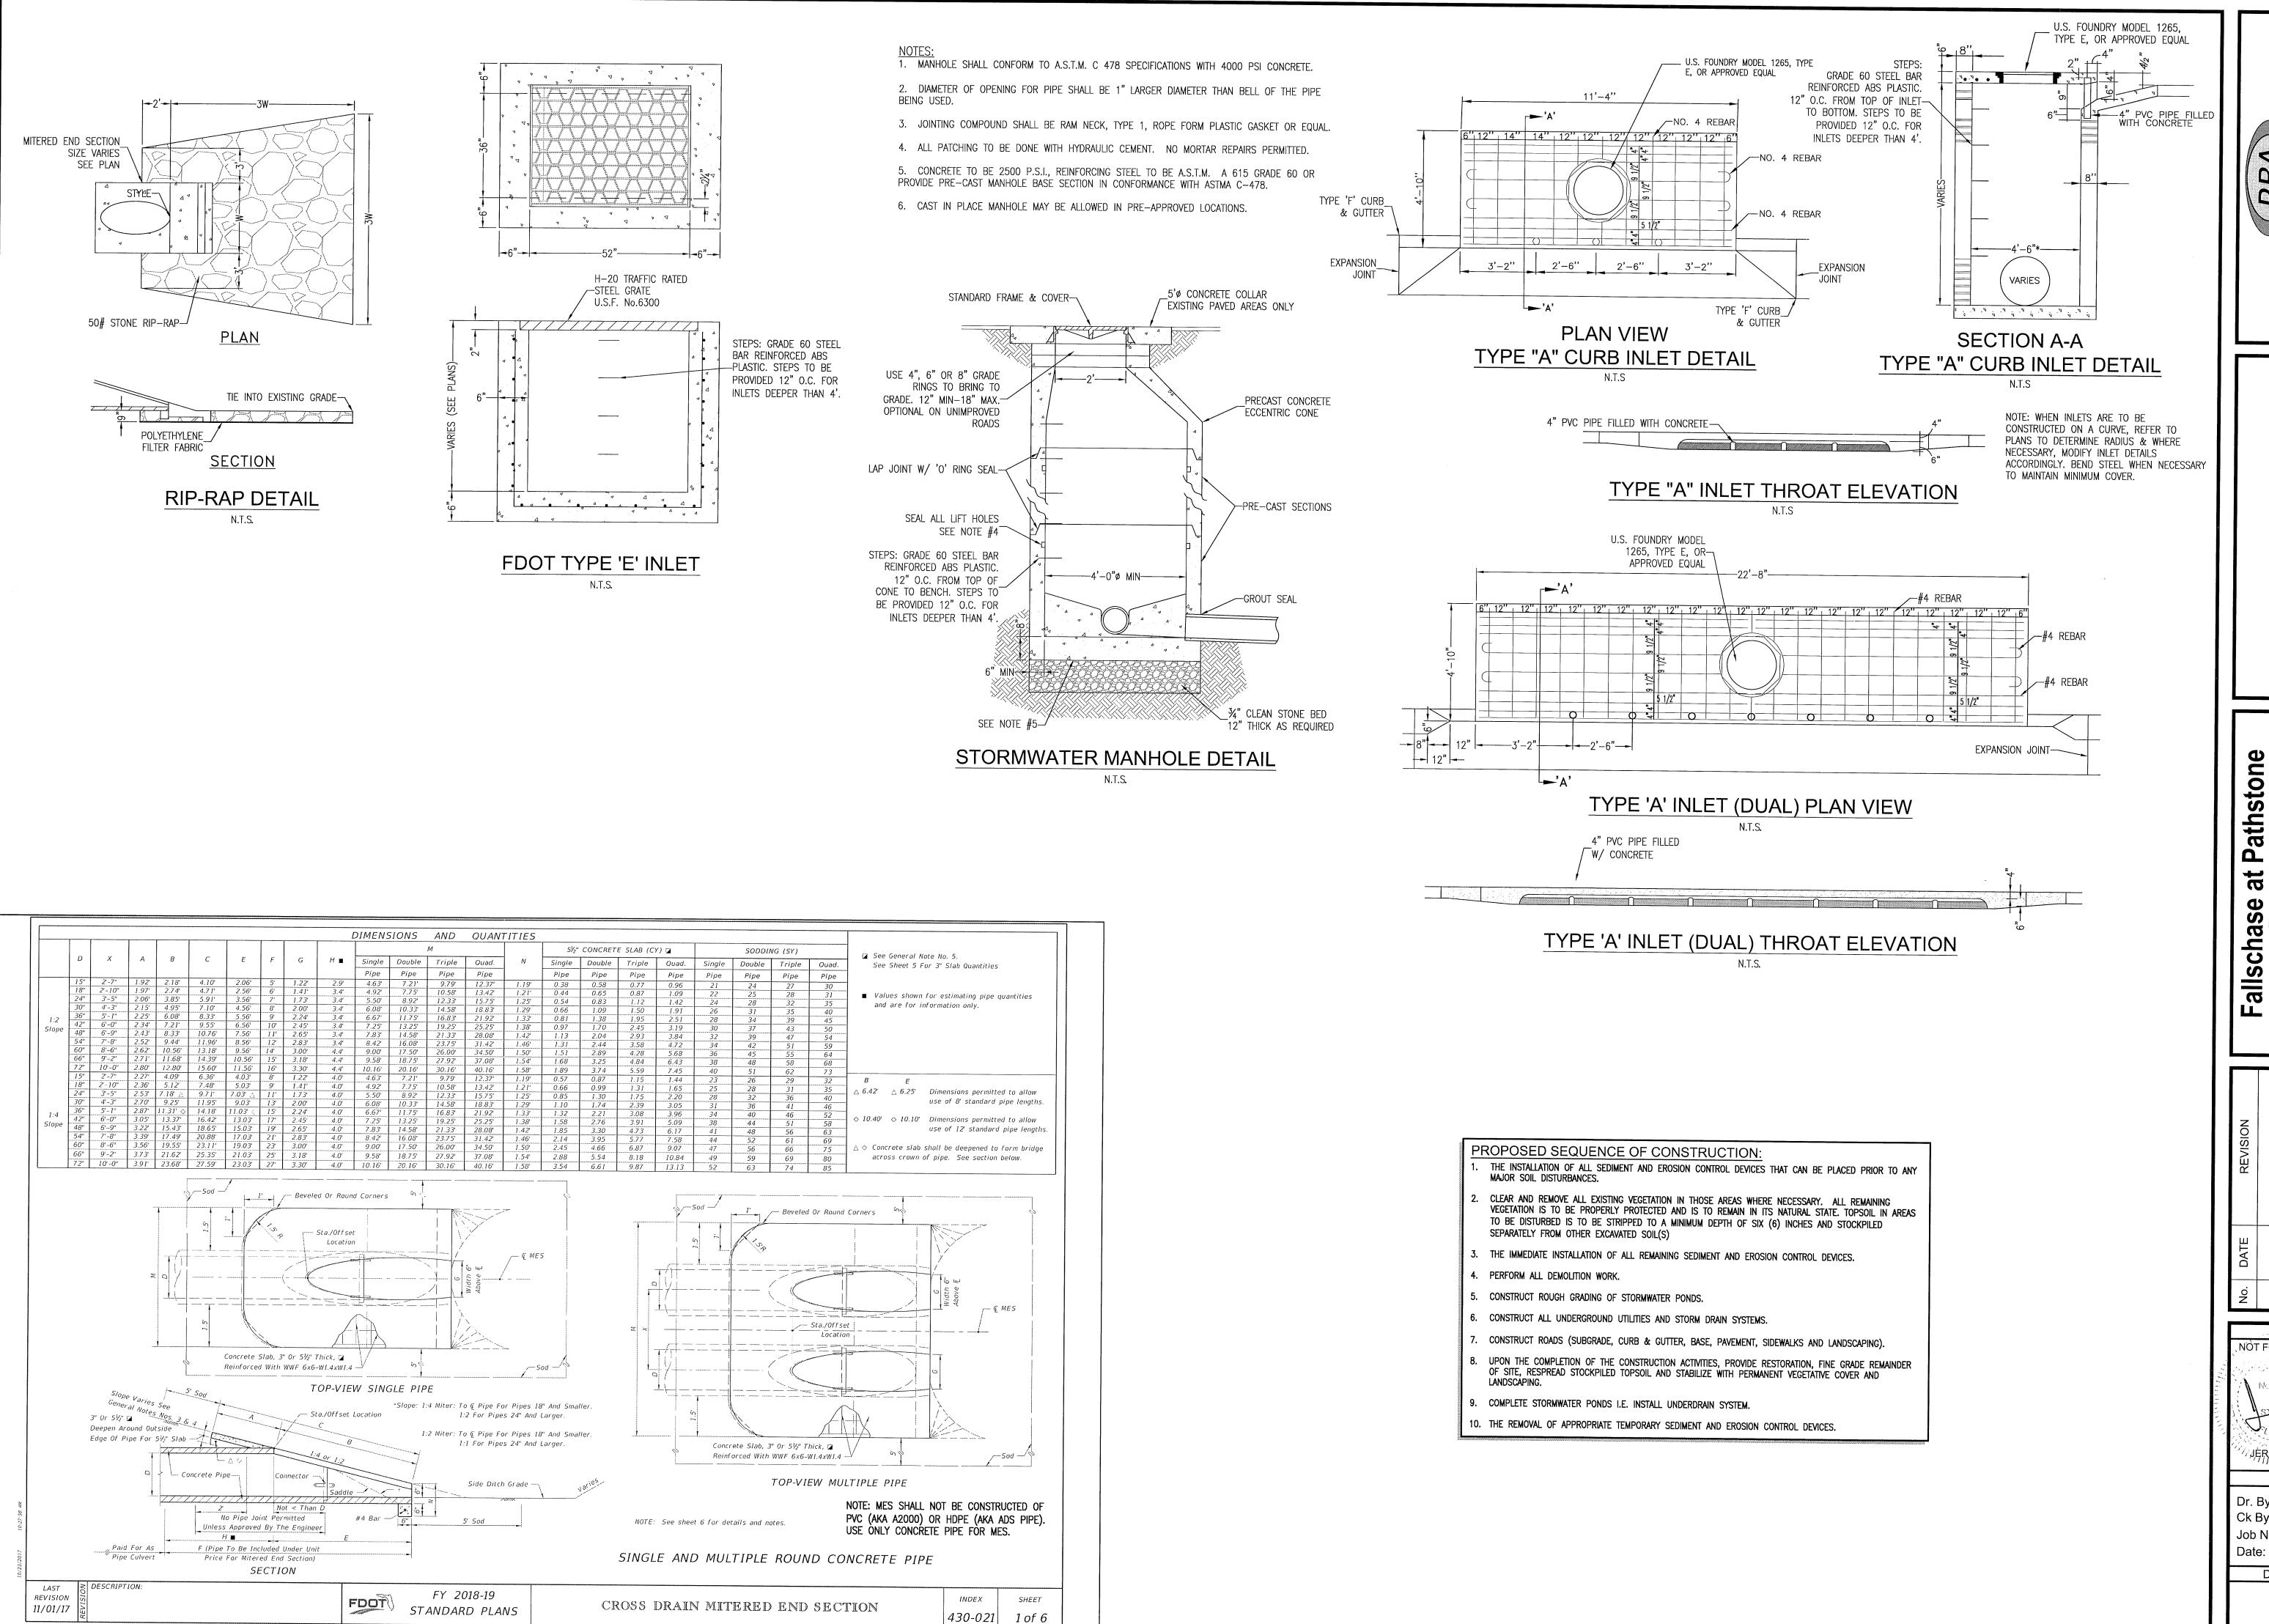
ston ivision ad ath Phase a Phase of St. of St. Mile 9 PMBI <del>C</del> 4 <u>=</u>

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// No.76144

Dr. By: CBD Ck By: JRK Job No.: 2017.103 Date: 6/16/2022 DRAWING No.



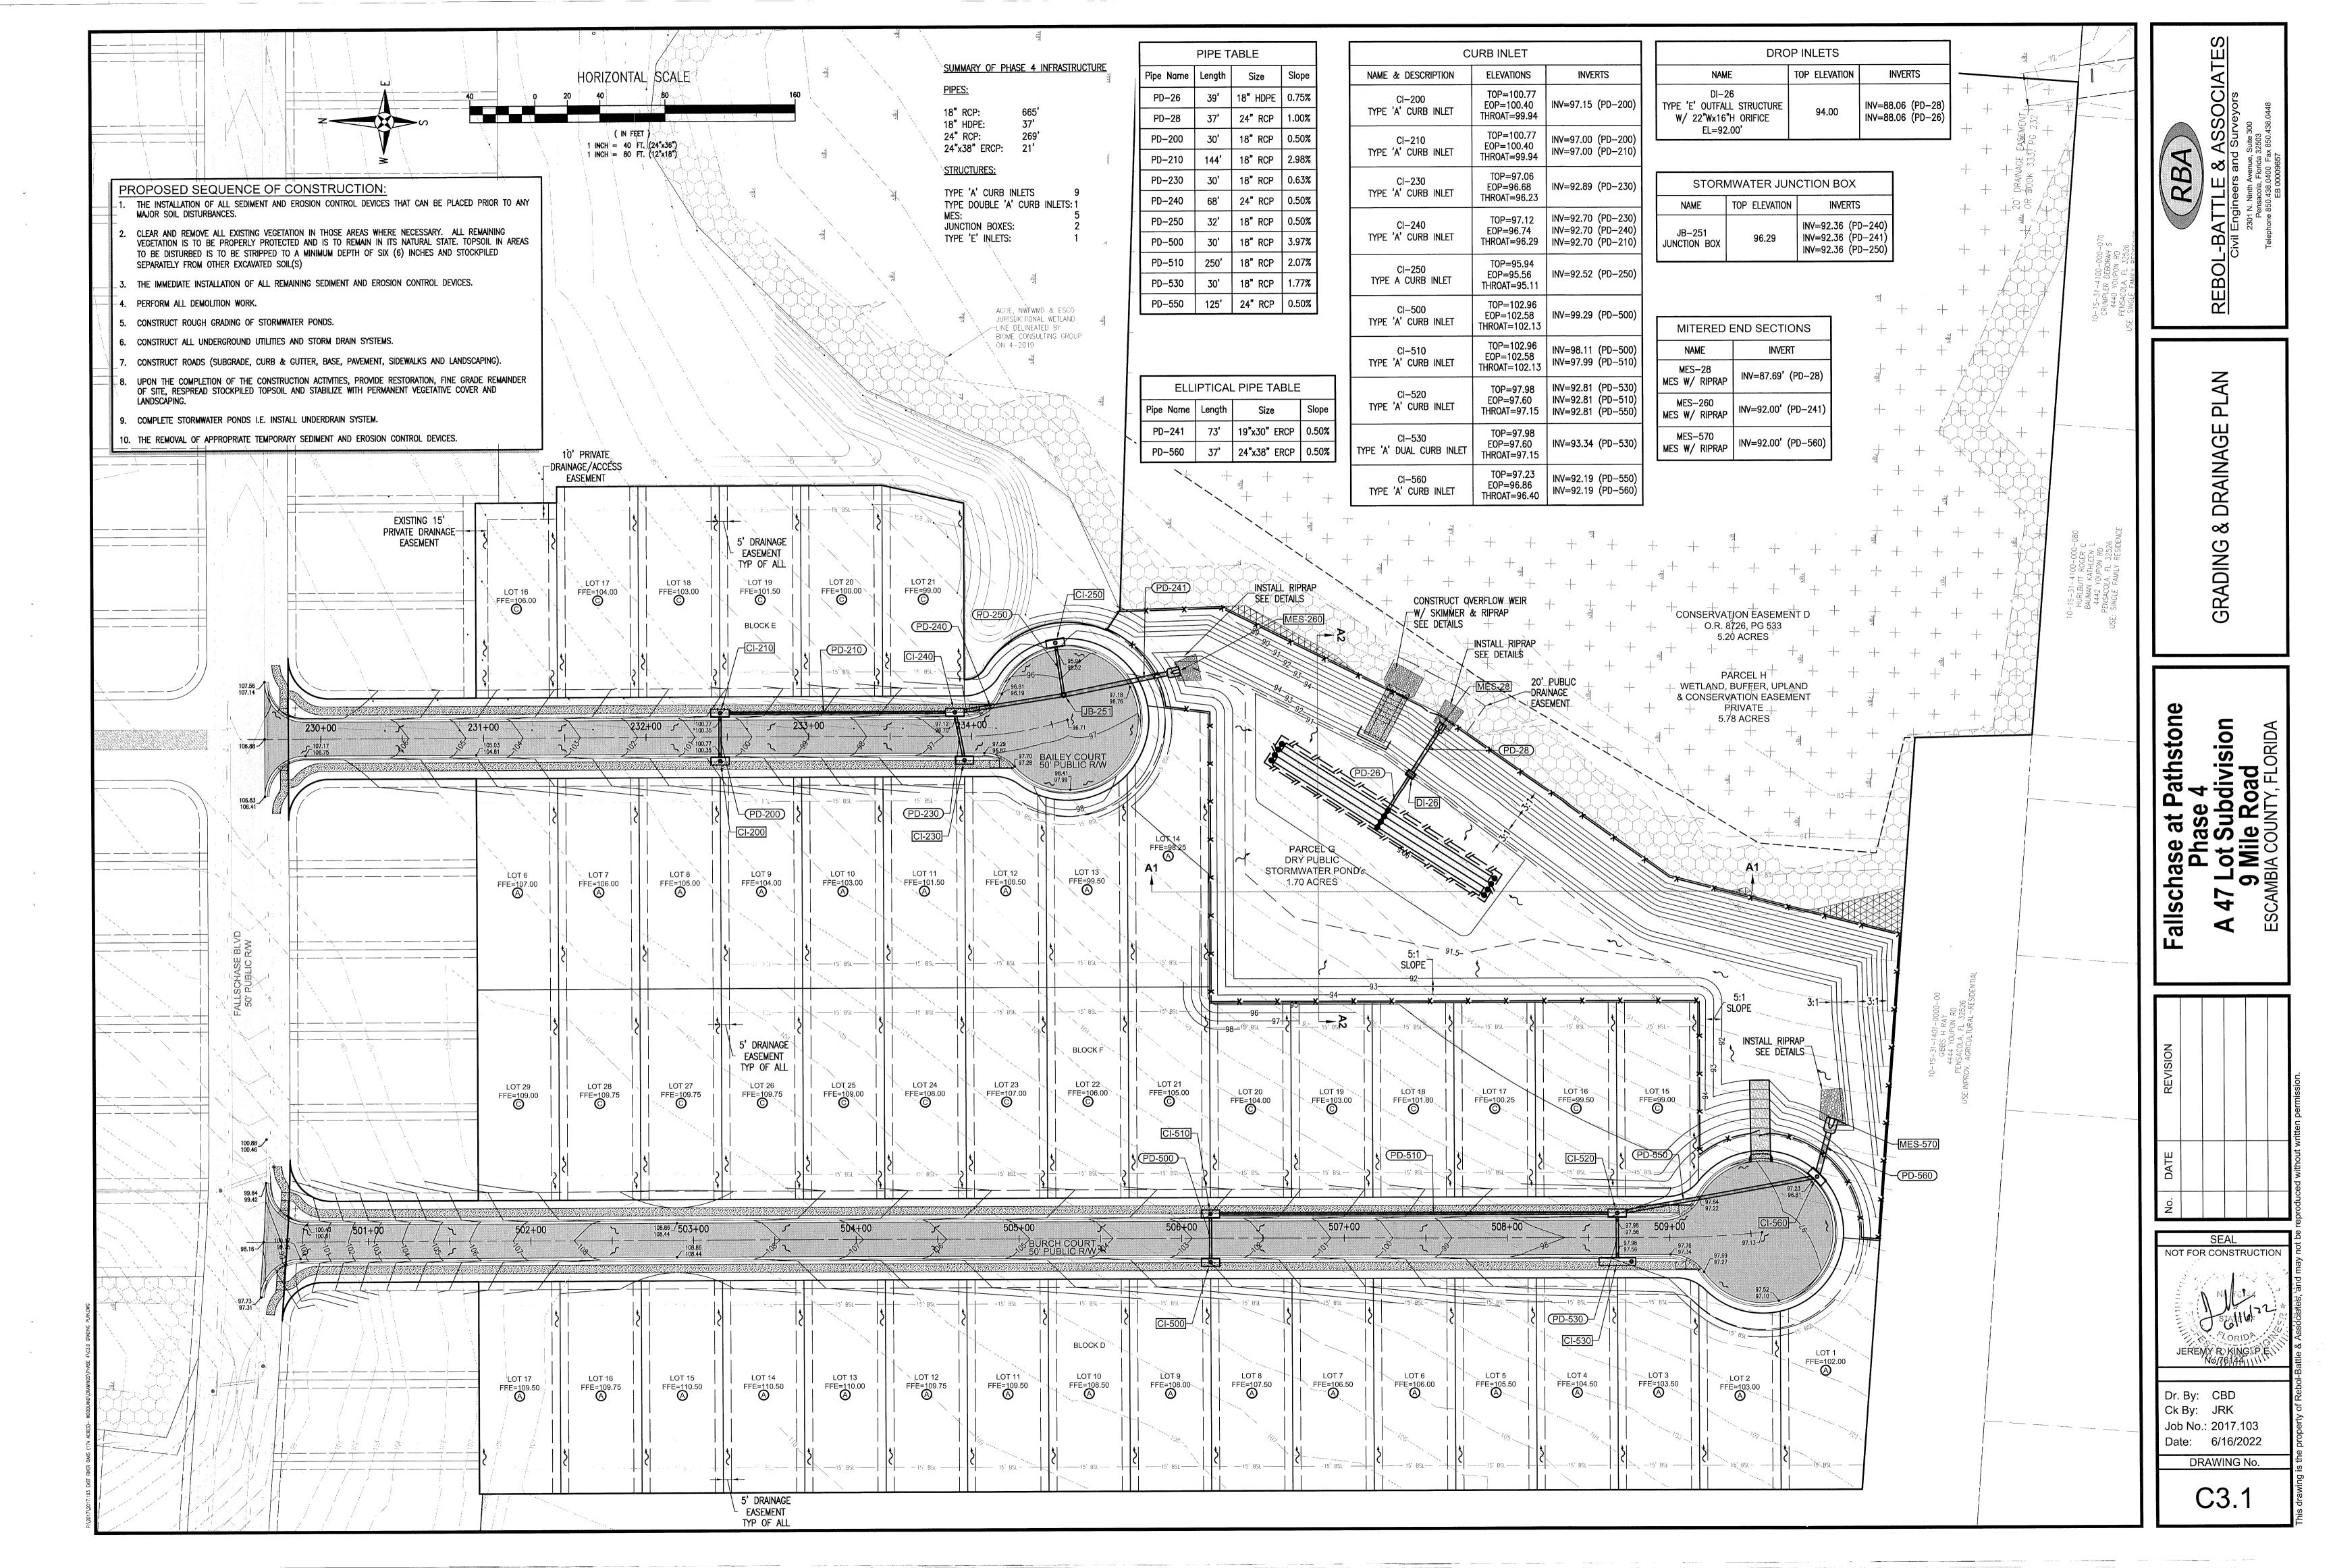

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GRADING AND DRAINAGE DETAILS

allschase at Pathstone
Phase 4
A 47 Lot Subdivision
9 Mile Road
ESCAMBIA COUNTY, FLORIDA

No. DATE REVISION

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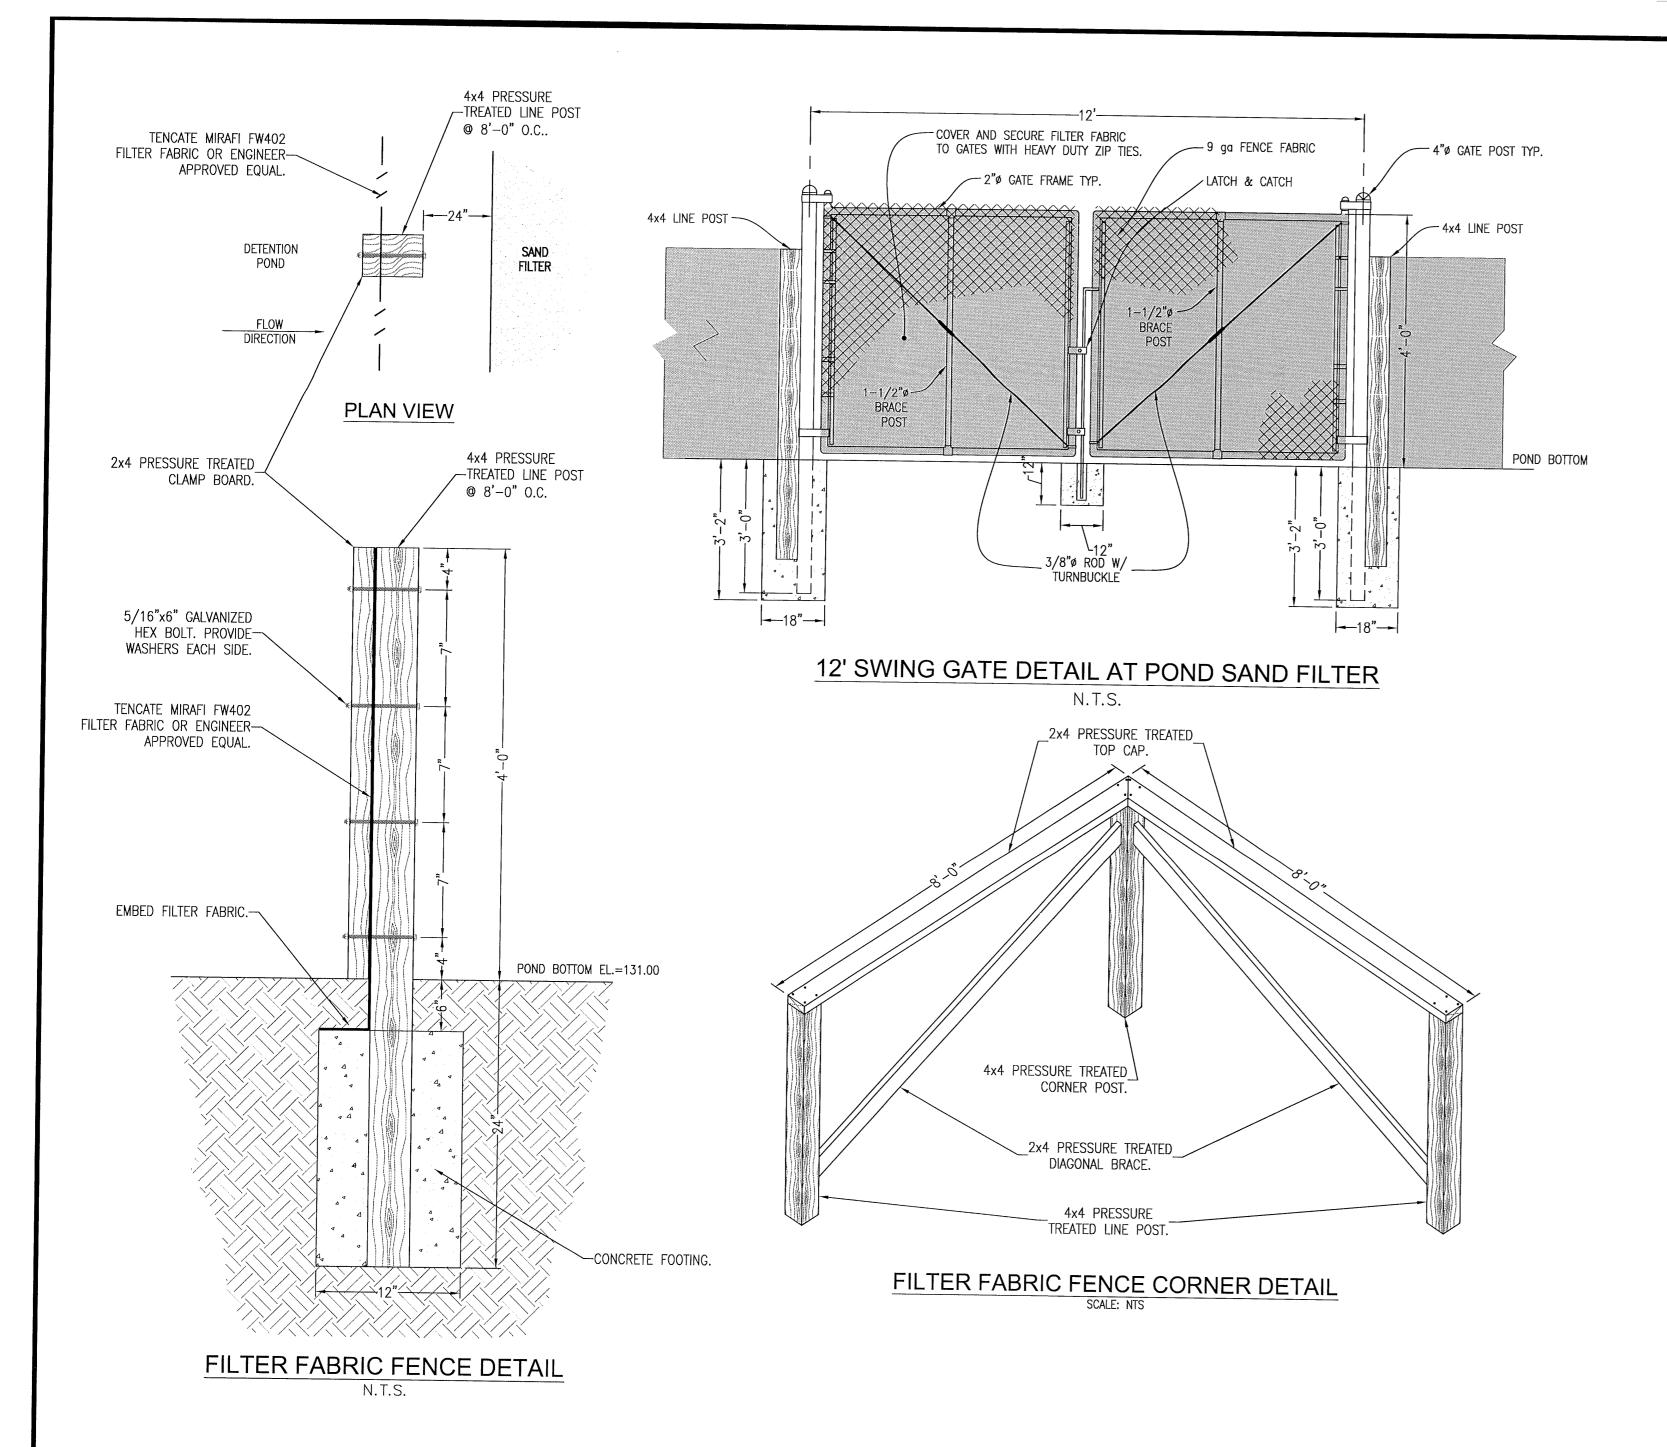
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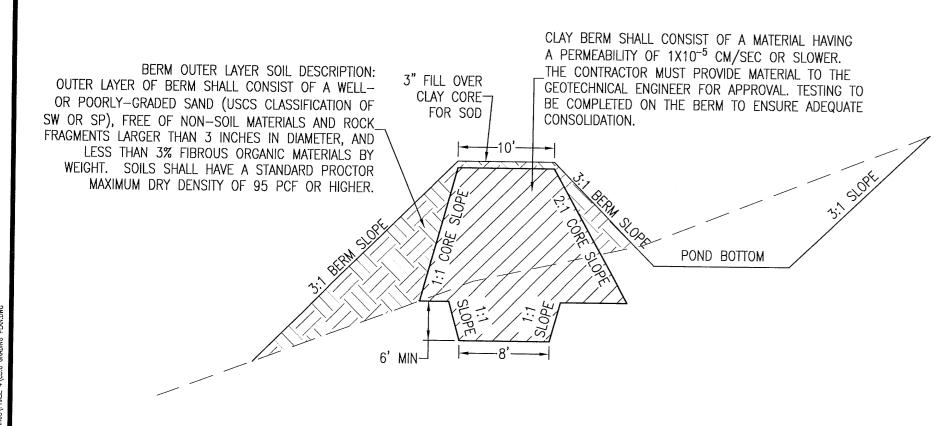
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JEREMY R. KING, P.E.

Dr. By: CBD Ck By: JRK Job No.: 2017.103 Date: 6/16/2022

DRAWING No.






BERM CORE DETAIL
SCALE: NTS

#### BERM NOTES:

- 1. CLAY CORE TO BE INSTALLED IN ALL POND BERMS. THE TOP OF THE CORE SHALL EXTEND TO THE TOP ELEVATION INDICATED ON THE SECTIONS.
- 2. PRIOR TO FILL PLACEMENT AGAINST EXISTING SLOPES, LOOSE SURFICIAL MATERIALS SHOULD BE REMOVED, AND THE SLOPE SHOULD BE BENCHED OR STEPPED TO PROVIDE HORIZONTAL BENCHES FOR COMPACTION, AND TO REDUCE THE POSSIBLE MOVEMENT OF SOIL ALONG THE SLOPE INTERFACE.
- 3. AFTER COMPLETION OF SUBGRADE PREPARATION AS DESCRIBED IN #2, STRUCTURAL FILL CAN BE PLACED TO BRING THE SITE TO FINAL GRADE. STRUCTURAL FILL SHOULD BE PLACED IN LAYERS NOT EXCEEDING 8 INCHES IN THICKNESS WHEN LOOSE AND SHOULD BE COMPACTED TO A MINIMUM SOIL DENSITY OF AT LEAST 95 PERCENT OF THE STANDARD PROCTOR MAXIMUM DRY DENSITY (ASTM D-698). WHERE PORTABLE HAND EQUIPMENT IS REQUIRED, MAXIMUM LIFT THICKNESS SHOULD BE 4 INCHES LOOSE MEASURE. SOIL MOISTURE CONTENT SHOULD BE MAINTAINED WITHIN -2 TO +3 PERCENT OF THE OPTIMUM MOISTURE CONTENT. SCARIFICATION AND BENCHING OF FILL MATERIALS COULD BE REQUIRED TO ADEQUATELY BOND THE FILL MATERIALS TO THE EXISTING SOILS.
- 4. PRIOR TO PROCEEDING WITH CONSTRUCTION OPERATIONS, THE ENTIRE DAM FOOTPRINT SHOULD BE STRIPPED OF SURFACE AND NEAR SURFACE DEBRIS. IT IS RECOMMENDED THAT CLEARING AND STRIPPING OPERATIONS EXTEND BEYOND THE DOWNSLOPE TOE OF THE NEW DAM SECTION, IF ADJACENT WETLANDS DO NOT LIMIT CONSTRUCTION. THIS OPERATION SHOULD CONSIST OF COMPLETE REMOVAL AND WASTING OF TREES, TOPSOIL, ROOT SYSTEMS, LOOSE SEDIMENT

DEPOSITS, AND OTHER NON-SOIL MATERIALS.

5. COORDINATION OF THE SITE AND SUBGRADE PREPARATION WITH THE GEOTECHNICAL ENGINEER DURING BERM CONSTRUCTION IS REQUIRED. THE GEOTECHNICAL ENGINEER WILL MAKE FIELD DECISIONS SHOULD PROBLEMS ARISE IN SPECIFIC AREAS CONCERNING UNDERCUTTING, GROUNDWATER CONTROL, SUBGRADE STABILIZATION AND OTHER REMEDIAL TECHNIQUES. ALL SUBGRADE AREAS SHOULD BE APPROVED BY THE GEOTECHNICAL ENGINEER PRIOR TO FILL

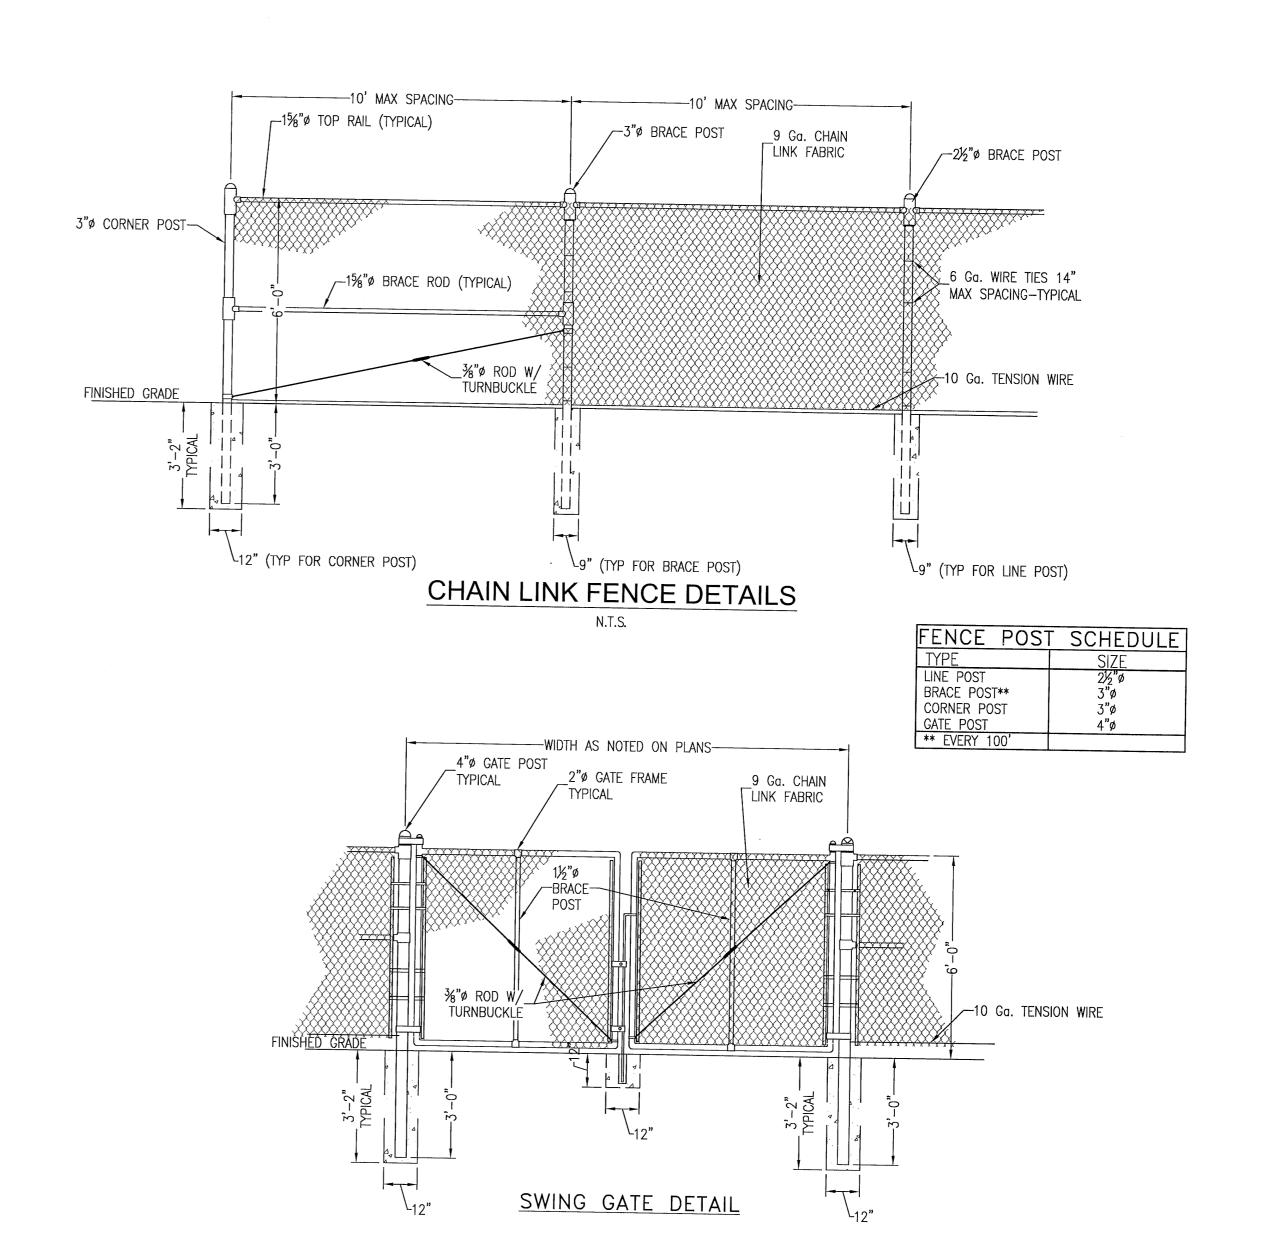


CHAIN LINK FENCE DETAILS

PROPOSED SEQUENCE OF CONSTRUCTION:

THE INSTALLATION OF ALL SEDIMENT AND EROSION CONTROL DEVICES THAT CAN BE PLACED PRIOR TO ANY MAJOR SOIL DISTURBANCES.


- 2. CLEAR AND REMOVE ALL EXISTING VEGETATION IN THOSE AREAS WHERE NECESSARY. ALL REMAINING VEGETATION IS TO BE PROPERLY PROTECTED AND IS TO REMAIN IN ITS NATURAL STATE. TOPSOIL IN AREAS TO BE DISTURBED IS TO BE STRIPPED TO A MINIMUM DEPTH OF SIX (6) INCHES AND STOCKPILED SEPARATELY FROM OTHER EXCAVATED SOIL(S)
- 3. THE IMMEDIATE INSTALLATION OF ALL REMAINING SEDIMENT AND EROSION CONTROL DEVICES.
- 4. PERFORM ALL DEMOLITION WORK.
- 5. CONSTRUCT ROUGH GRADING OF STORMWATER PONDS.
- 6. CONSTRUCT ALL UNDERGROUND UTILITIES AND STORM DRAIN SYSTEMS.
- 7. CONSTRUCT ROADS (SUBGRADE, CURB & GUTTER, BASE, PAVEMENT, SIDEWALKS AND LANDSCAPING).
- 8. UPON THE COMPLETION OF THE CONSTRUCTION ACTIVITIES, PROVIDE RESTORATION, FINE GRADE REMAINDER OF SITE, RESPREAD STOCKPILED TOPSOIL AND STABILIZE WITH PERMANENT VEGETATIVE COVER AND
- 9. COMPLETE STORMWATER PONDS I.E. INSTALL UNDERDRAIN SYSTEM.
- 10. THE REMOVAL OF APPROPRIATE TEMPORARY SEDIMENT AND EROSION CONTROL DEVICES.

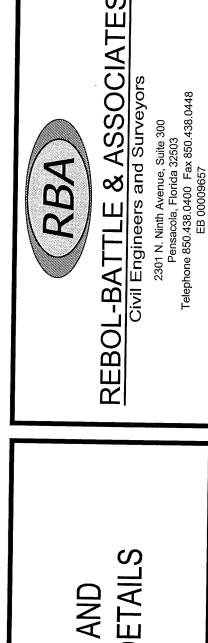

GRADING AND DRAINAGE DETAILS


Fallschase at Pathstone
Phase 4
A 47 Lot Subdivision
9 Mile Road
ESCAMBIA COUNTY, FLORIDA

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POND 'G' DETAILS

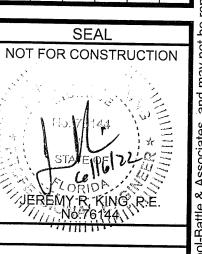Fallschase at Pathstone
Phase 4
A 47 Lot Subdivision
9 Mile Road
ESCAMBIA COUNTY, FLORIDA

No. DATE REVISION

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No. 144
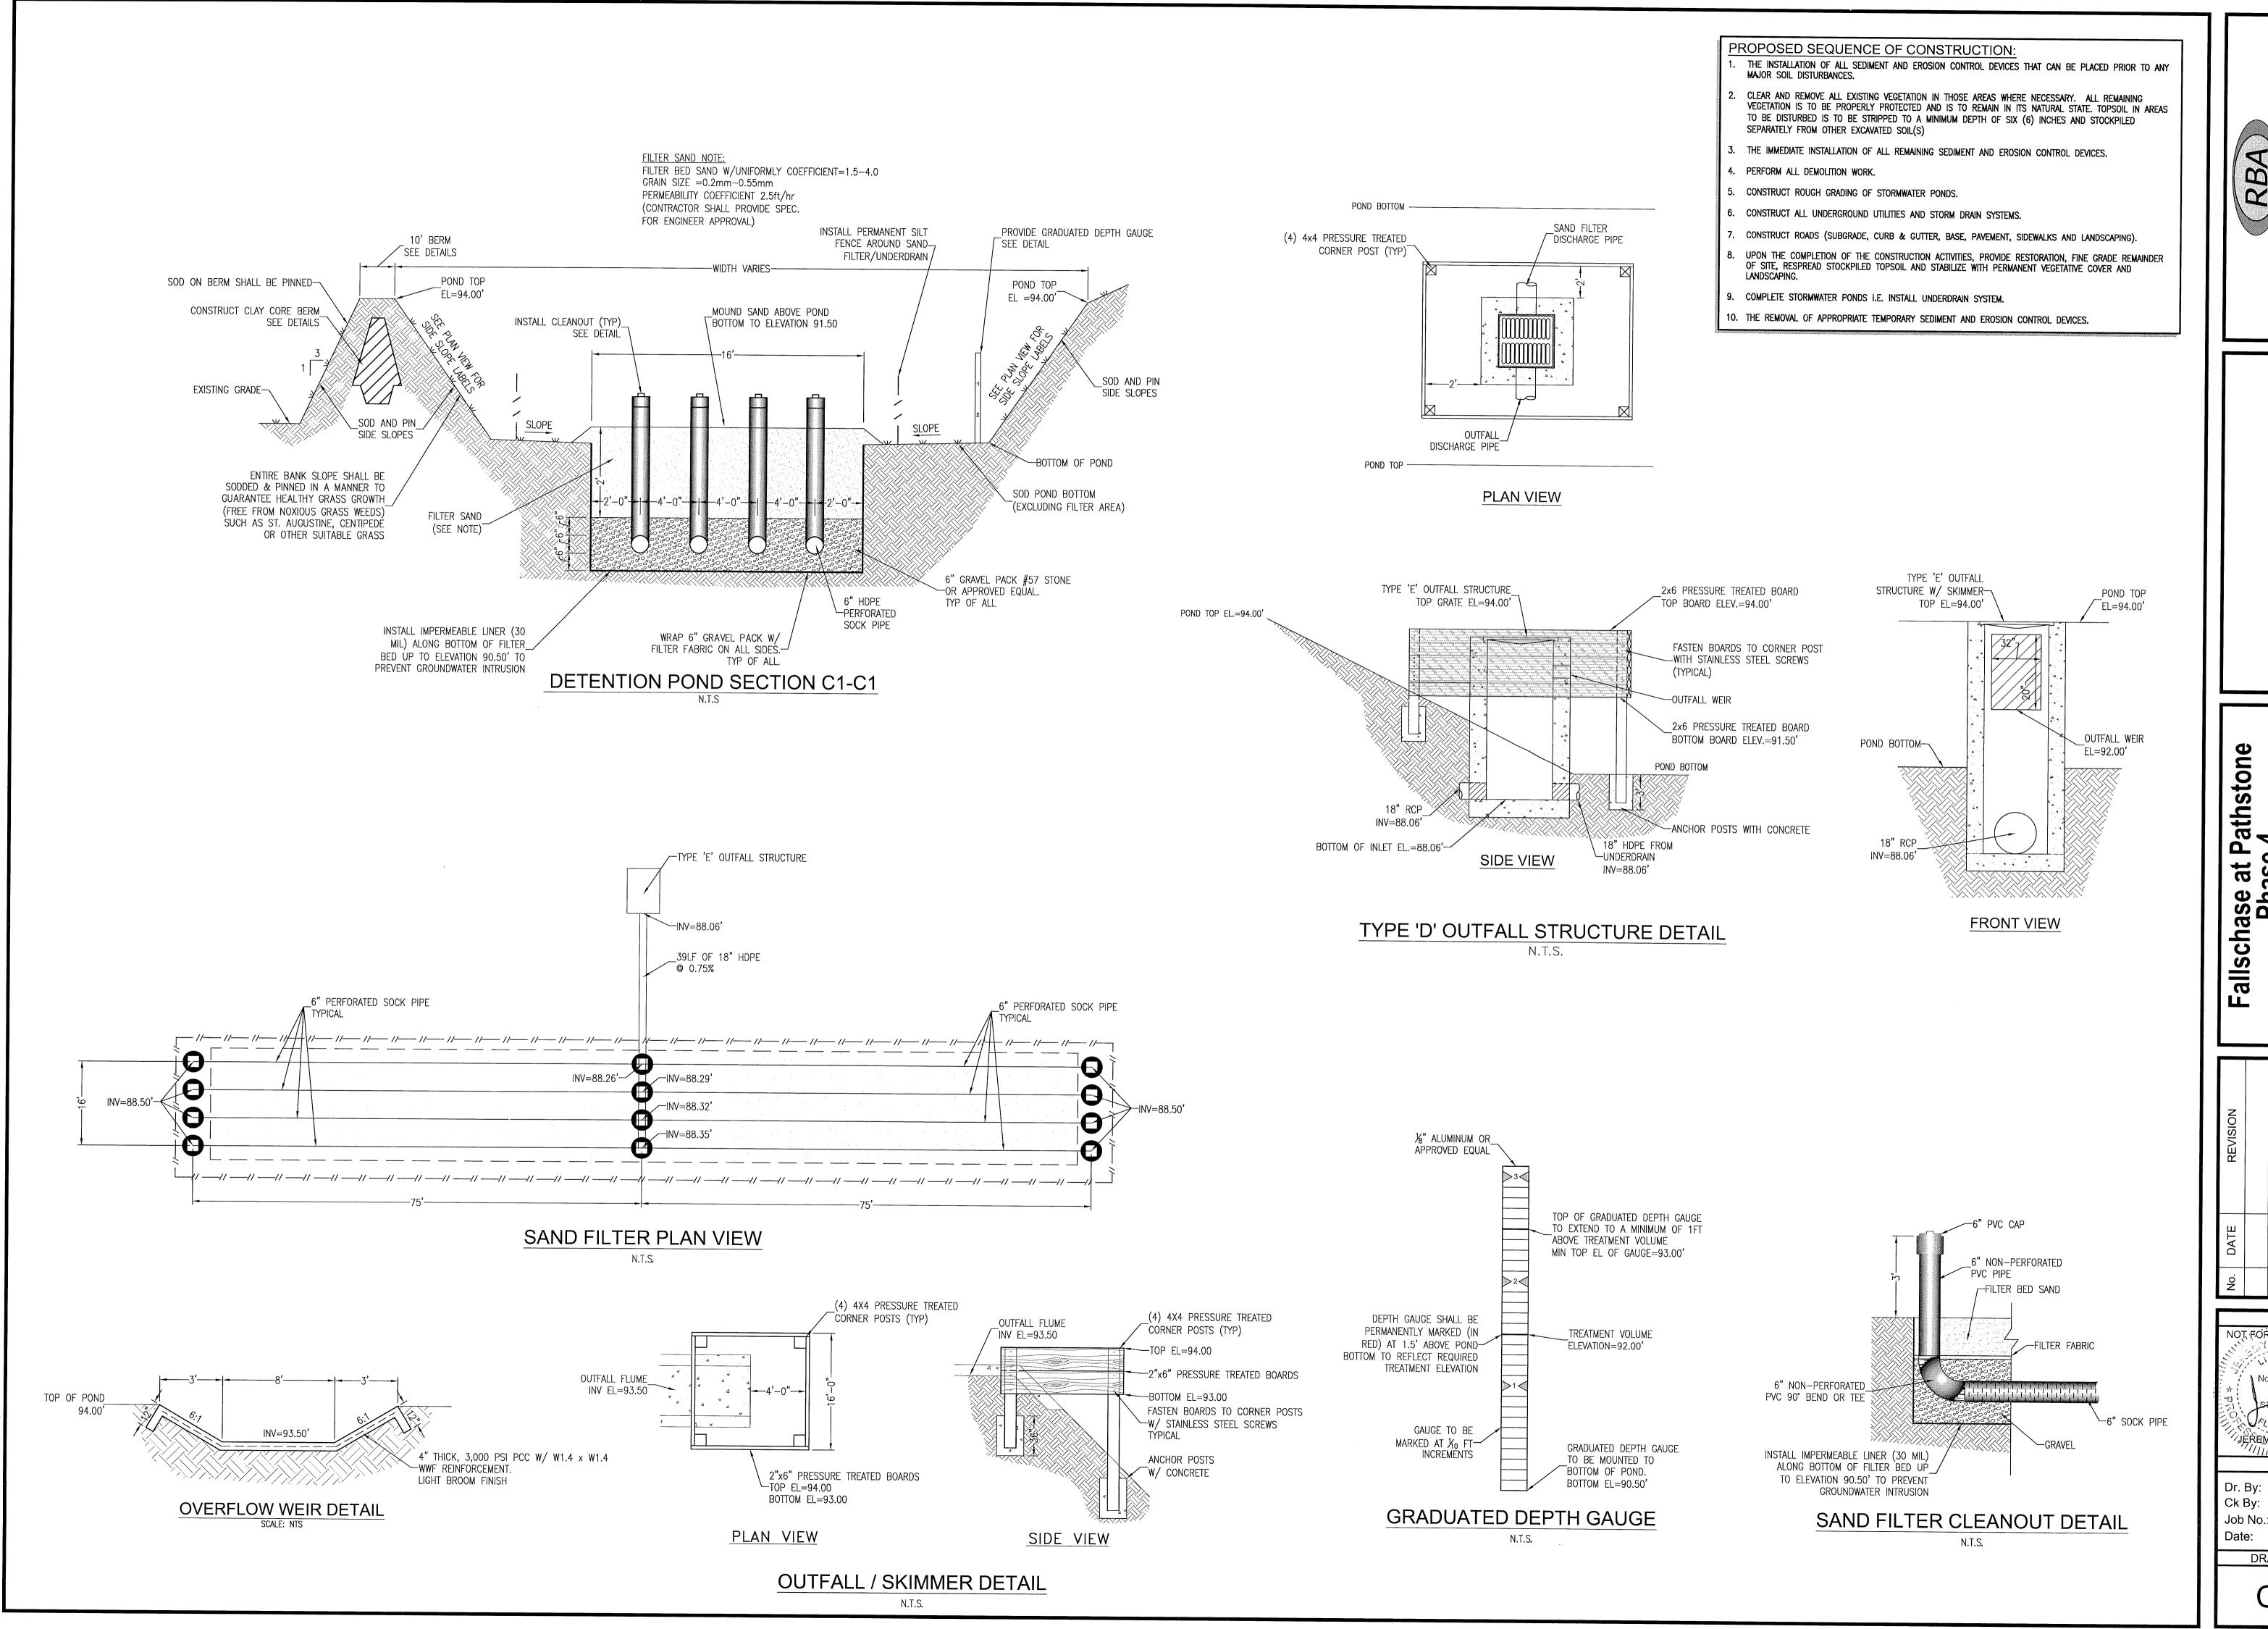
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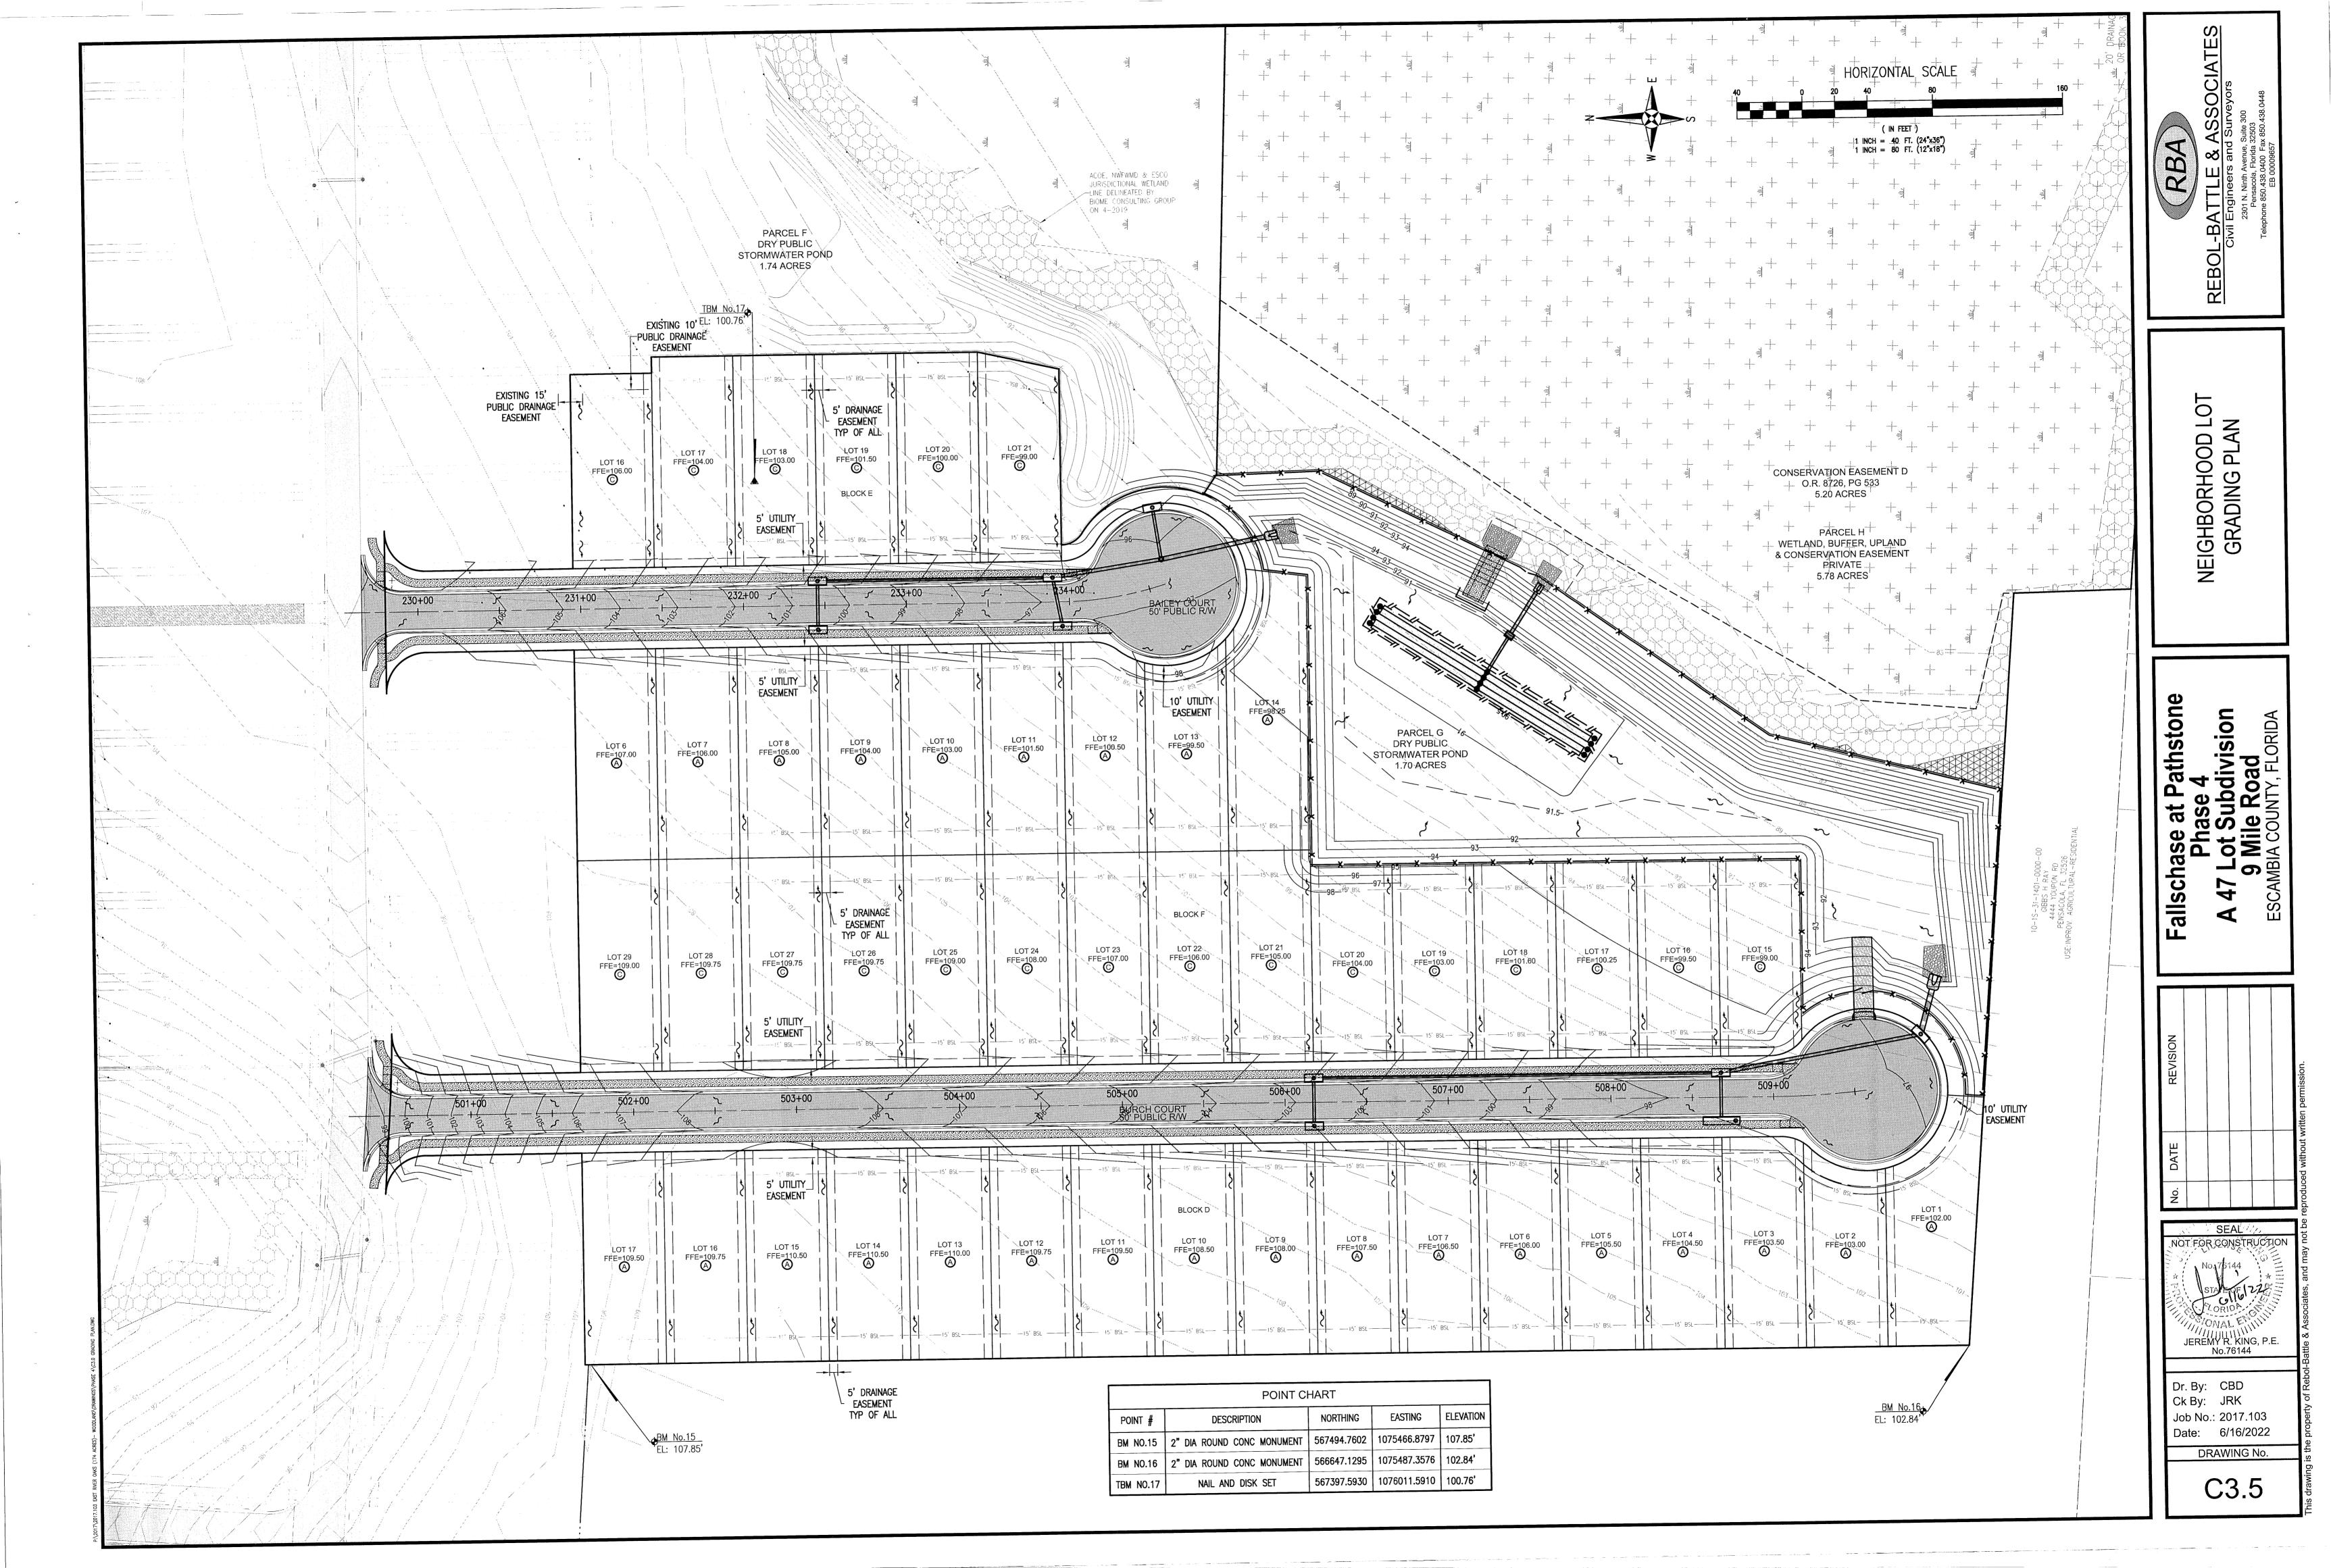
FACILITY


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JEREMY R. KING, P.E.

Dr. By: CBD Ck By: JRK Job No.: 2017.103 Date: 6/16/2022

DRAWING No.



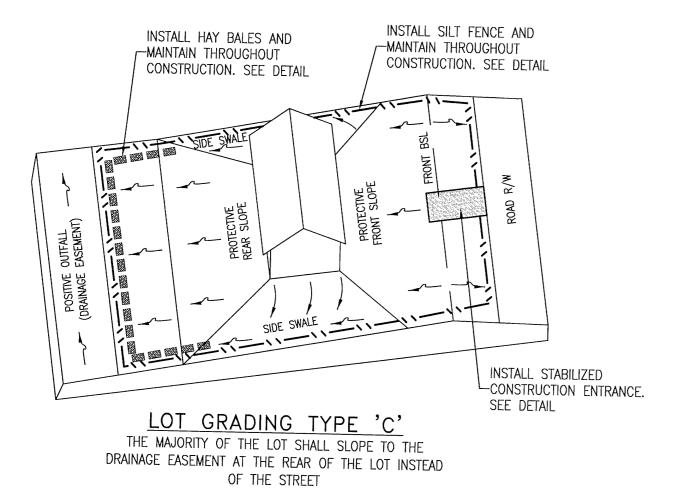


NOTE: VARIATIONS IN GRADING ARE ACCEPTABLE IF GRADING DRAINS TO A POSITIVE OUTFALL.

NOTES:


- 1) ALL MATERIALS AND LABOR FOR INSTALLATION WILL BE THE RESPONSIBILITY OF THE PROPERTY OWNER/CONTRACTOR.
- 2) DRIVEWAYS ABUTTING PAVED ROADS SHALL BE 1 1/2" ASPHALT WITH 6" STABILIZED SUB GRADE OR 4" TO 6" CONCRETE WITH 4" STABILIZED SUB GRADE - 95% COMPACTION (MODIFIED PROCTOR) WITH LBR 40 BETWEEN EDGE OF ROADWAY AND R/W LINE. COMPACTION AND TESTING IF NECESSARY, THIS WILL BE THE RESPONSIBILITY OF THE OWNER/CONTRACTOR.
- DRIVEWAYS ABUTTING A DIRT ROAD SHALL BE MILLED ASPHALT, GRADED AGGREGATE BASE, OR WASHED CONCRETE (4" IN DEPTH) ON THE COUNTY MAINTAINED PORTION OF DRIVEWAY.
- 4) IF NECESSARY, REFER TO FDOT INDEX DETAILS AS REFERENCED BELOW.
- RADIUS OR FLARE IS REQUIRED FOR TYPE II OR TYPE III CONNECTIONS. SEE DETAIL.
- PARKING SPACES WITHIN COUNTY RIGHT-OF-WAY SHALL PROVIDE A MINIMUM OF 2 PARKING SPACES.
- 7) TYPICAL DRIVEWAY SECTIONS ARE TO BE 12' WIDE MINIMUM.

TYPE I


CURB CUT DRIVEWAY FOR COUNTY TYPE "B" LAYBACK CURBS.

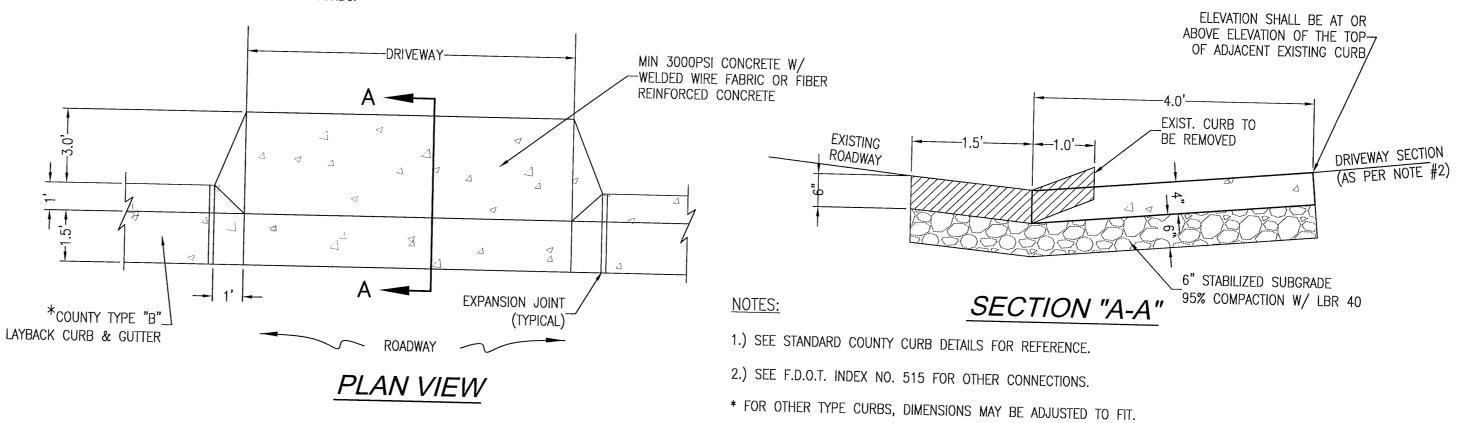


# TYPICAL DRIVEWAY CONNECTION STANDARDS FOR EXISTING ROADWAY CONDITIONS

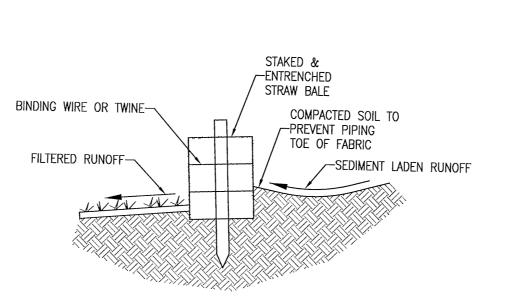

STRAW BALE DETAIL

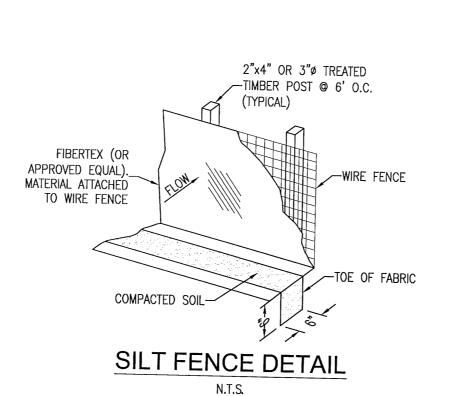

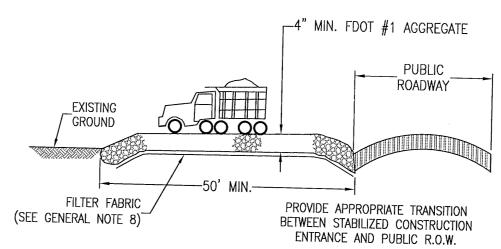

MAXIMUM LOT SURFACE COVERAGE

TOTAL IMPERVIOUS SURFACE

TOTAL NEW INFRASTRUCTURE

TOTAL IMPERVIOUS AREA FOR


POST DEVELOPMENT CONDITIONS

ALL RESIDENTIAL LOTS 3,500 SF (HOUSE & DRIVEWAY)

63,075 SF (ROADWAY, SIDEWALK, CURB)

236,975 SF (NEW INFRASTRUCTURE, LOTS)

12' WIDE STABILIZED CONSTRUCTION **ENTRANCE DETAIL** 

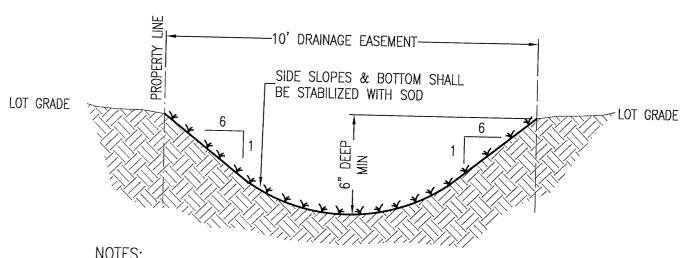

NOTES:


1. SIDE YARD SWALES SHALL BE BUILT BY THE HOMEBUILDER. CONVEYANCE SWALES TO BE BUILT BY CONTRACTOR.

2. HOME EQUIPMENT (I.E. AC UNITS) SHALL NOT HINDER THE PROPER INSTALLATION AND/OR FUNCTION OF THE SIDE YARD SWALES 3. ALL NEW ROOF RUNOFF, DOWNSPOUTS, AND GUTTERS, SHALL BE ROUTED TO CARRY

ALL STORMWATER TO THE ROADS OR SWALES THAT LEAD TO THE RETENTION POND TYPICAL PRIVATE 10' DRAINAGE EASEMENT SWALE


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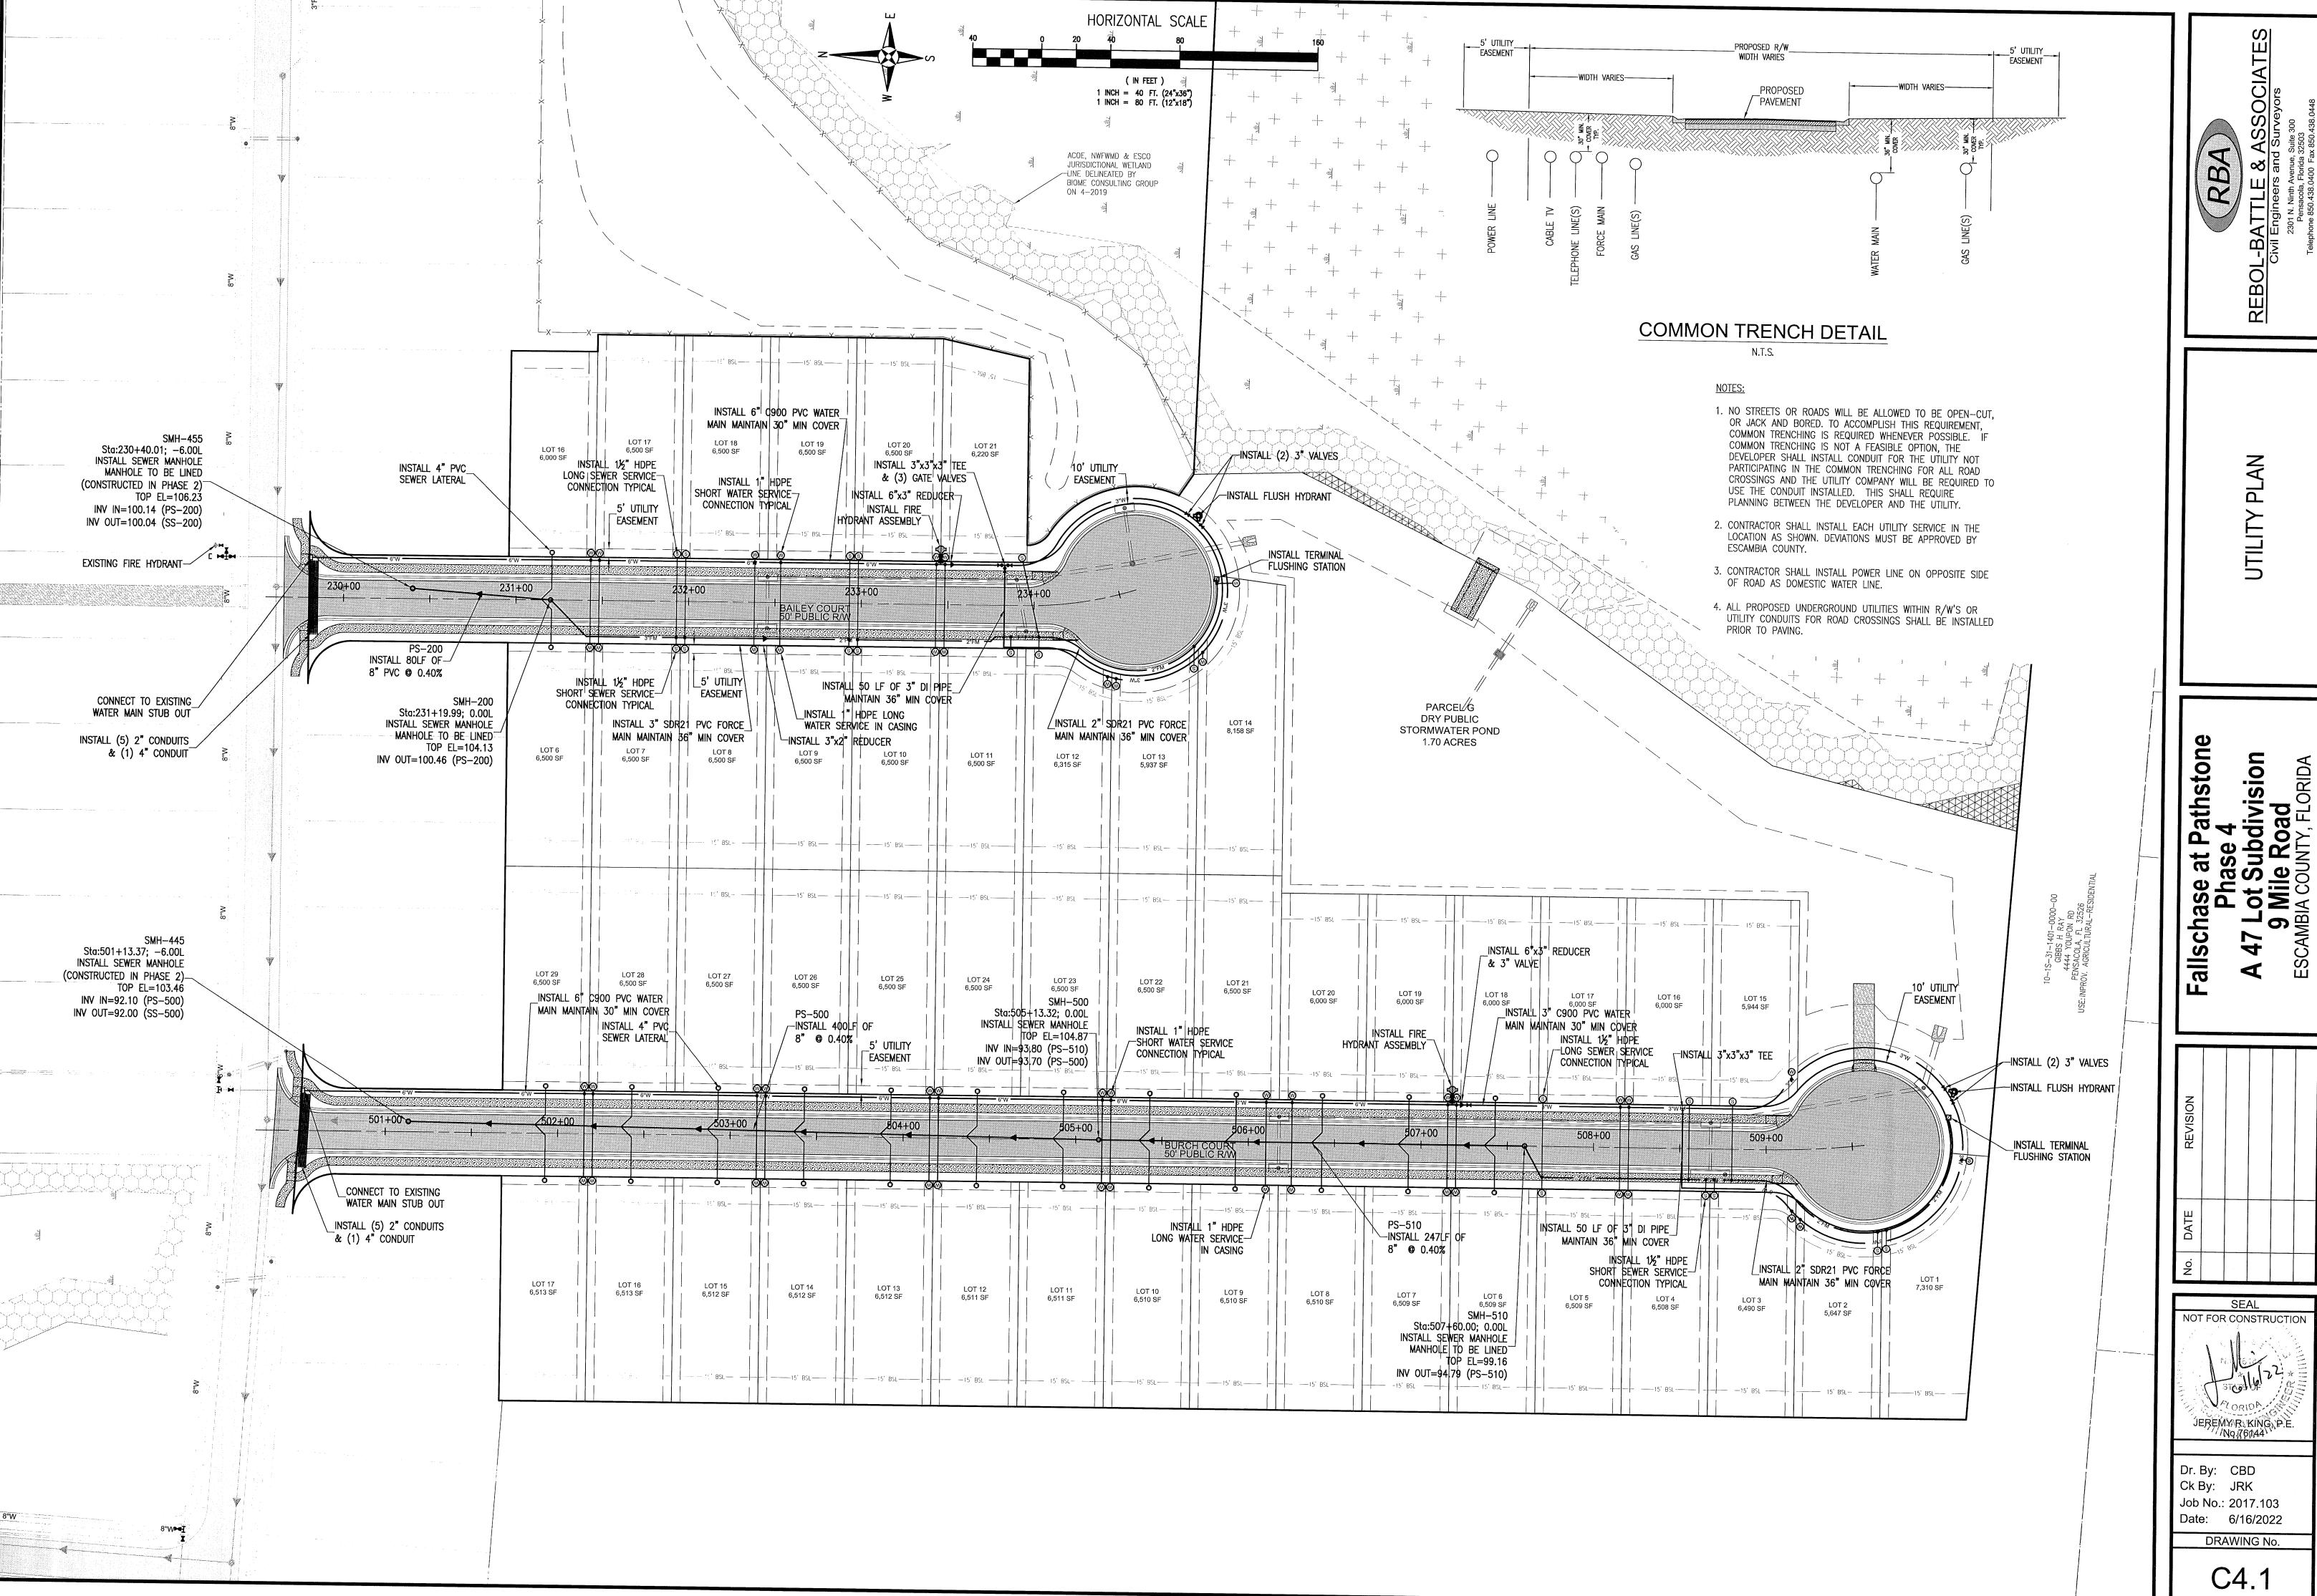
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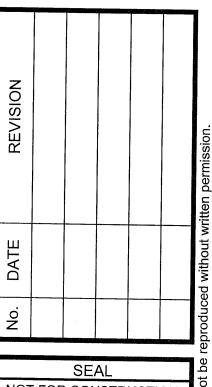



SEAL NOT FOR CONSTRUCTION VEREMY R. KING R.E. WAL FROM Dr. By: CBD

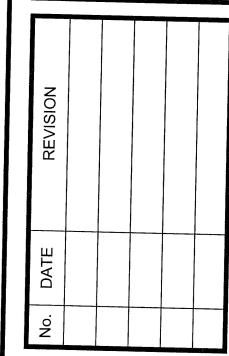
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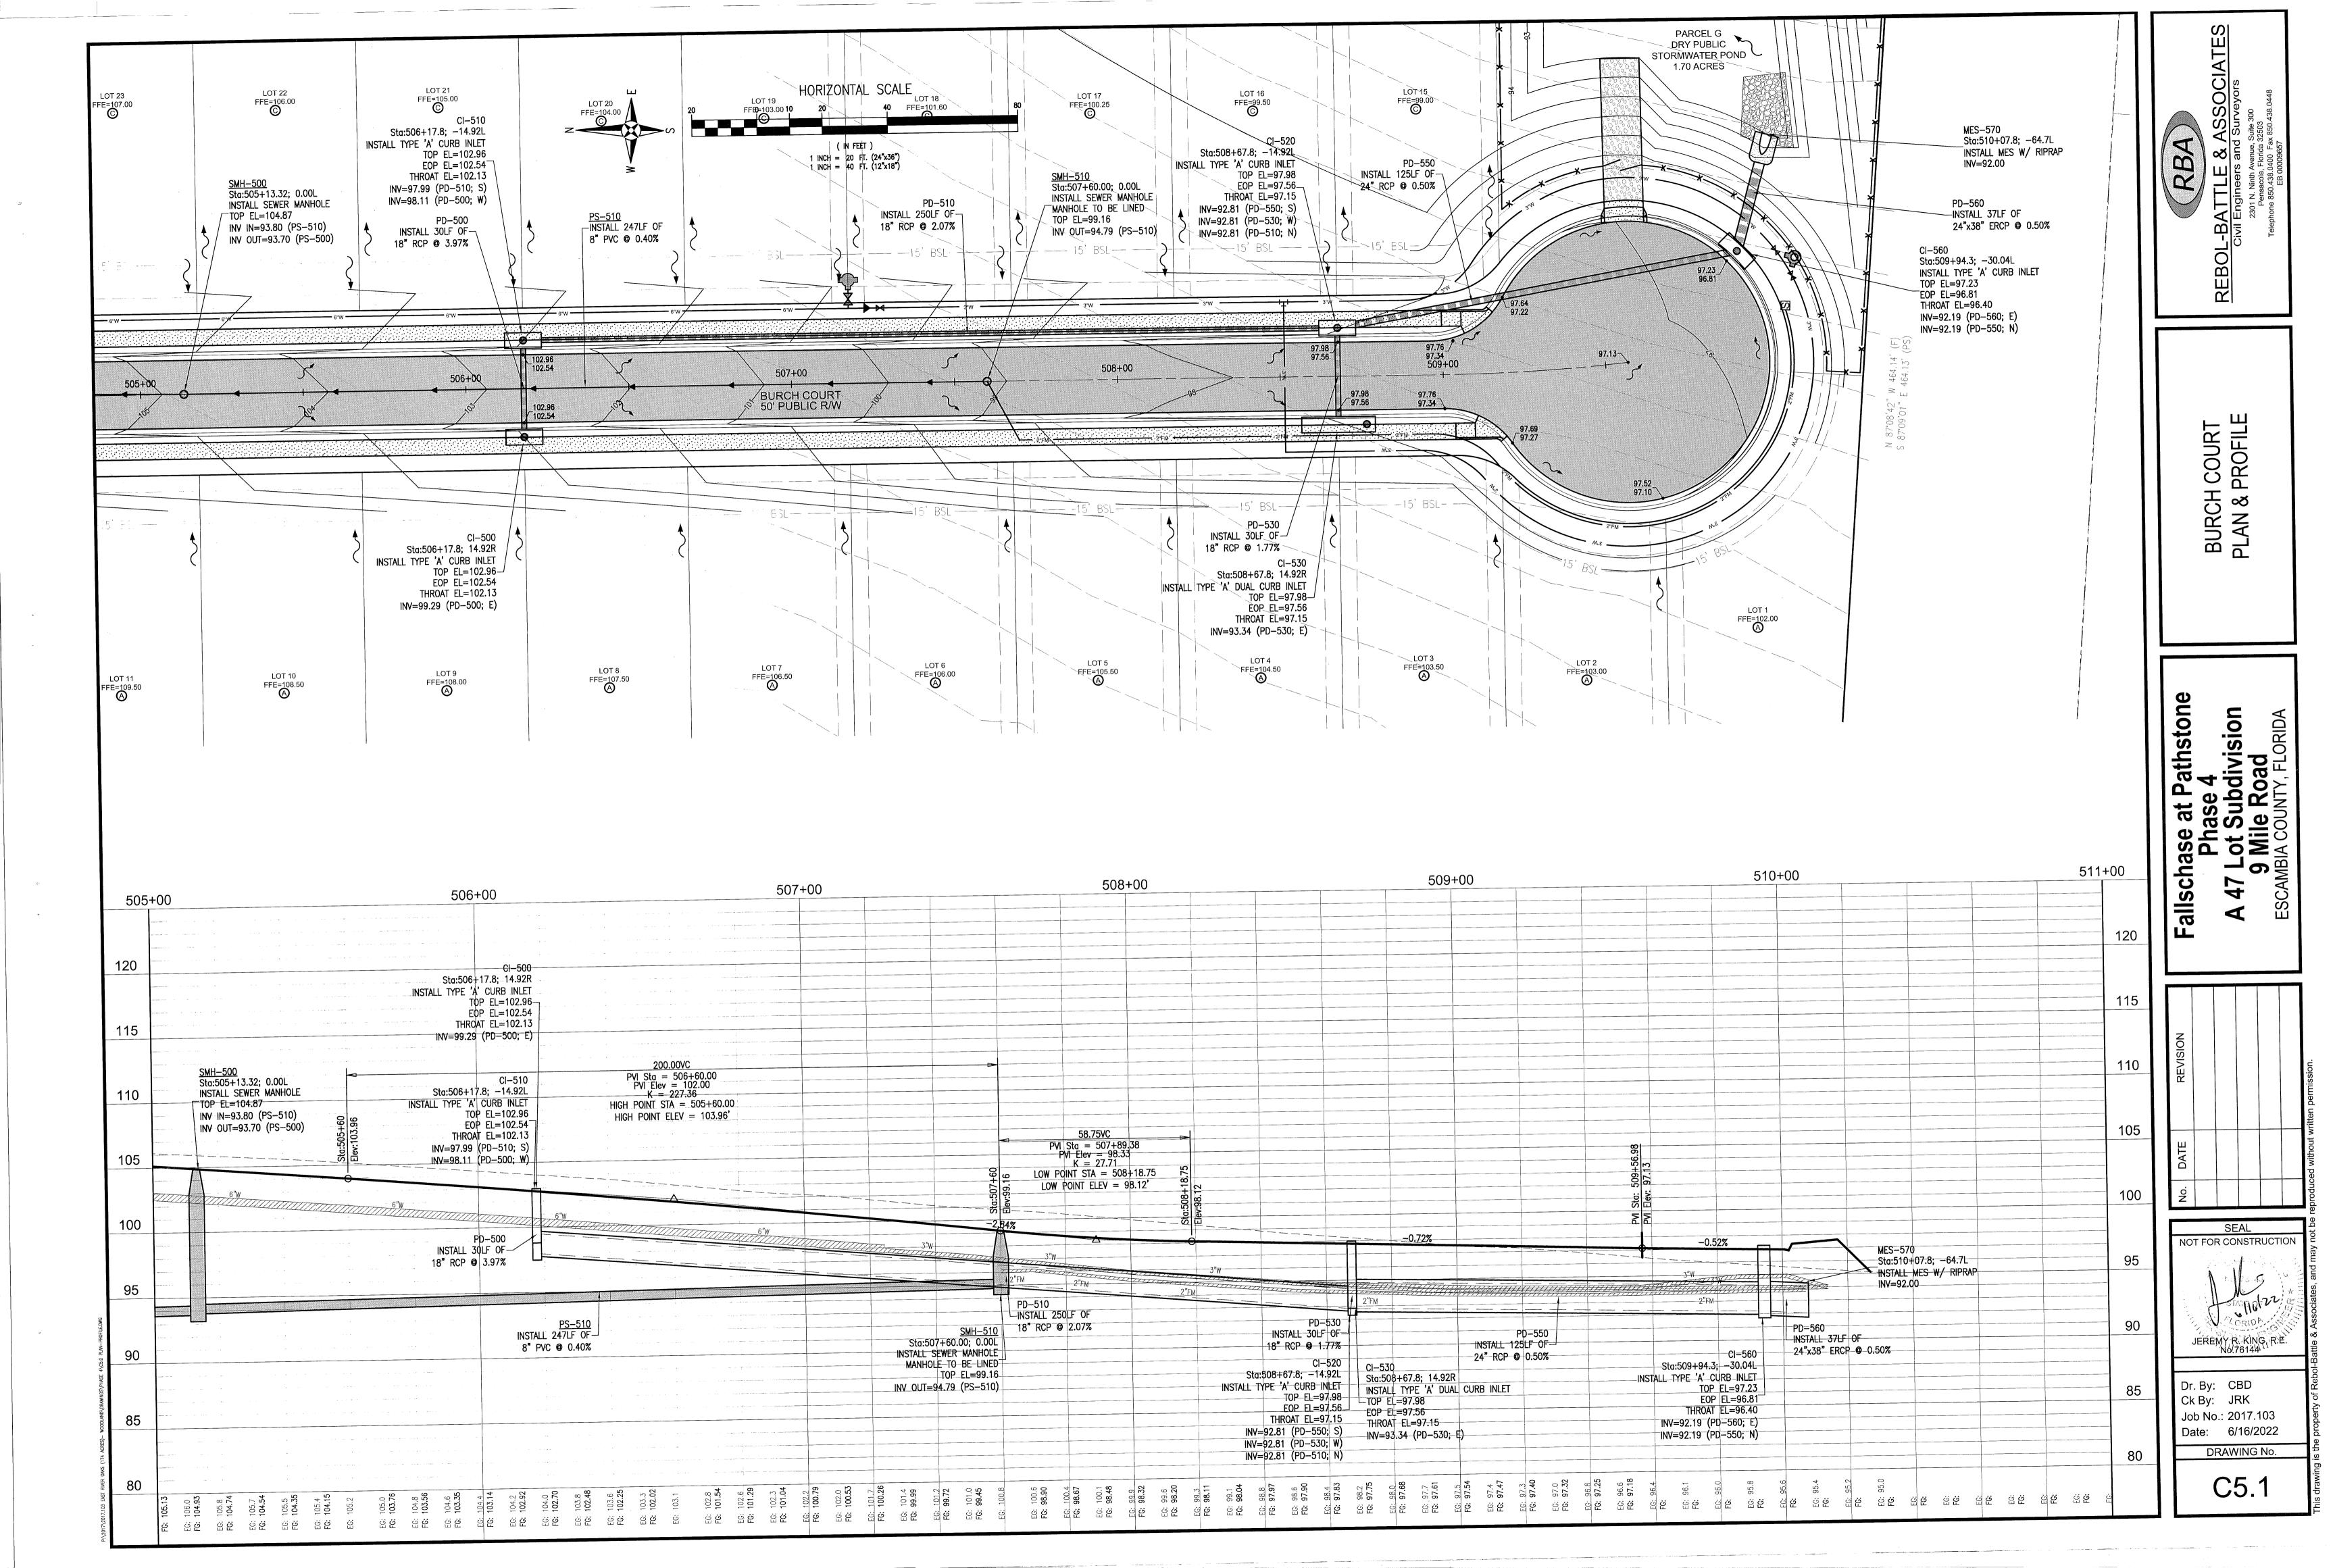








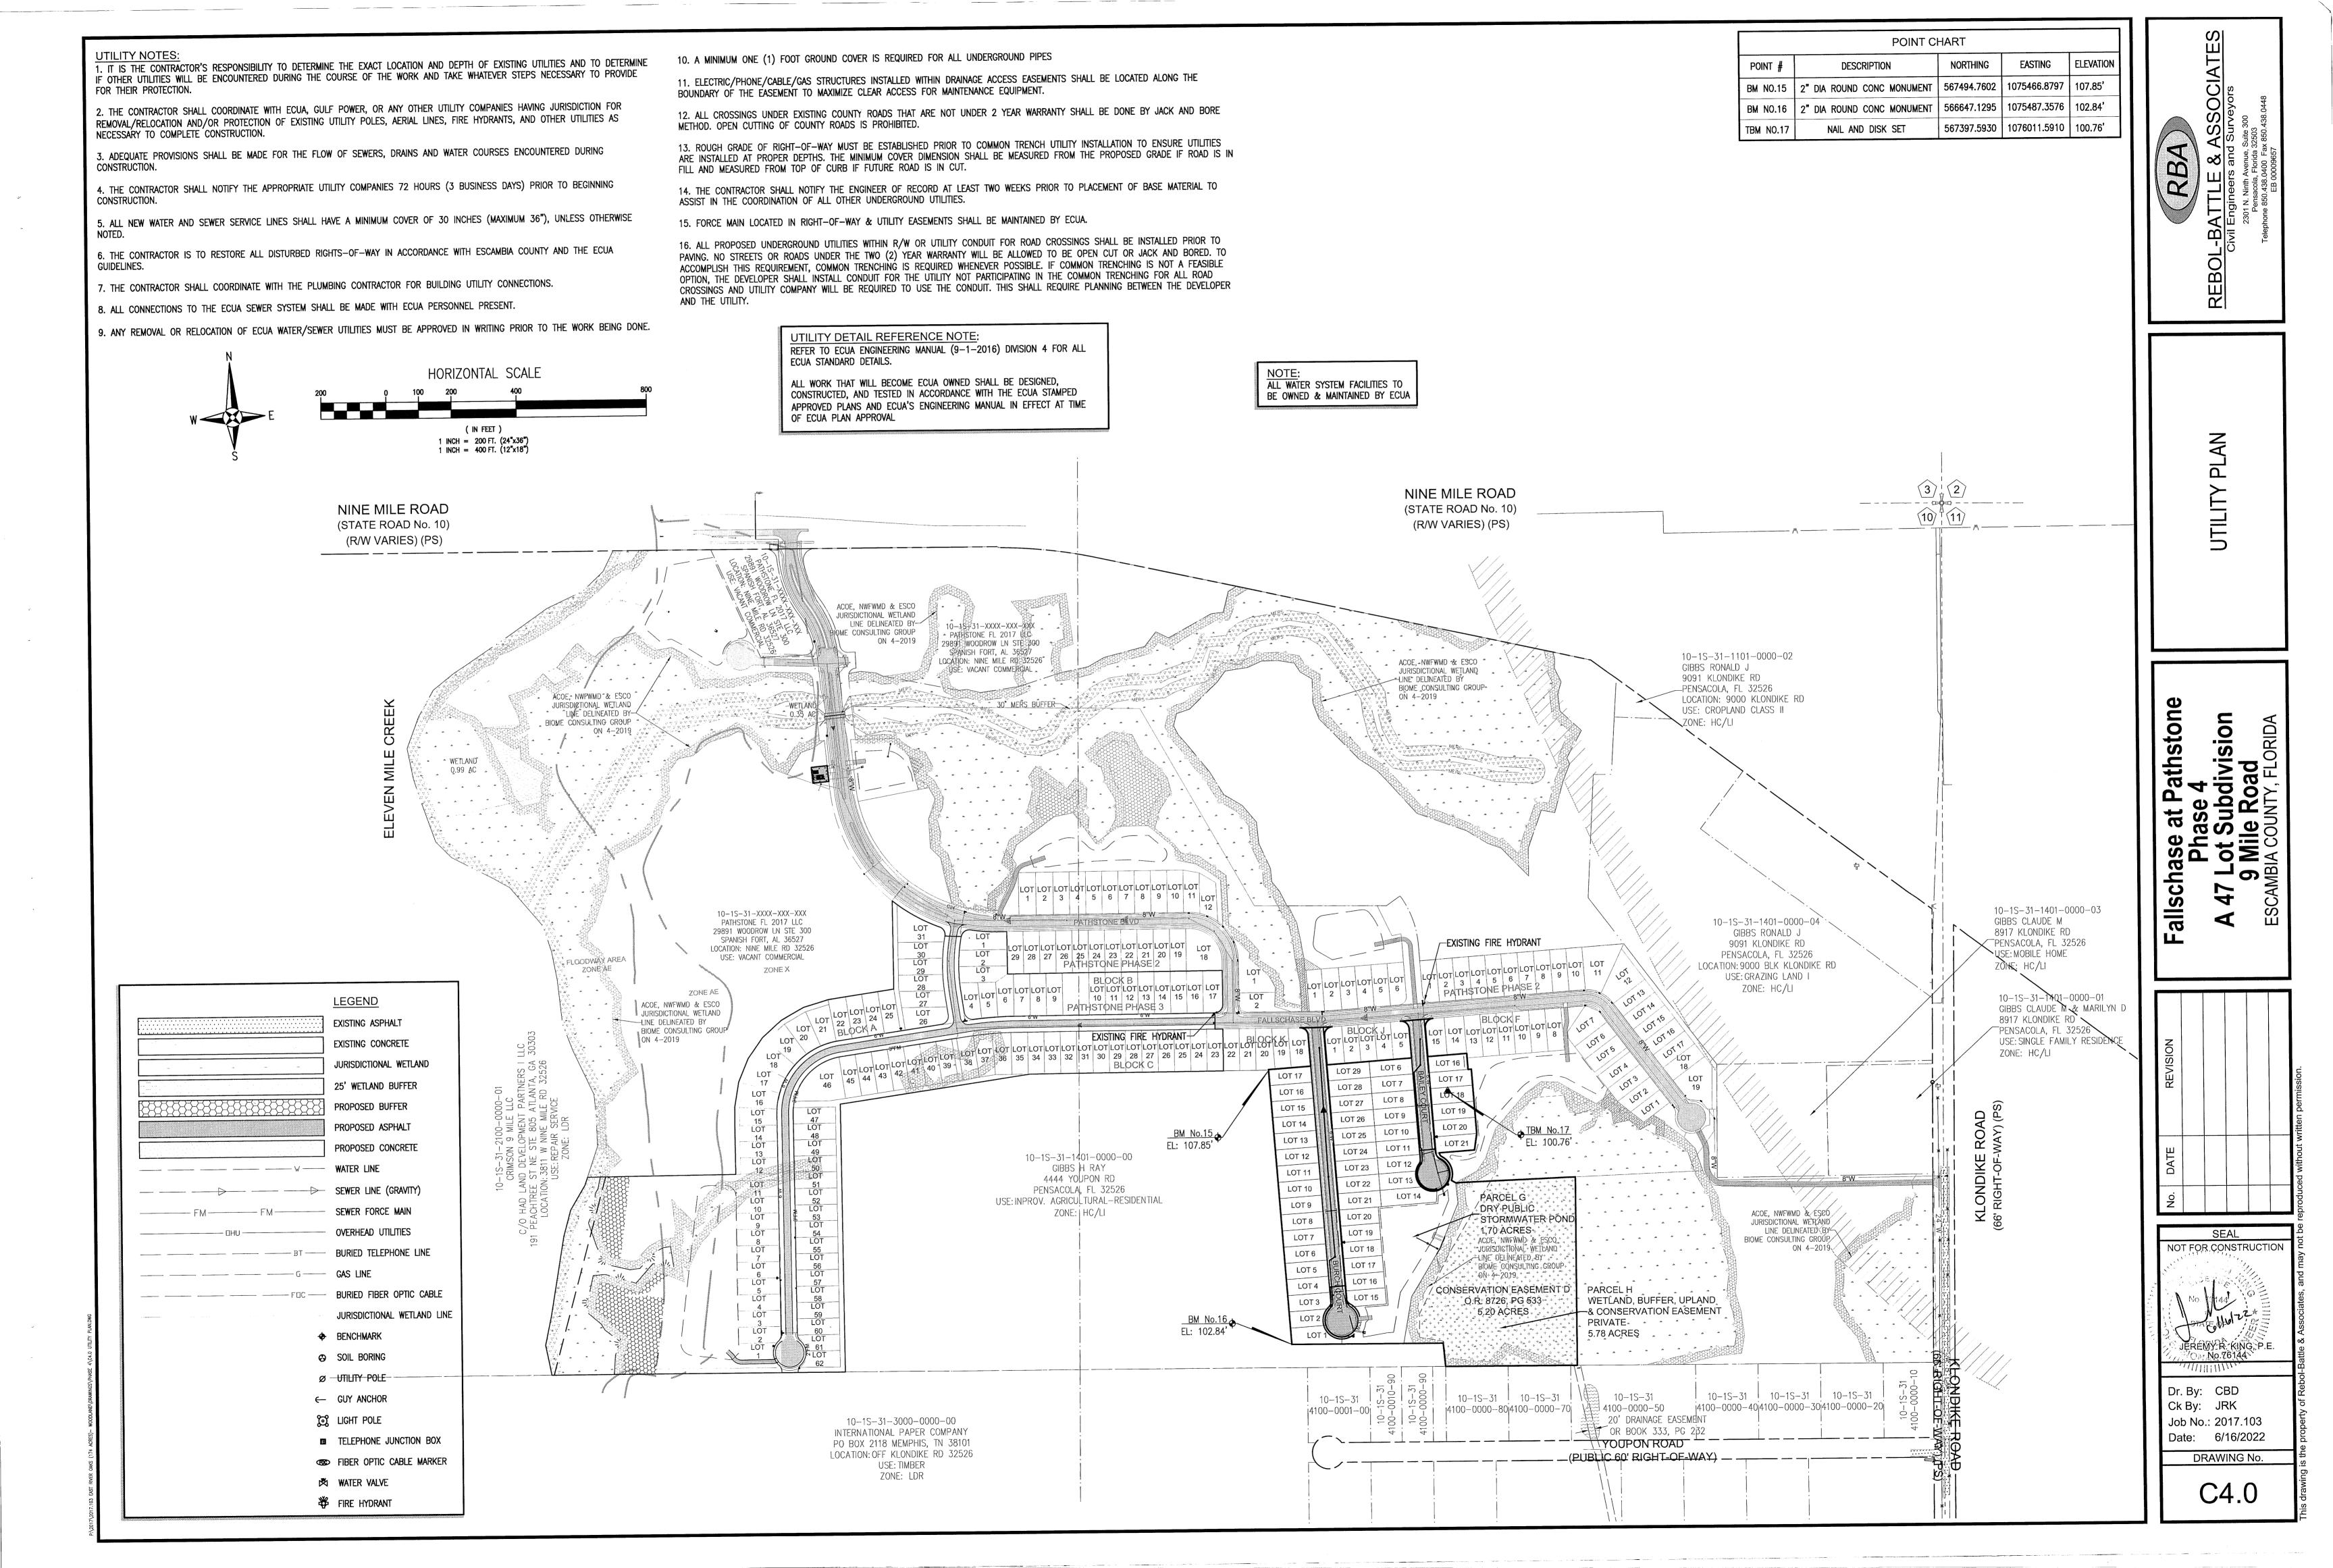


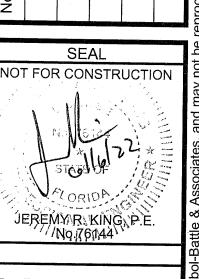


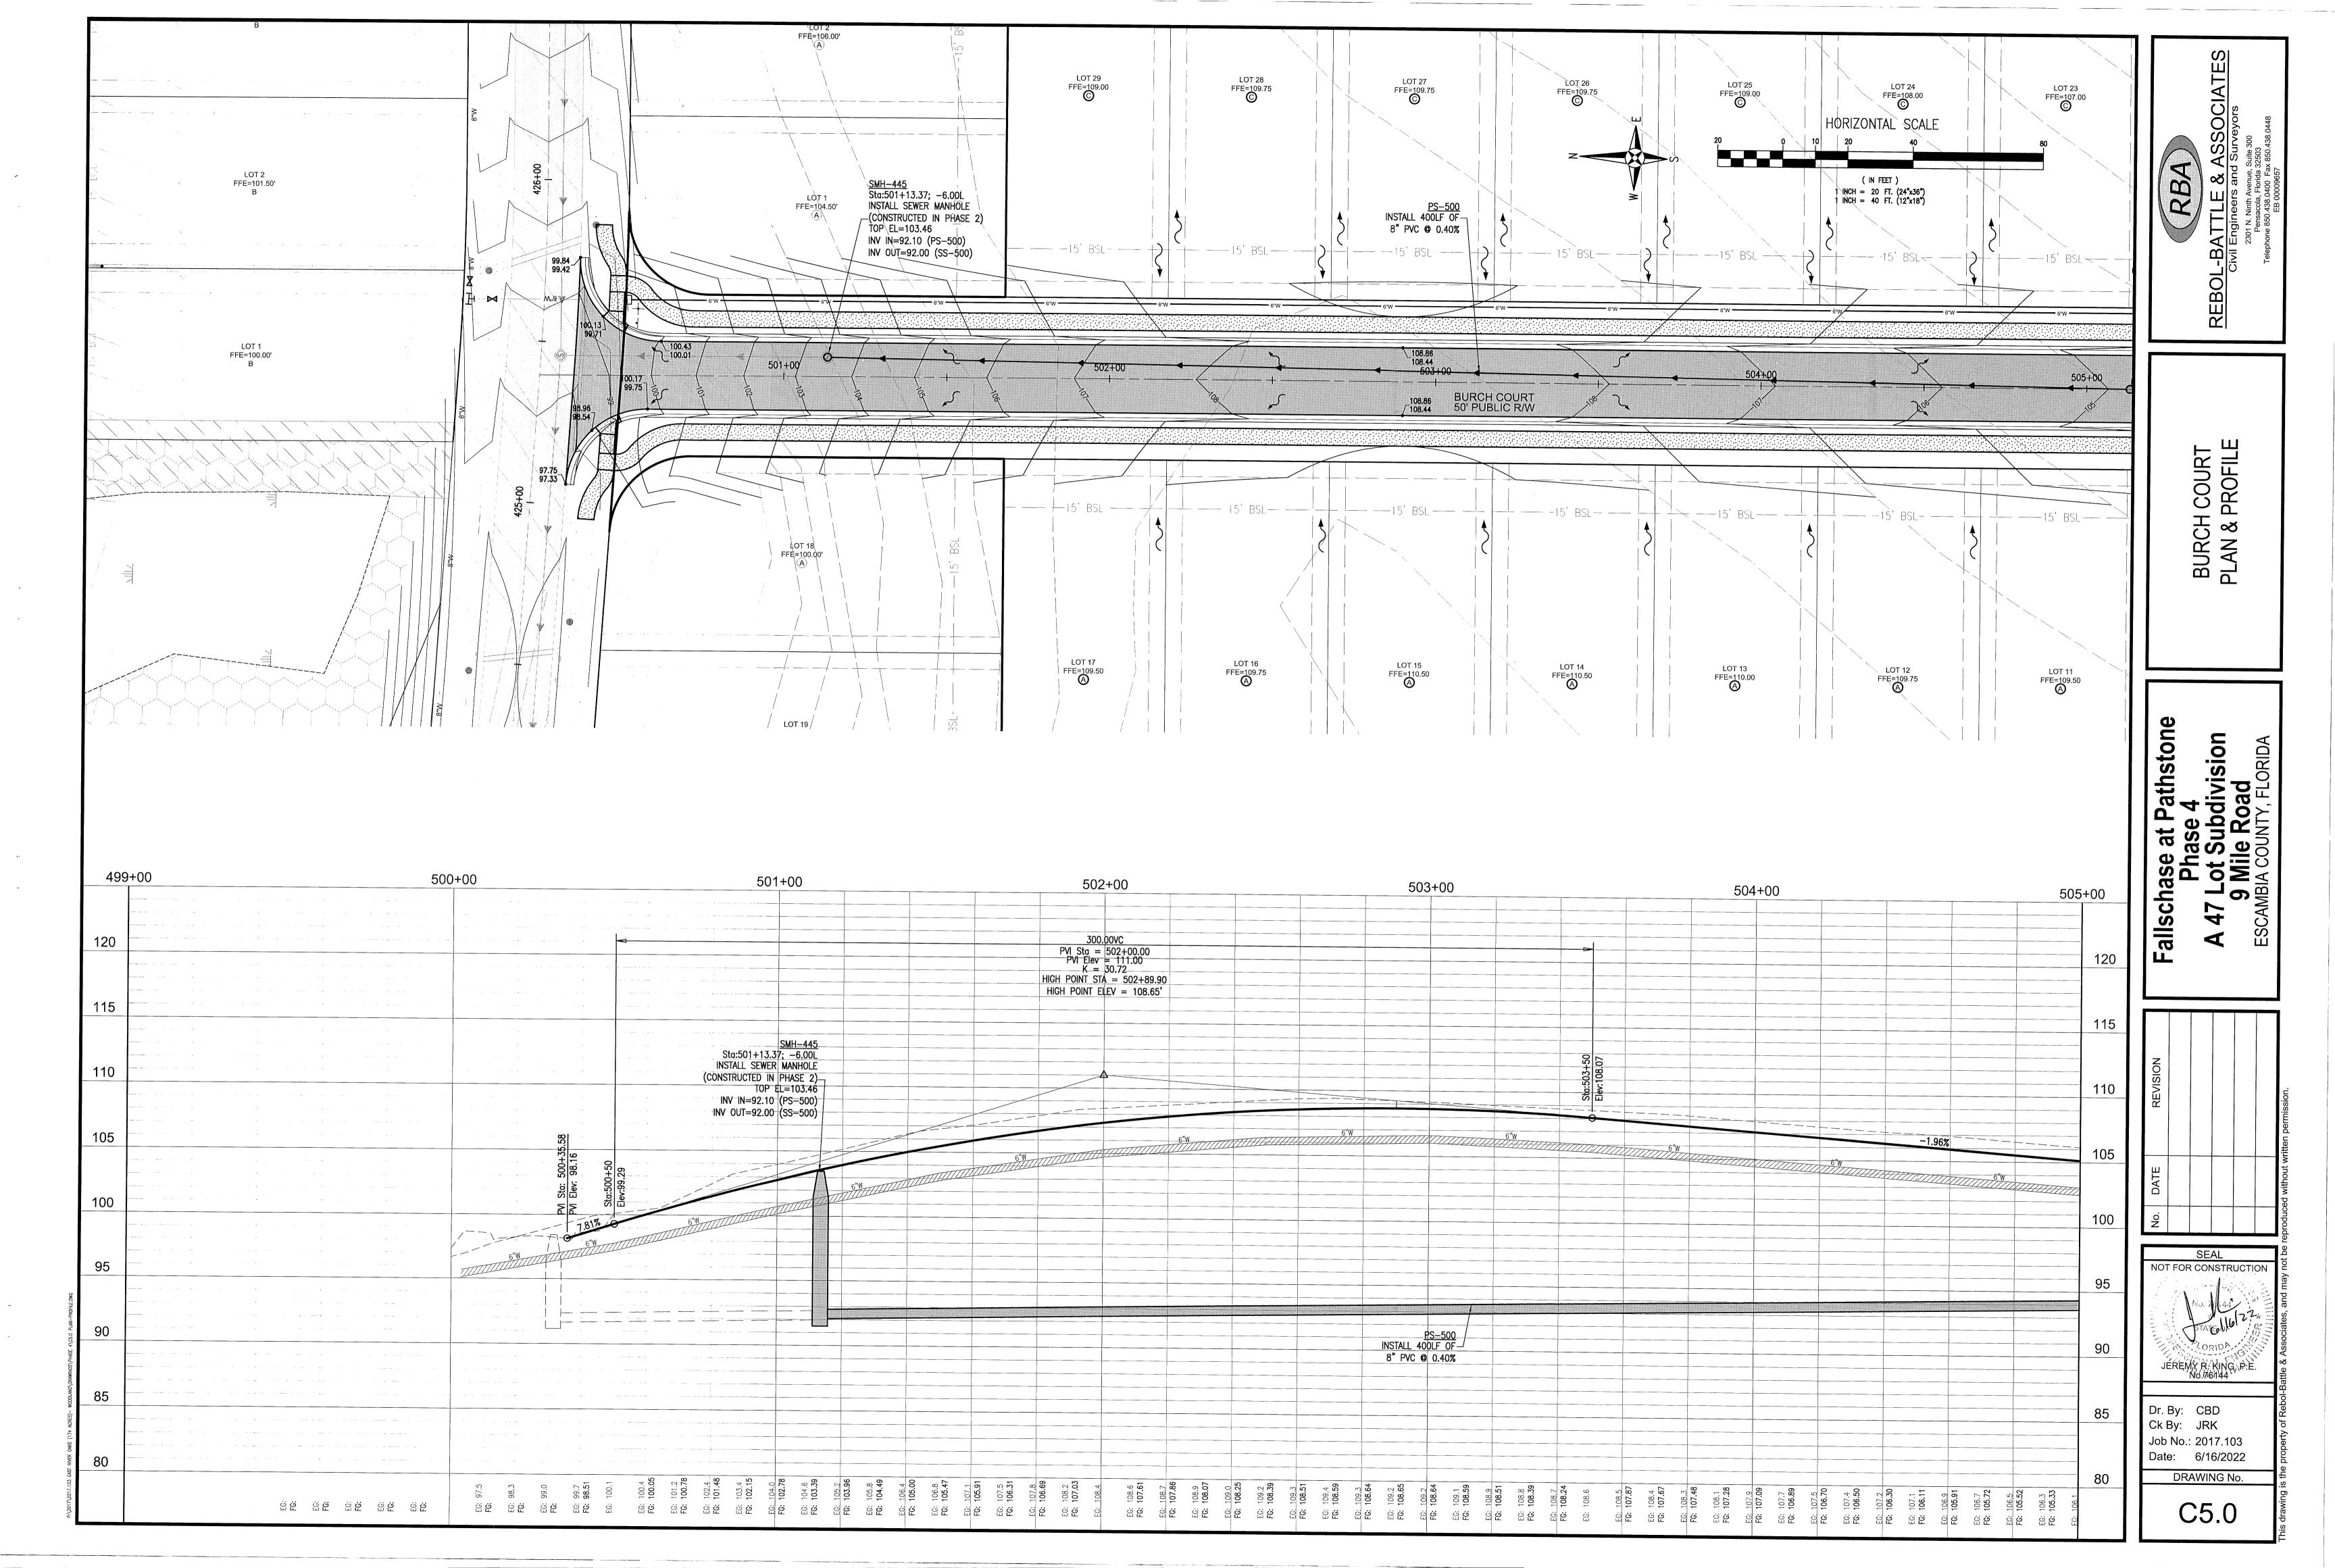


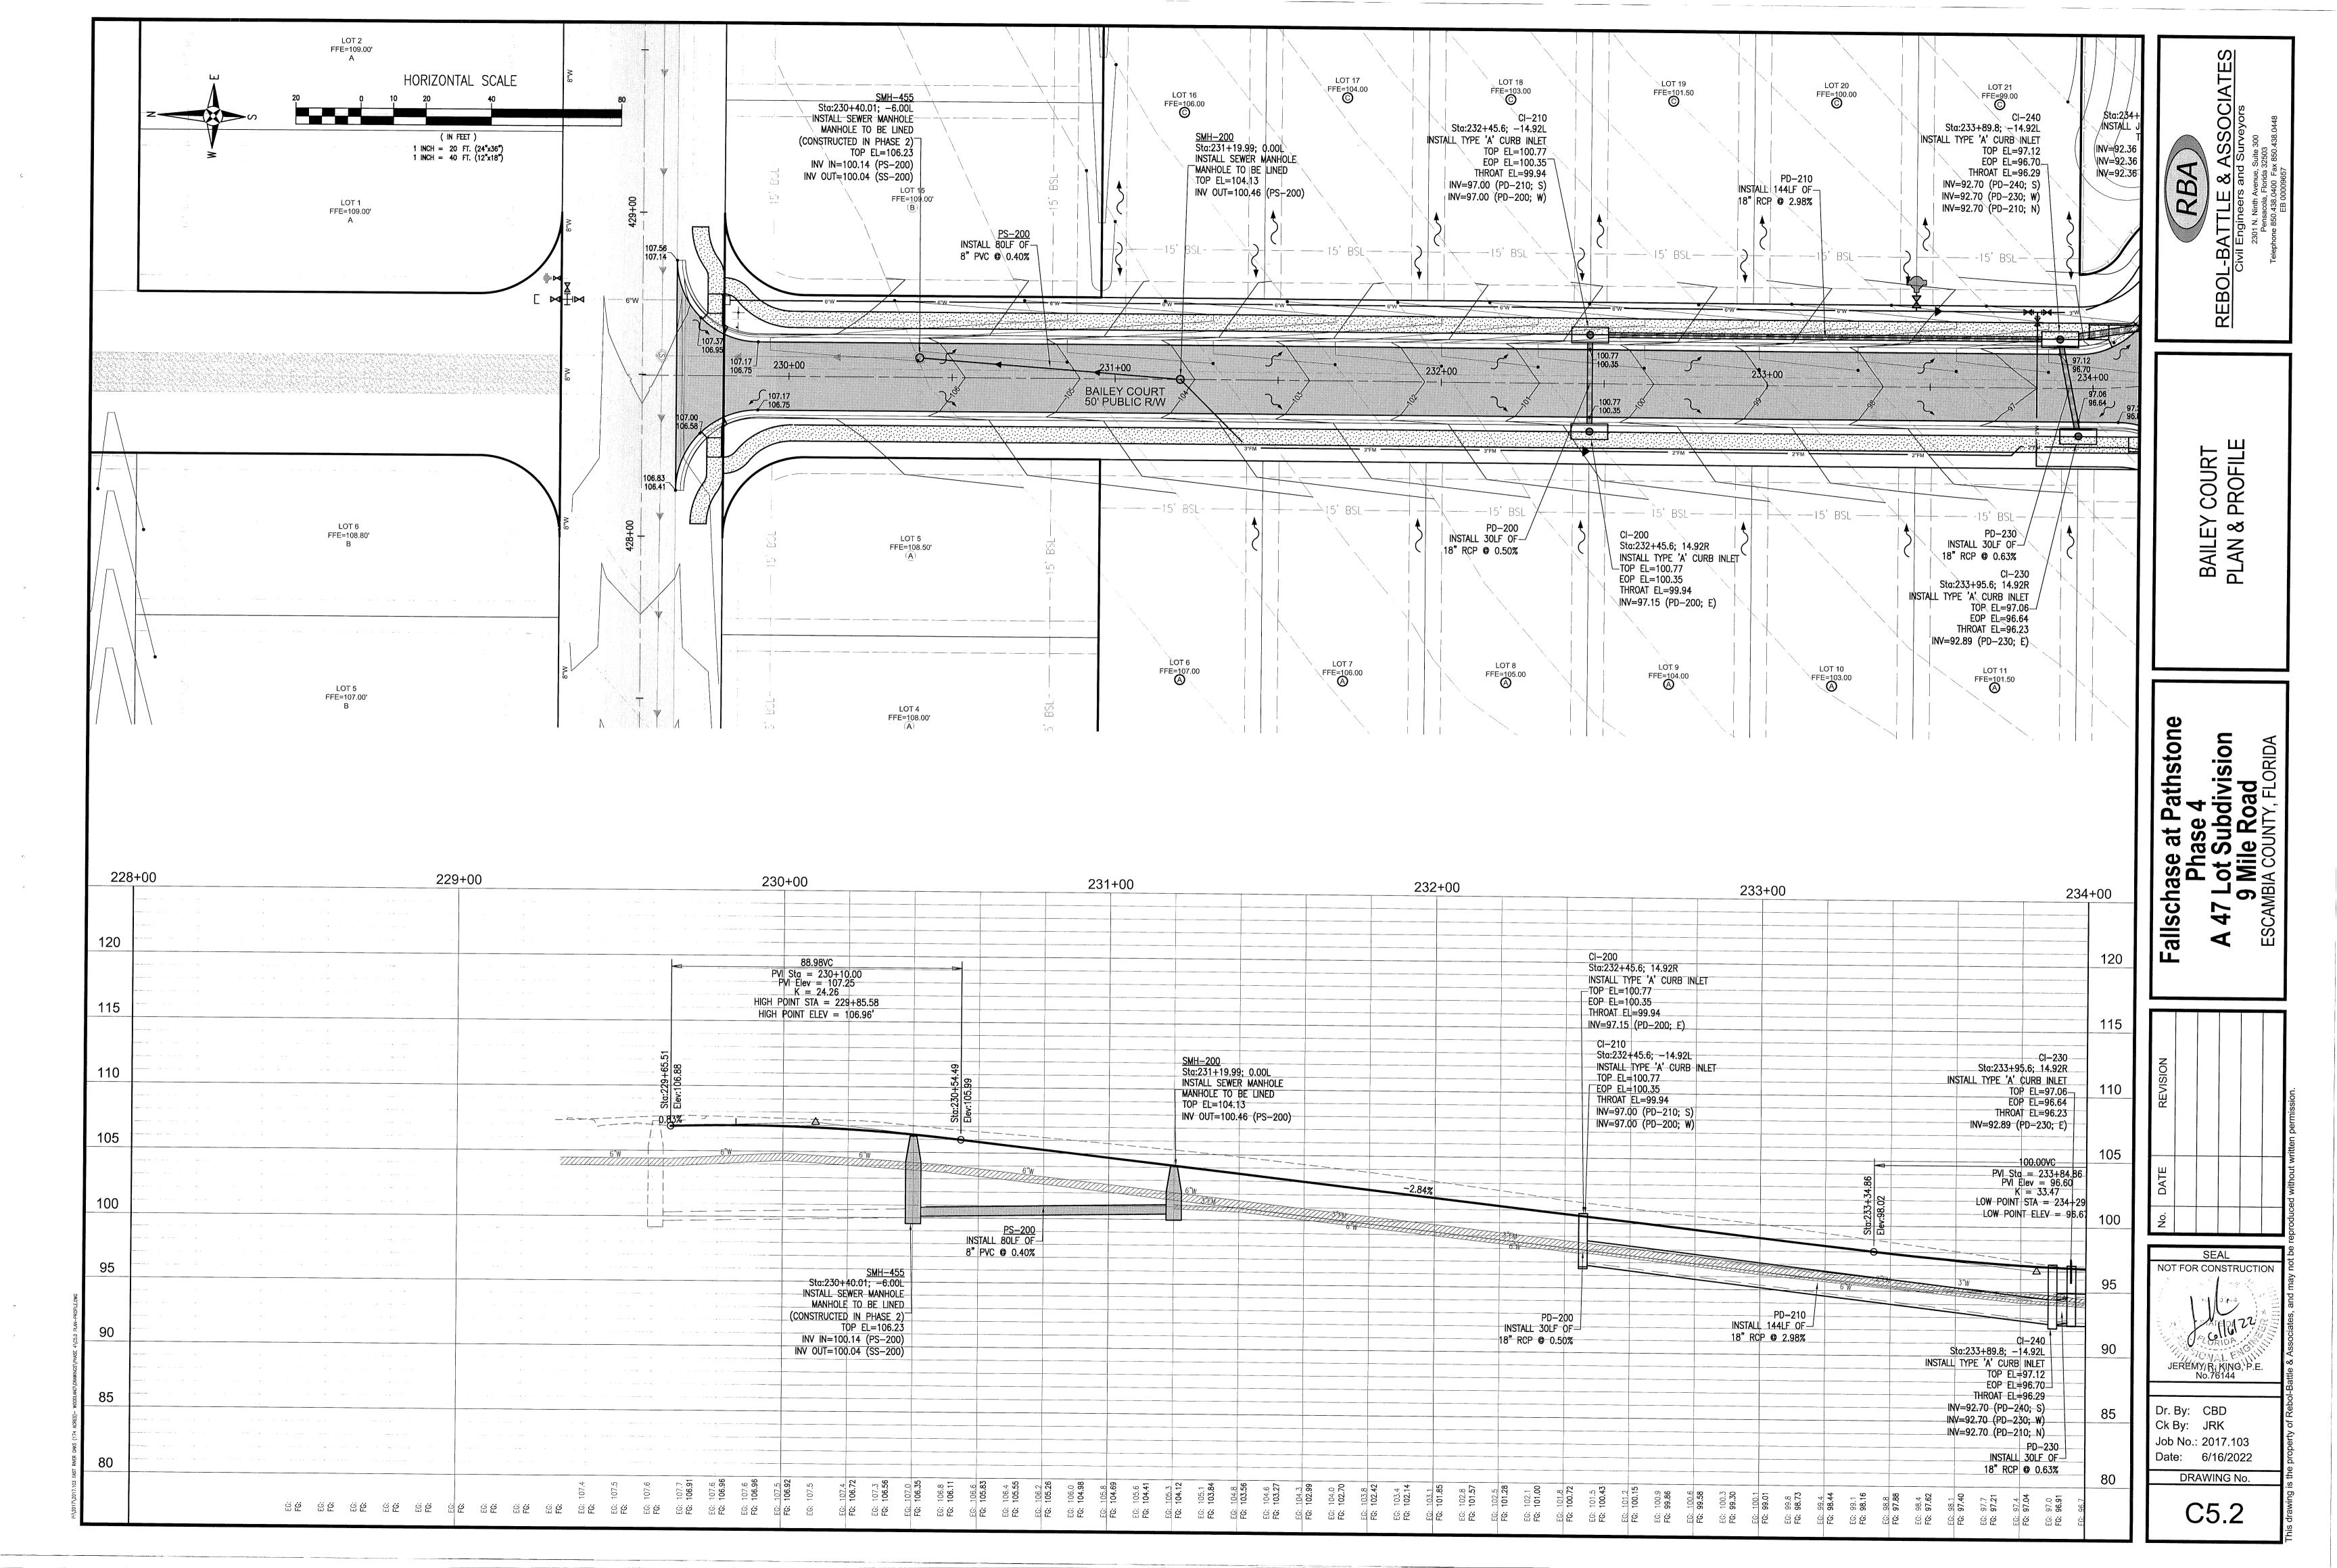

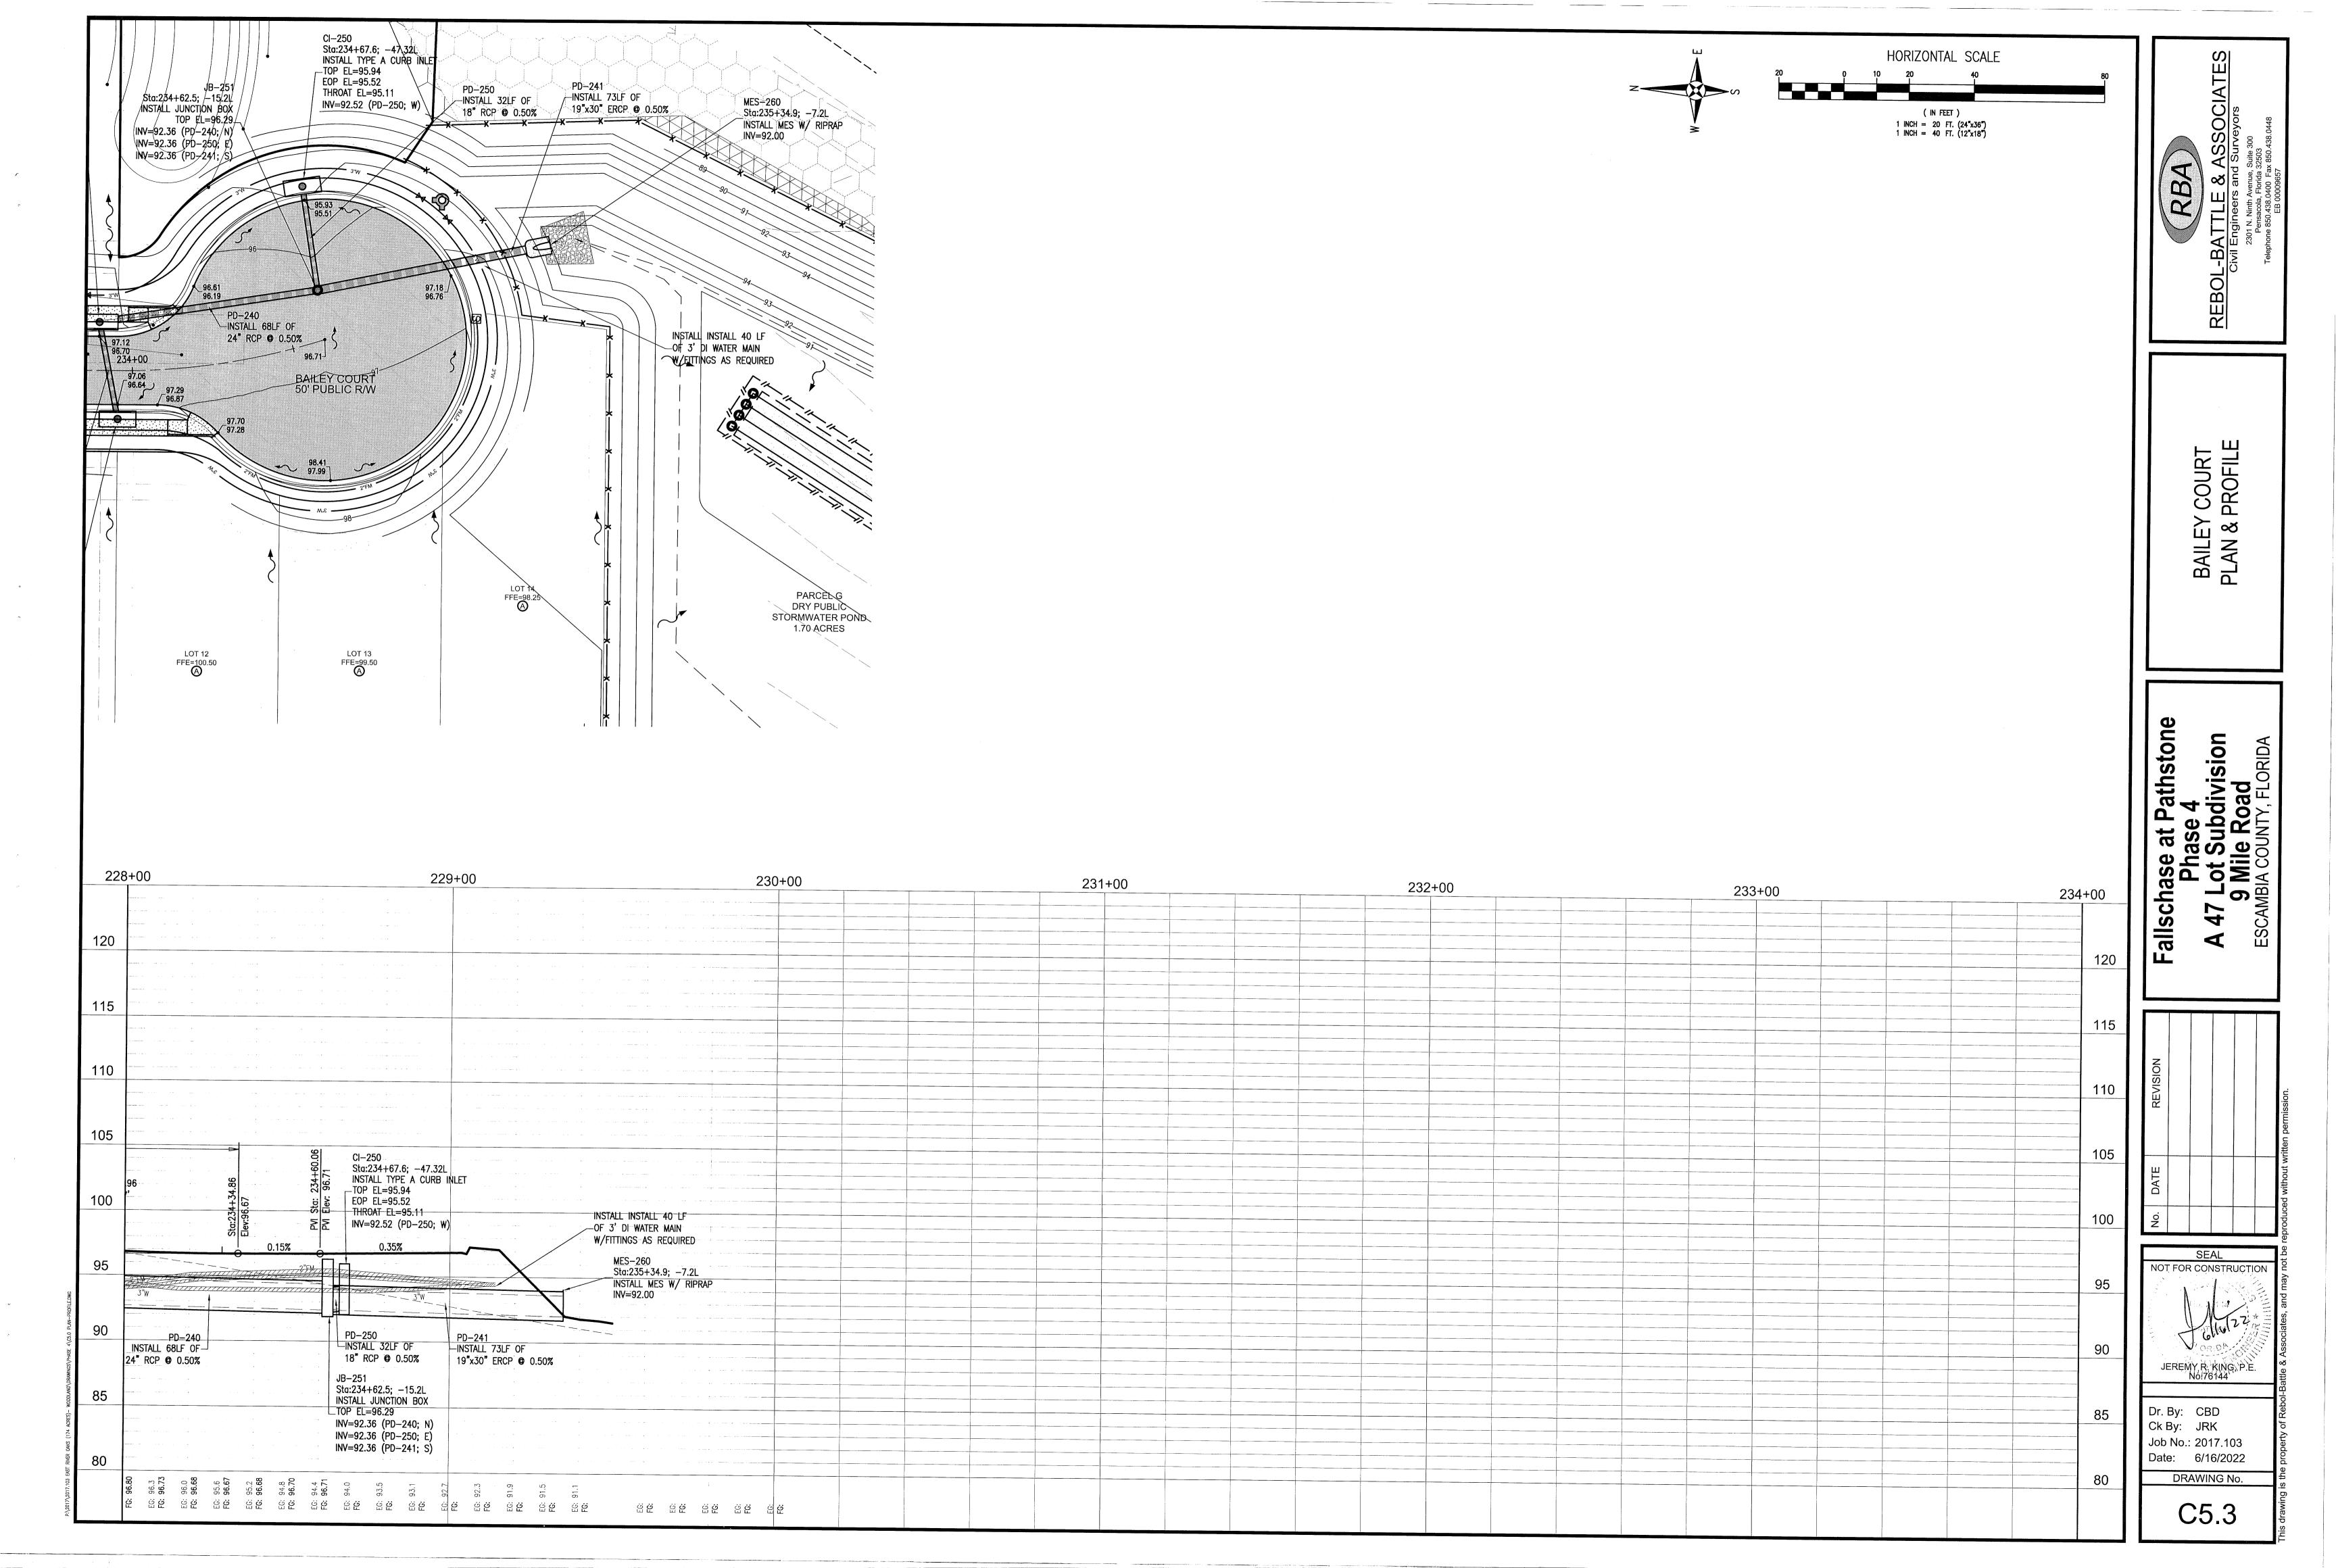

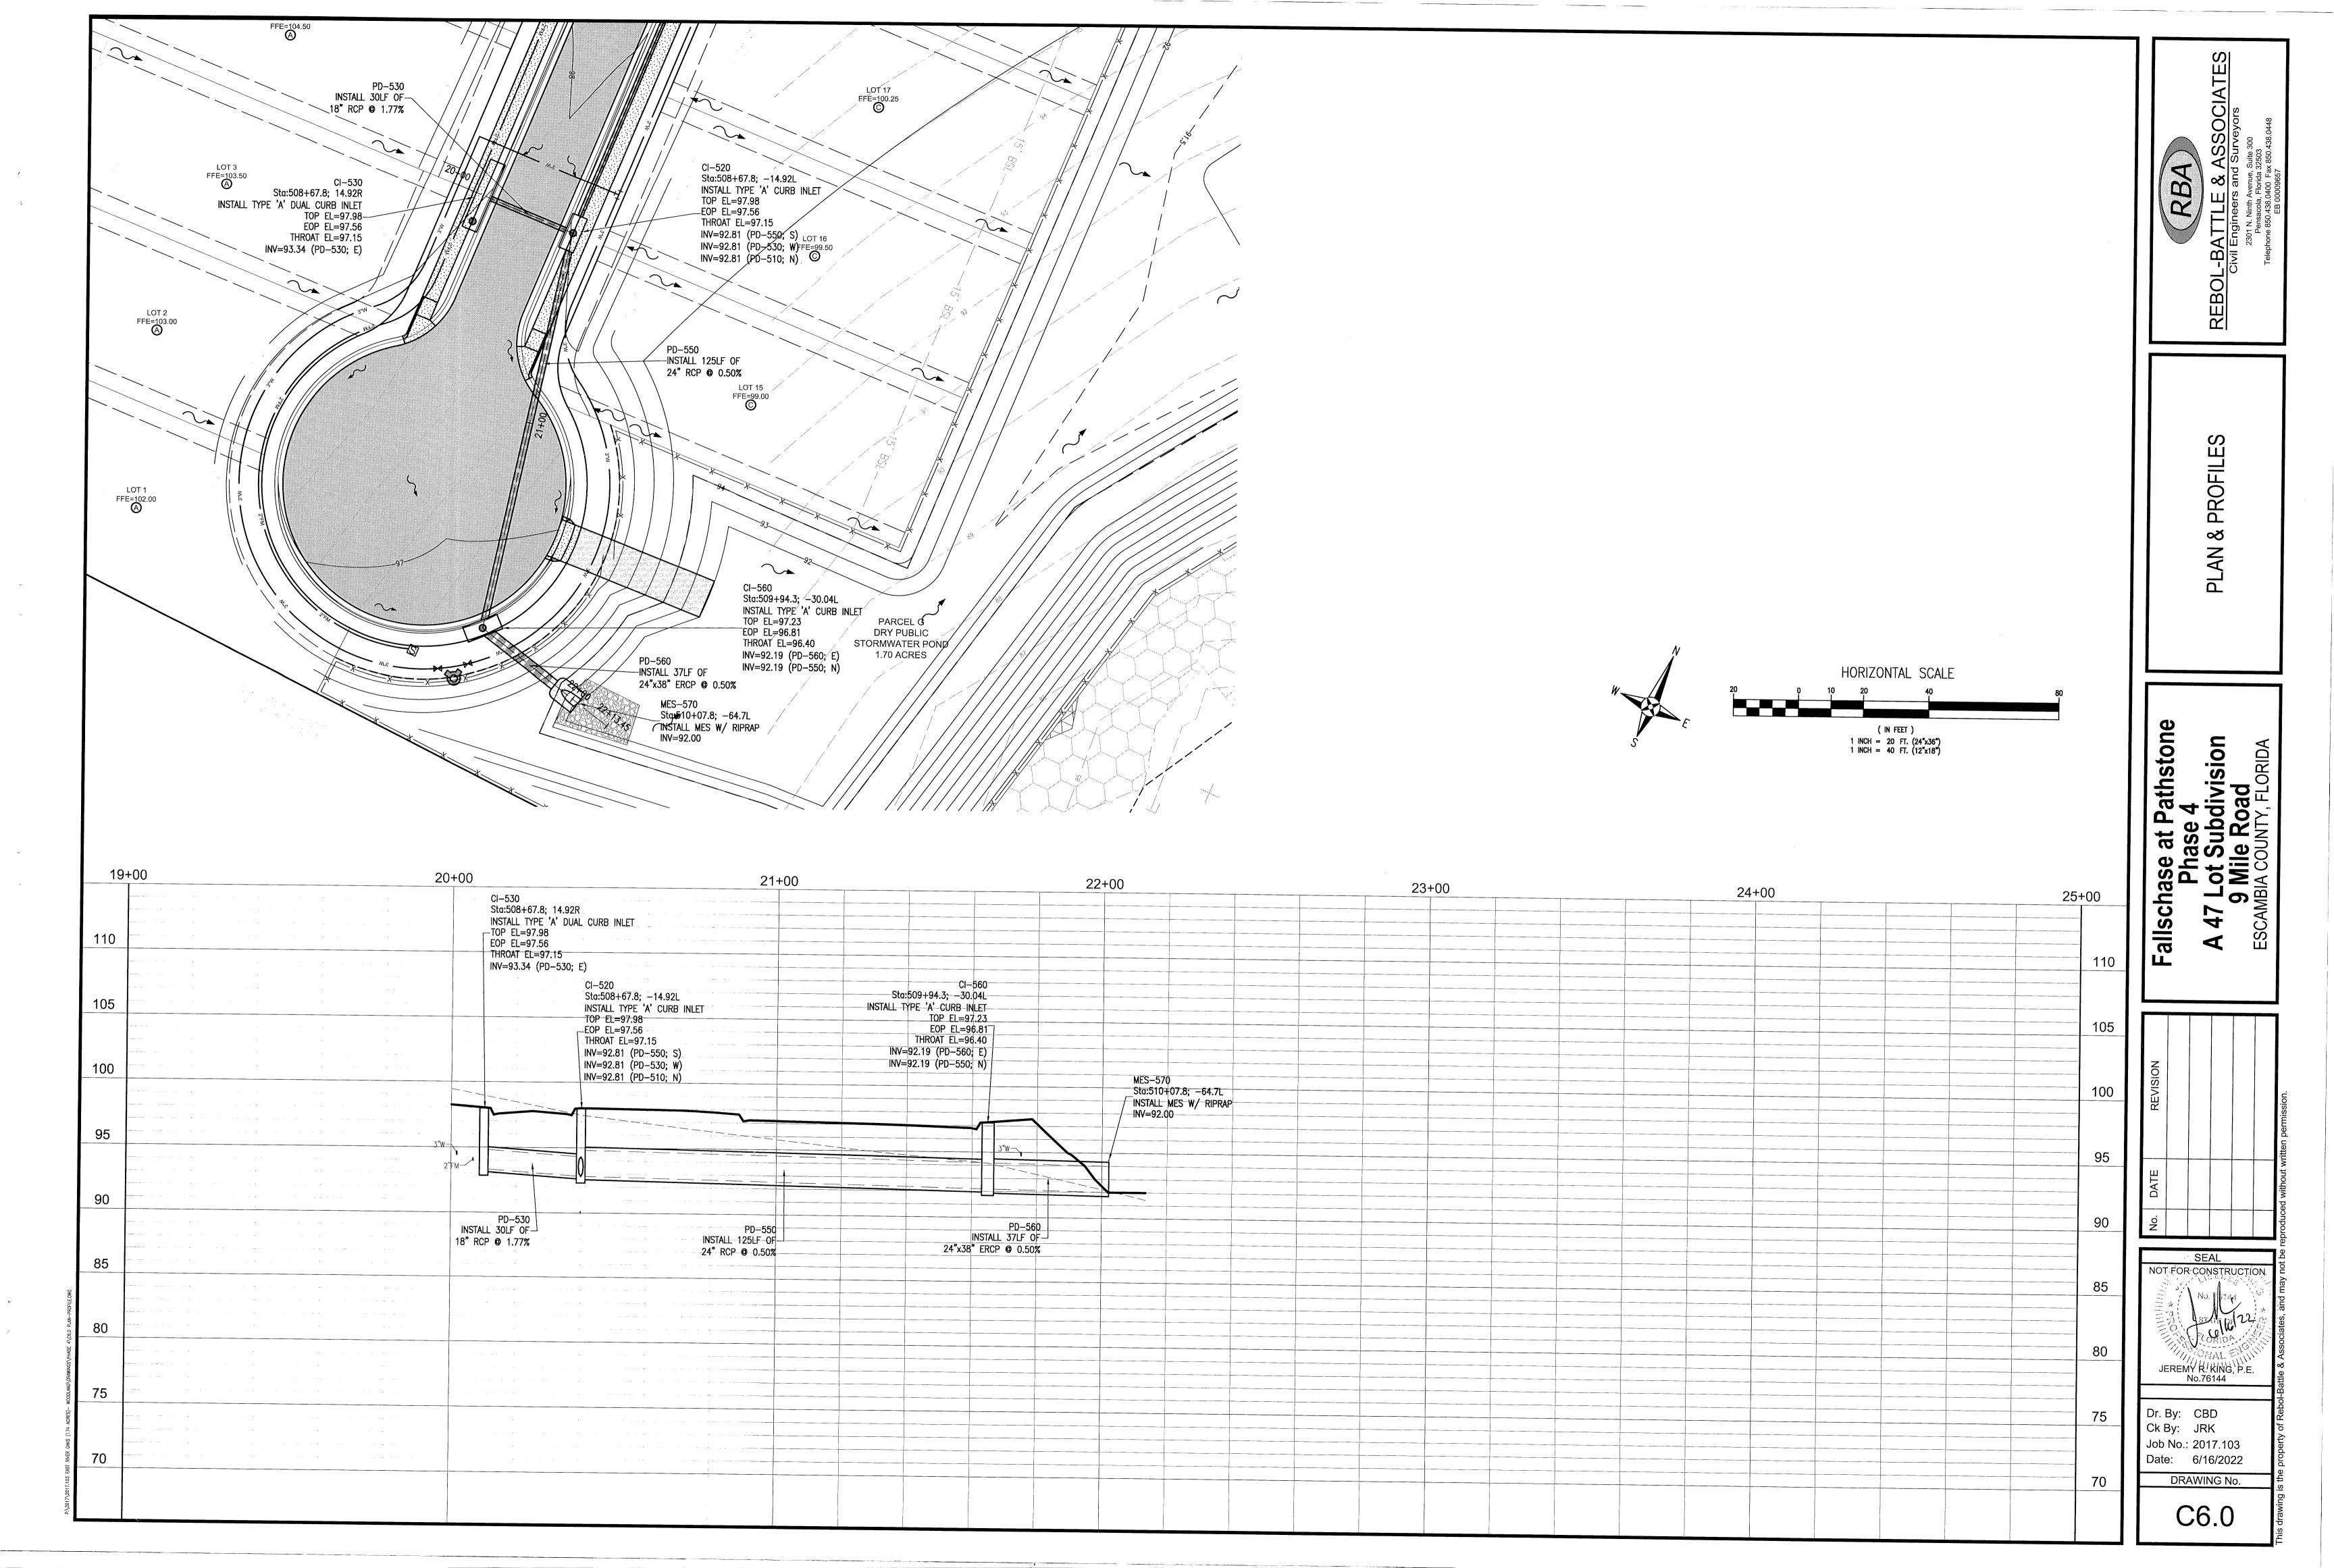

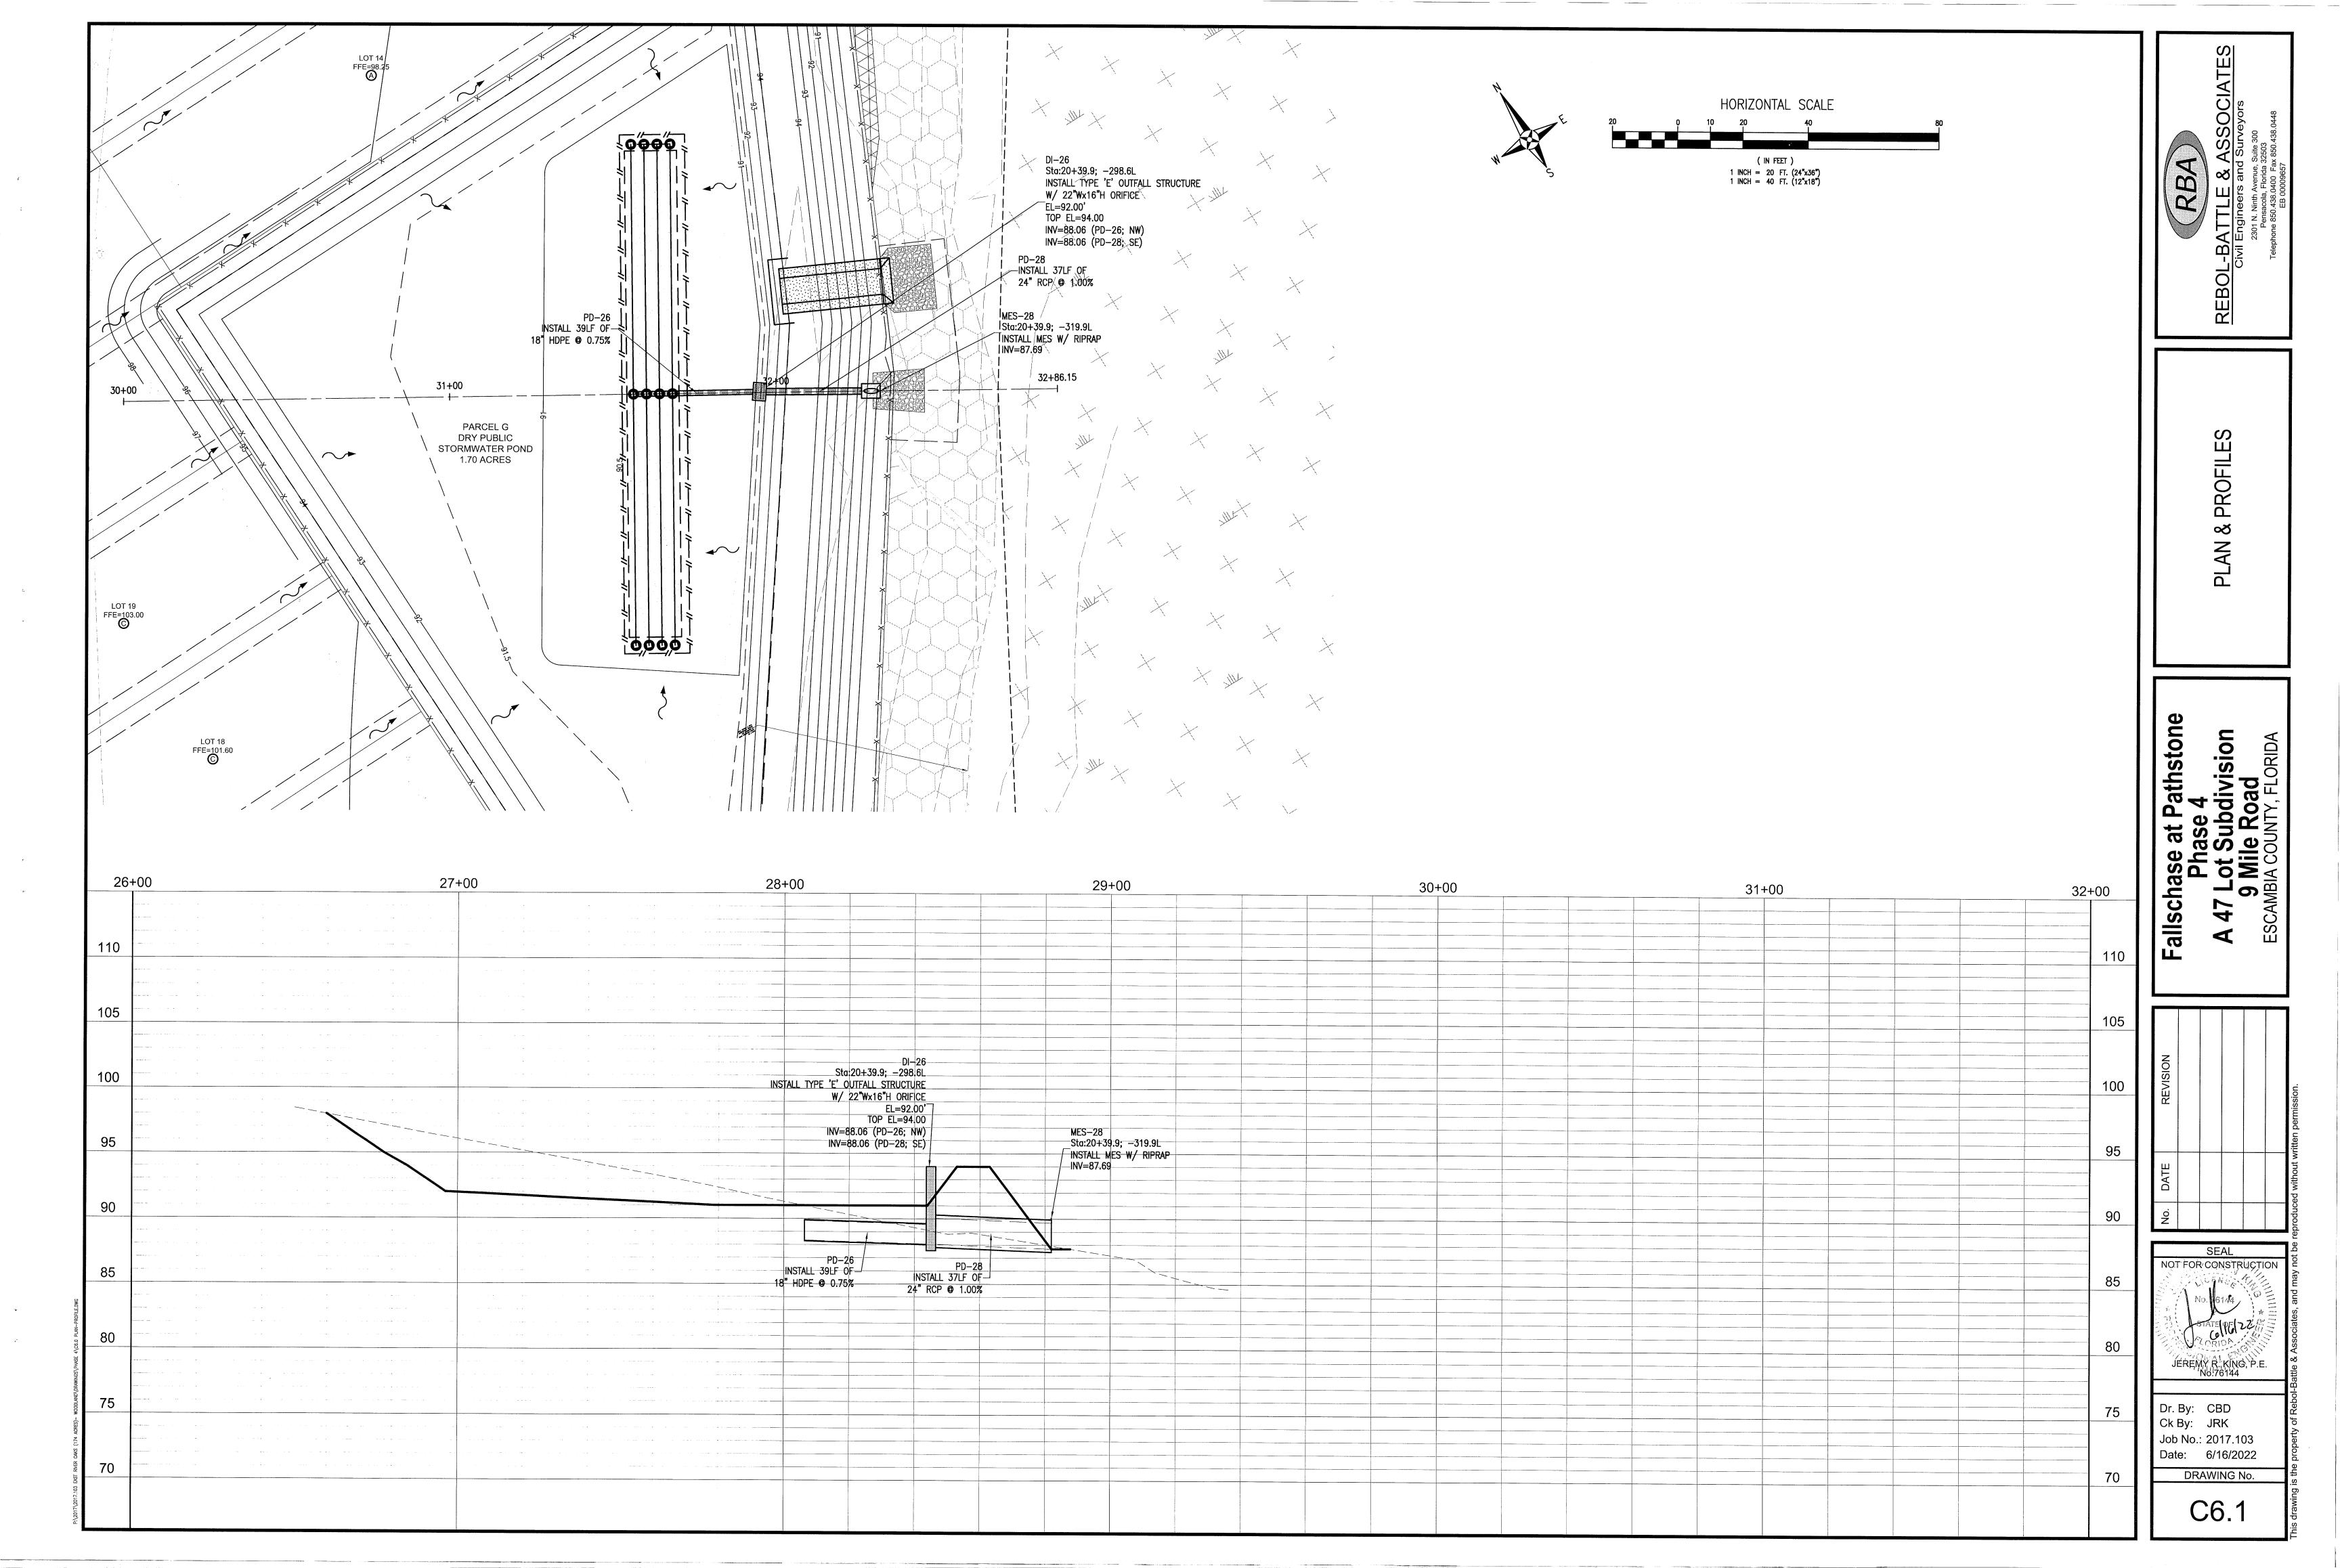


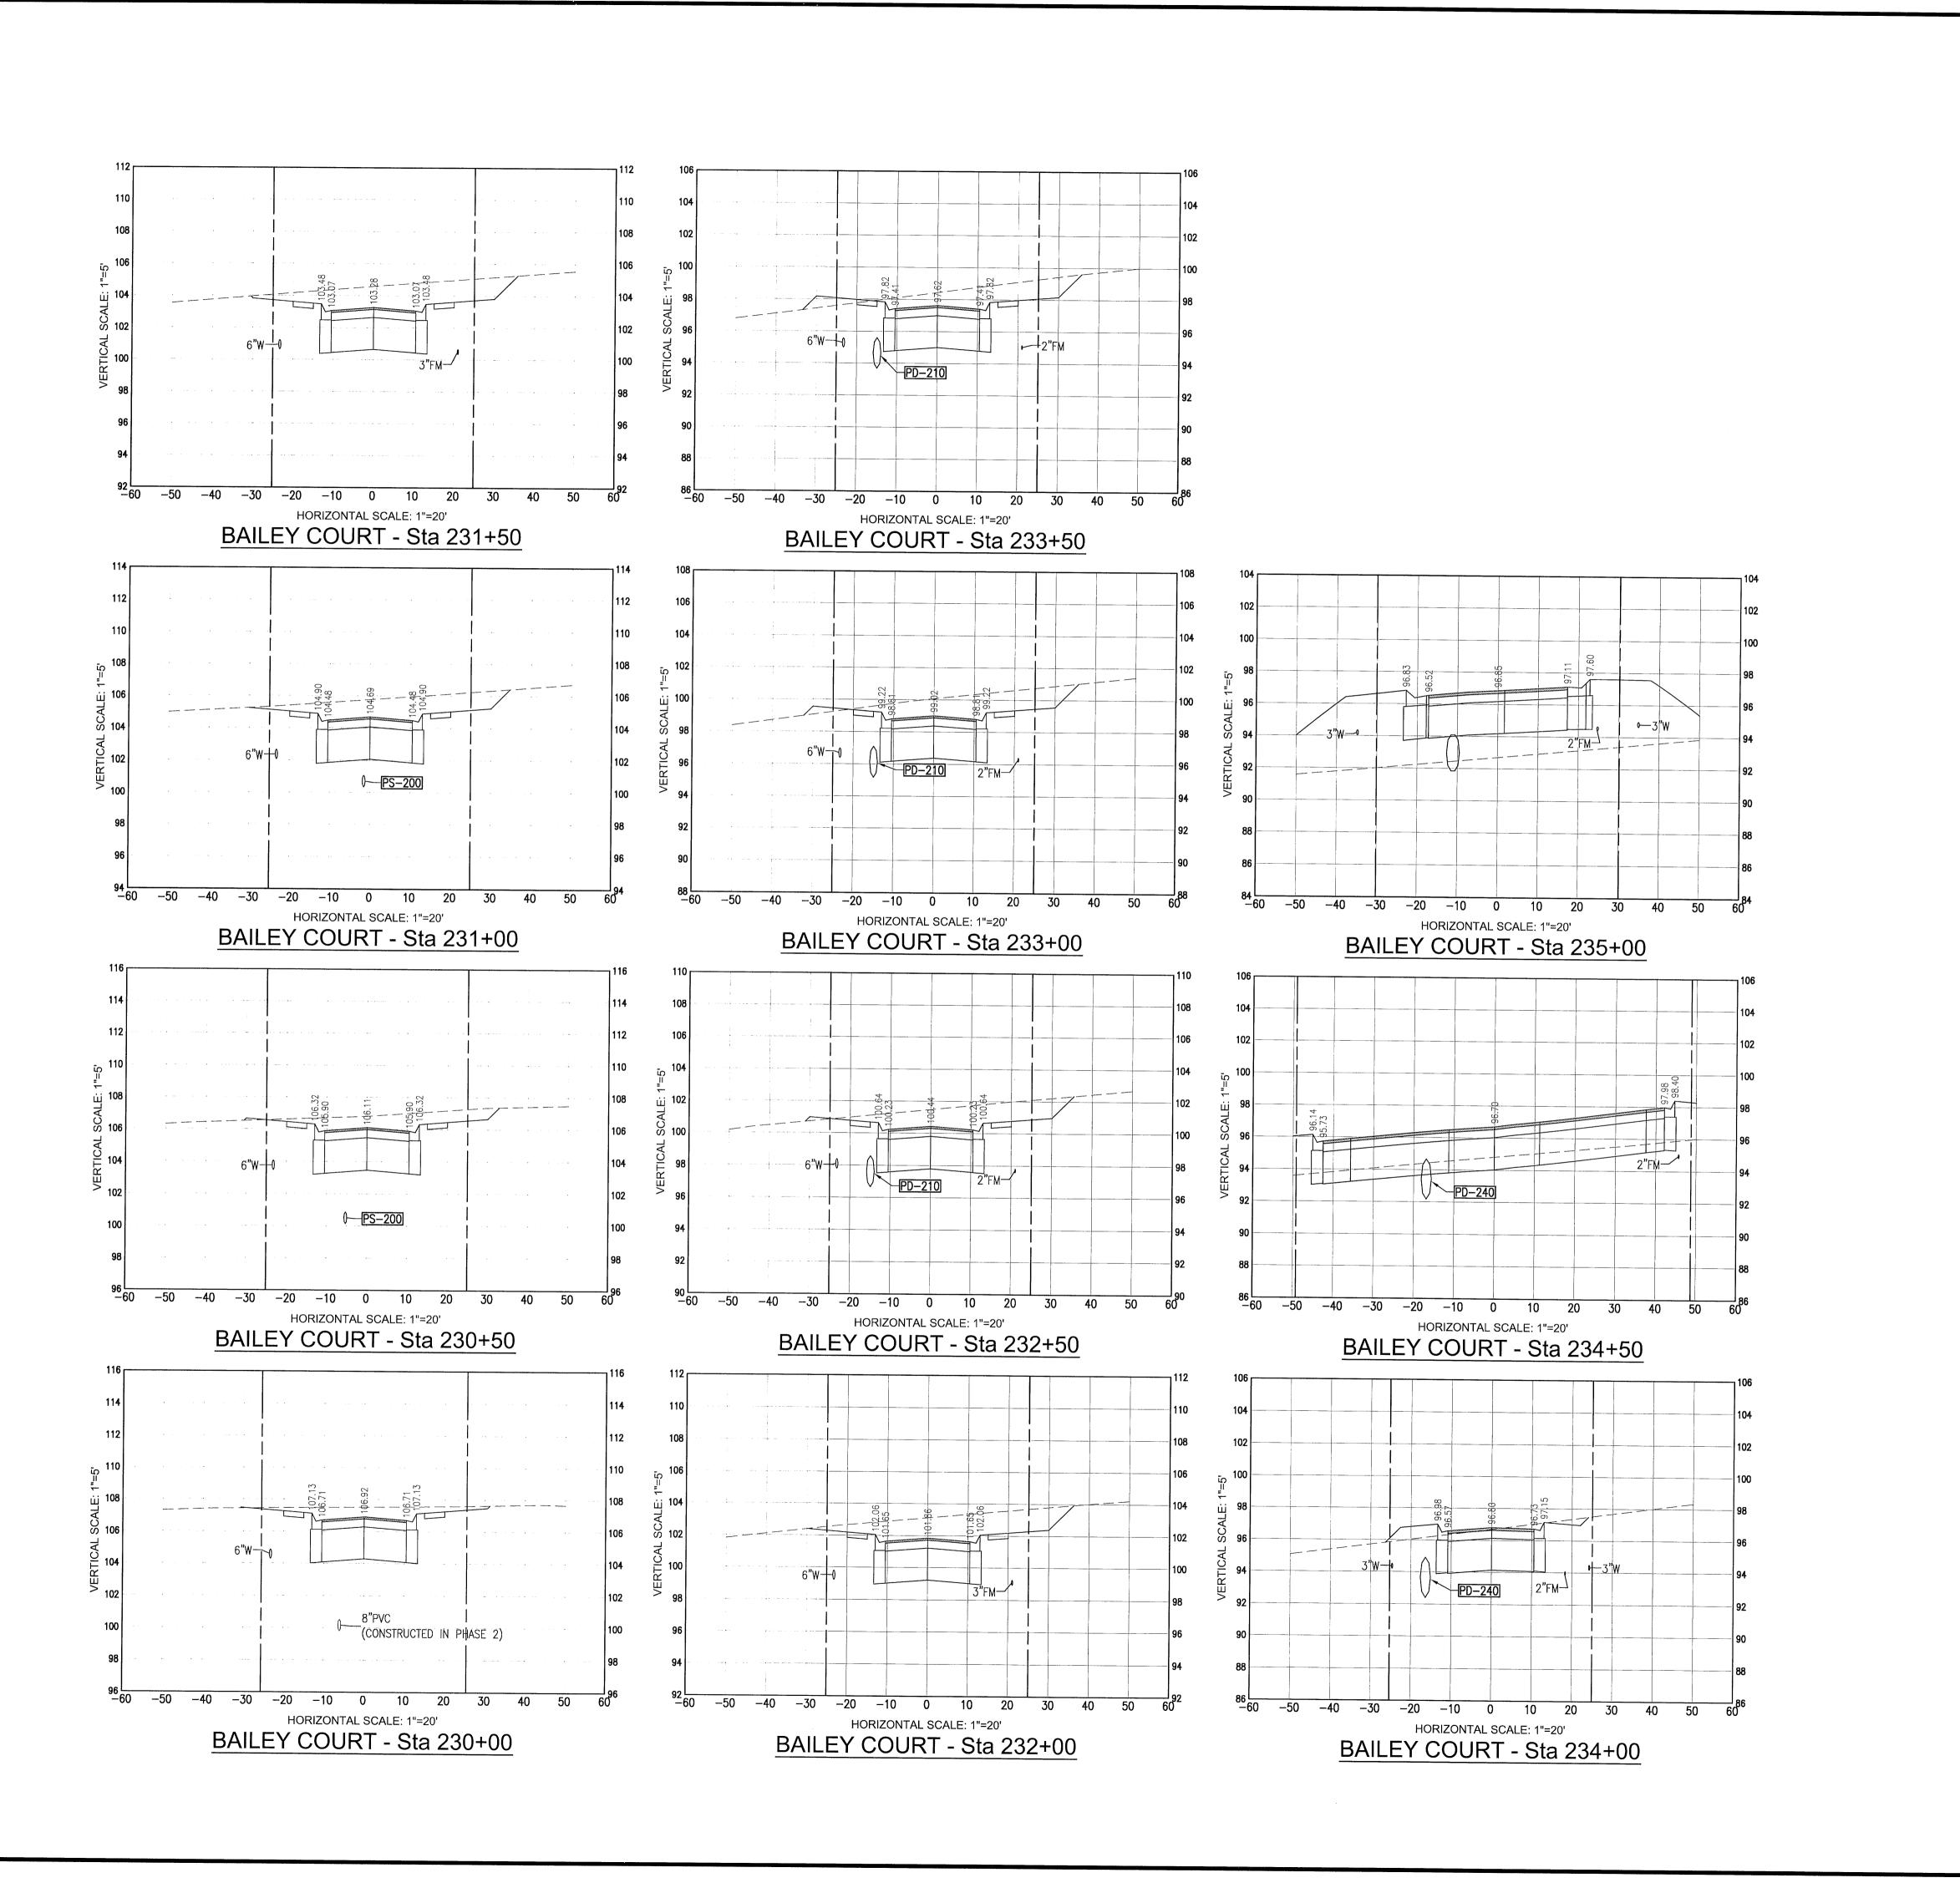


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BAILEY COURT CROSS SECTIONS

Fallschase at Pathstone
Phase 4
A 47 Lot Subdivision
9 Mile Road
ESCAMBIA COUNTY, FLORIDA




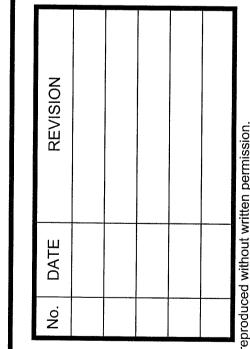
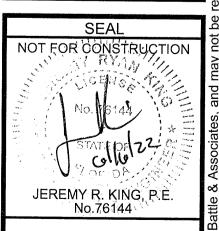
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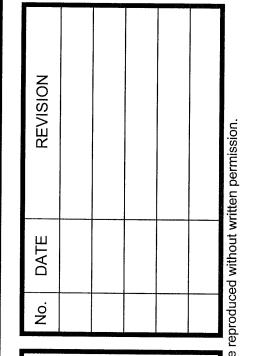
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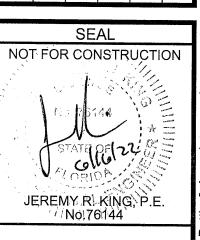


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BURCH COURT CROSS SECTIONS


Fallschase at Pathstone
Phase 4
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9 Mile Road
ESCAMBIA COUNTY, FLORIDA

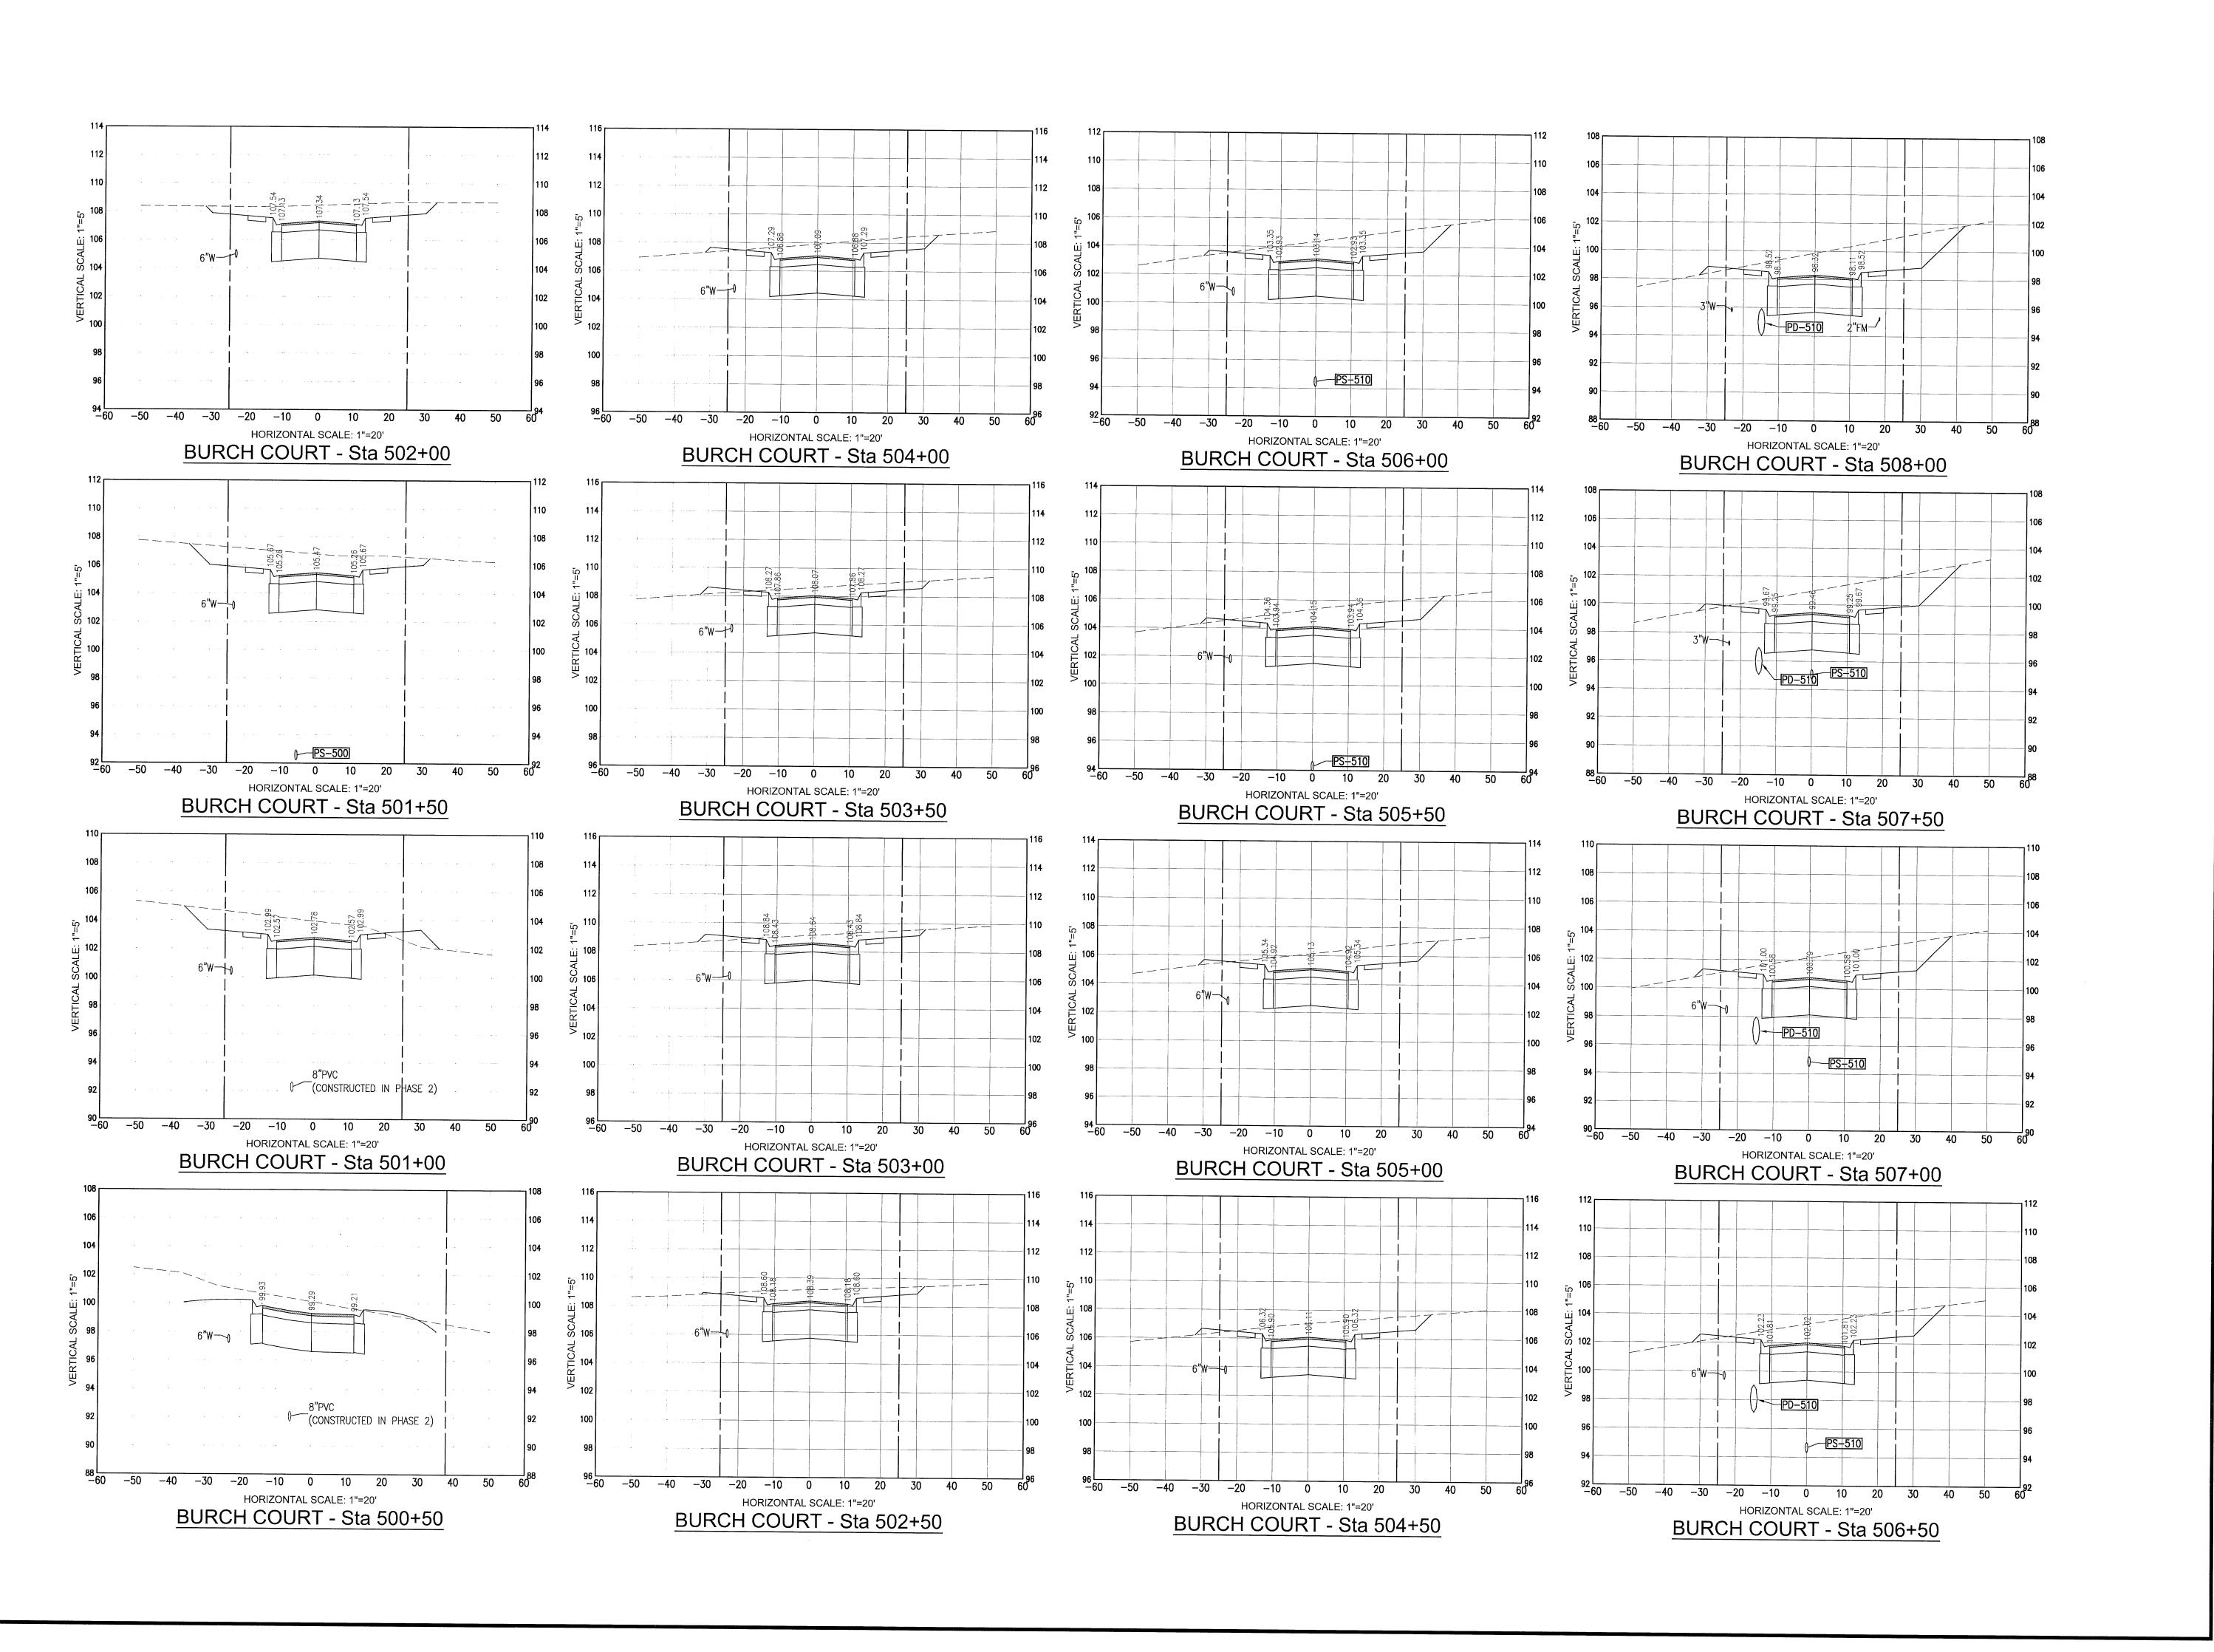



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Job No.: 2017.103
Date: 6/16/2022
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BURCH COURT CROSS SECTIONS

Fallschase at I Phase A 47 Lot Suk 9 Mile R ESCAMBIA COUNT
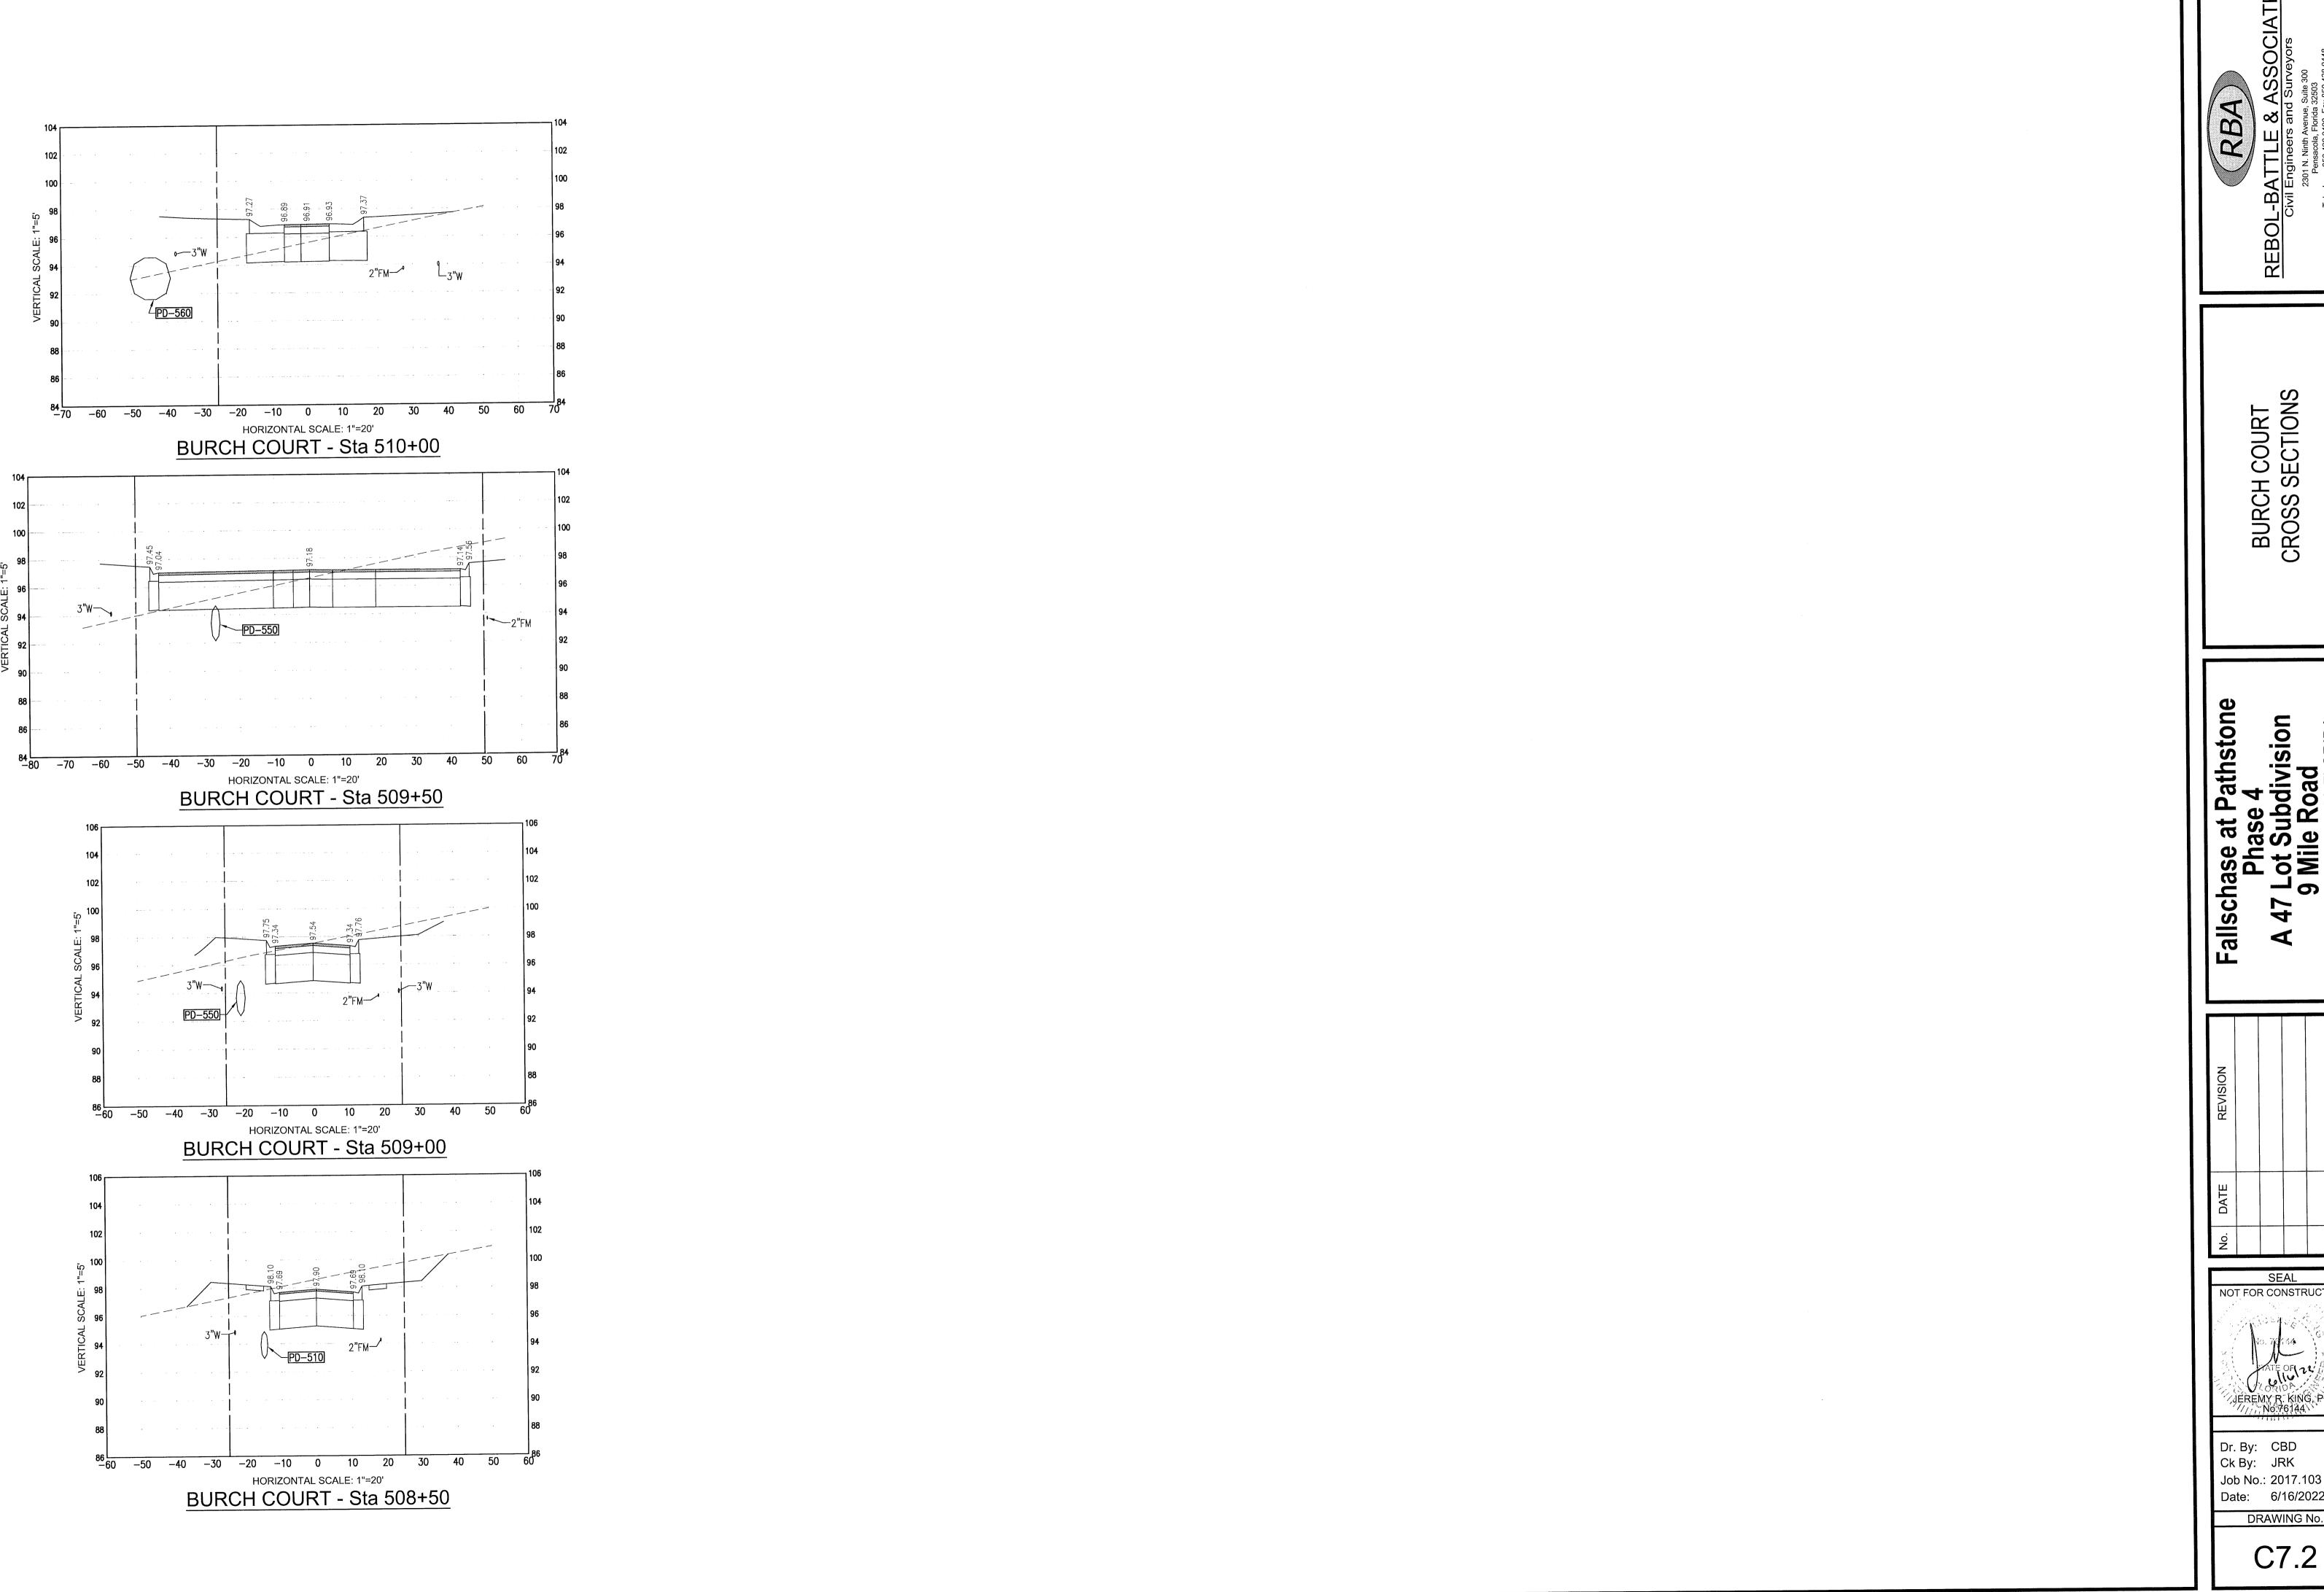
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