DRAINAGE FEE

Imperv. Surf. 70,382 Sq ft
Stormwater Ret. 0.78 % (F)
Total Drainage Fee \$2,744.90
Pond Maint. Fee: PRIVATE



requirements of applicable Escambia County
Regulations and Ordinances and does not in any way
relieve the submitting Architect, Engineer, Surveyor, or
other signatory from responsibility of details as drawn.


RBA PROJECT NO.: 2018.158

	SITE INFORMATION
OWNER:	LEDGESTONE DEVELOPERS LLC 8608 EIGHT MILE CREEK RD PENSACOLA, FL 32526 850.000.0000
DEVELOPER:	LEDGESTONE DEVELOPERS LLC 8608 EIGHT MILE CREEK RD PENSACOLA, FL 32526 850.000.0000
PROPERTY REFERENCE NO:	06-1S-31-1 4 01-002-002
PROPERTY ADDRESS:	8600 BLK BEULAH ROAD
PROPERTY AREA:	14.37 ACRES
PROJECT AREA:	14.37 ACRES
PROPERTY ZONING:	LDR
FUTURE LAND USE:	MU-S
PROPOSED ACTIVITY:	SINGLE FAMILY DETACHED SUBDIVISION
REQUIRED BUILDING SETBACKS LDR:	FRONT YARD — 25 FT. SIDE YARD — 5 FT. OR 10% REAR YARD — 25 FT.

FEMA FLOOD INSURANCE RATE MAP INFORMATION						
THE PARCEL SHOWN FOR DEVELOPMENT IS LOCATED WITHIN THE FOLLOWING FLOOD ZONE(S) AS DETAILED BY FEMA FIRM (FLOOD INSURANCE RATE MAP) INFORMATION DESCRIBED BELOW:						
FLOOD ZONE(S) COMMUNITY No. MAP No. PANEL No. SUFFIX MAP REVISION DATE						
X	120080	12033C	0270	G	SEPT 29, 2006	

CONTACTS			
REBOL-BATTLE & ASSOCIATES CIVIL ENGINEERS AND SURVEYORS 2301 N. NINTH AVENUE SUITE 300 PENSACOLA, FLORIDA 32503	CONTACT: PAUL A. BATTLE, P.E. CONTACT: MARK. A. NORRIS, P.S.M. PHONE: 850.438.0400 FAX: 850.438.0448		
GULF POWER 500 BAYFRONT PARKWAY PENSACOLA, FLORIDA 32520	CONTACT: DON SCHOFIELD PHONE: 850.444.6555 FAX: 850.444.6432		
COX CABLE 2205 LaVISTA AVE. PENSACOLA, FLORIDA 32504	CONTACT: RICHARD EMMONS PHONE: 850.477.2695 FAX: 850.479.3912		
ECUA P.O. BOX 15311 PENSACOLA, FLORIDA 32514	CONTACT: PERRY WHITE PHONE: 850.969.3312		
ENERGY SERVICES GAS 1625 ATWOOD DRIVE PENSACOLA, FLORIDA 32504	CONTACT: JOHN DeMARS PHONE: 850.474.5322 FAX: 850.474.5330		
AT&T, INC. 605 W. GARDEN STREET PENSACOLA, FLORIDA 32501	CONTACT: JONATHAN BLANKINCHIP PHONE: 850.436.1489		
ESCAMBIA COUNTY ENGINEER 1190 W. LEONARD STREET PENSACOLA, FLORIDA 32501	CONTACT: JOY BLACKMON PHONE: 850.595.3434		
FARM HILL UTILITY, INC 120 MADRID RD CANTONMENT, FL 32533	CONTACT: SHAUN CONDON PHONE: 850.968.2573		
GULF SOUTH PIPELINE 480 VAN PELT LANE PENSACOLA, FL 32505	CONTACT: CHUCK CHAPMAN PHONE: 850.324.6337		
MCI	PHONE: 800.624.9675		
SUNSHINE UTILITIES	PHONE: 800.432.4770		

SITE CONSTRUCTION PLANS FOR LEDGESTONE SUBDIVISION A 36 LOT SUBDIVISION 8600 BLK BEULAH ROAD ESCAMBIA COUNTY April 21, 2021

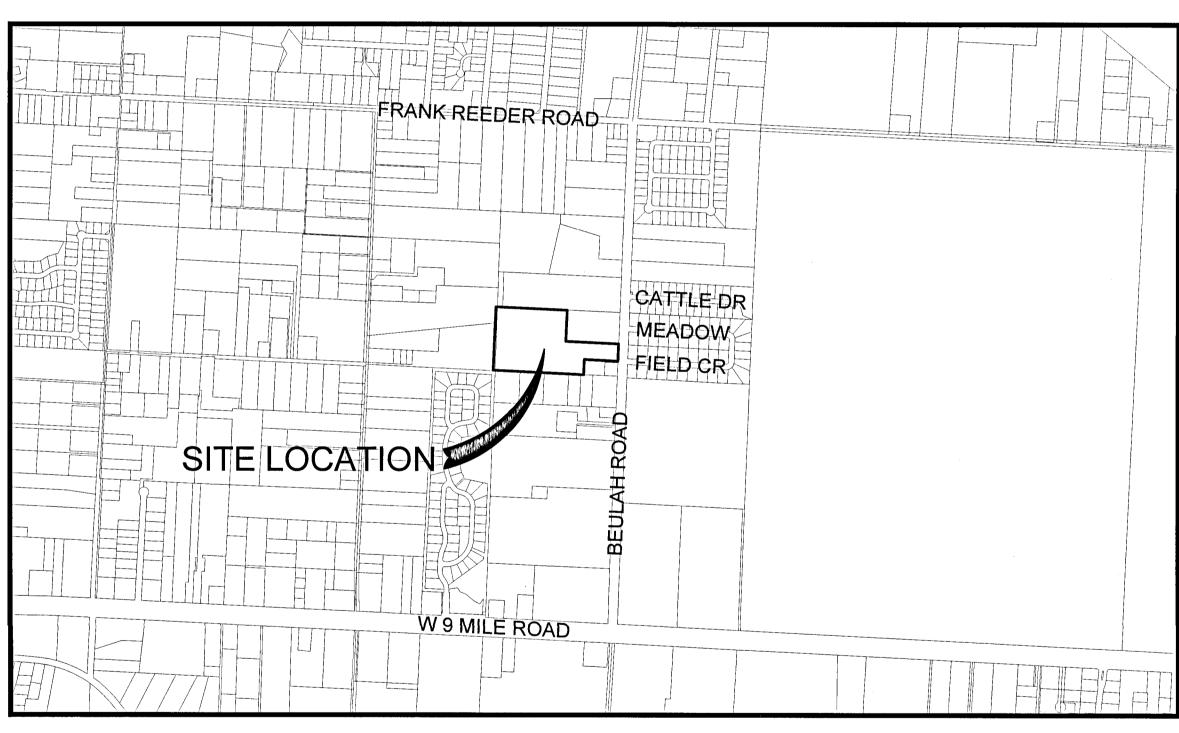

VICINITY MAP
SCALE: 1"=1000"



REBOL-BATTLE & ASSOCIATES

Civil Engineers and Surveyors

2301 N. Ninth Avenue, Suite 300 Pensacola, Florida 32503 Telephone 850.438.0400 Fax 850.438.0448 EB 00009657 LB7916

INDEX OF DRAWINGS

DOCUMENT NAME

*PROJECT MANUALS USED ONLY WITH ECUA CIP PROJECTS

ECUA ENGINEERING MANUAL REFERENCE NOTE**NOTES SHALL BE INSERTED IN THE UPPER RIGHT CORNER OF TITLE SHEET
*APPLICABLE ONLY TO ECUA INFRASTRUCTURE TO BE CONSTRUCTED IN PUBLIC ROW OR IN UTILITY

IF YES, CONTRACTOR SHALL CONSTRUCT PROJECT IN ACCORDANCE WITH SAID DOCUMENTS AS LISTED AND

C. ENGINEER OF RECORD RESPONSIBILITIES

PROJECT MANUAL

C1.0	EXISTING SITE, DEMOLITION & EROSION CONTROL PLAN
C1.1	EROSION CONTROL DETAILS
C1.2	NPDES-STORMWATER POLLUTION PREVENTION PLAN
C2.0	SITE LAYOUT AND DIMENSION PLAN
C2.1	SITE DETAILS
C3.0	GRADING AND DRAINAGE PLAN
C3.1-C3.3	GRADING AND DRAINAGE DETAILS
C3.4	NEIGHBORHOOD LOT GRADING PLAN
C3.5	NEIGHBORHOOD LOT GRADING DETAILS
C4.0	UTILITY PLAN
C4.1	FDOT UTILITY PLAN AND DETAILS
C5.0-C5.9	PLAN & PROFILES
C6.0-C6.3	ROAD CROSS SECTION
C7.0	FDOT 600 SURVEY
C7.1-C7.3	FDOT 660 SURVEY DETAILS

DESCRIPTION: (AS PREPARED BY REBOL-BATTLE & ASSOCIATES)


THAT PORTION OF THE NORTHEAST QUARTER OF SECTION 6, TOWNSHIP 1 SOUTH, RANGE 31 WEST, ESCAMBIA COUNTY, FLORIDA DESCRIBED AS FOLLOWS:

COMMENCING AT THE SOUTHEAST CORNER OF SAID NORTHEAST QUARTER OF SECTION 6; THENCE PROCEED NORTH 87°10′06″ WEST ALONG THE SOUTH LINE OF SAID NORTHEAST QUARTER OF SECTION 6 FOR A DISTANCE OF 401.50 FEET TO THE POINT OF BEGINNING; THENCE CONTINUE LAST COURSE PROCEED NORTH 87°10′06″ WEST ALONG SAID SOUTH LINE FOR A DISTANCE OF 940.62 FEET TO AN EXISTING CONCRETE MONUMENT BEING THE SOUTHWEST CORNER OF EAST HALF OF THE NORTHEAST QUARTER OF SAID SECTION 6; THENCE DEPARTING SAID SOUTH LINE, PROCEED NORTH 02°24′31″ EAST ALONG THE WEST LINE OF SAID EAST HALF OF THE NORTHEAST QUARTER FOR A DISTANCE OF 667.72 FEET TO AN EXISTING CONCRETE MONUMENT; THENCE DEPARTING SAID WEST LINE PROCEED SOUTH 87°12′54″ EAST FOR A DISTANCE OF 739.14 FEET; THENCE PROCEED SOUTH 02°16′22″ WEST FOR A DISTANCE OF 329.00 FEET TO THE WESTERLY RIGHT OF WAY LINE OF BEULAH ROAD (100′ RIGHT OF WAY); THENCE PROCEED SOUTH 02°16′22″ WEST ALONG SAID WESTERLY RIGHT OF WAY LINE FOR A DISTANCE OF 179.52 FEET; THENCE DEPARTING SAID WESTERLY RIGHT OF WAY LINE FOR A DISTANCE OF 179.52 FEET; THENCE DEPARTING SAID WESTERLY RIGHT OF WAY LINE FOR A DISTANCE OF 179.52 FEET; THENCE DEPARTING SAID WESTERLY RIGHT OF WAY LINE FOR A DISTANCE OF 159.99 FEET TO THE AFORESAID SOUTH LINE OF THE NORTHEAST QUARTER AND THE POINT OF BEGINNING.

LYING IN AND BEING A PORTION OF SECTION 6, TOWNSHIP 1 SOUTH, RANGE 31 WEST, ESCAMBIA COUNTY, FLORIDA AND CONTAINING 14.34 ACRES MORE OR LESS.



THE CONTRACTOR IS RESPONSIBLE FOR OBTAINING
"RELEASED FOR CONSTRUCTION" DRAWINGS FROM
REBOL-BATTLE & ASSOCIATES BEFORE BEGINNING
CONSTRUCTION. REBOL-BATTLE & ASSOCIATES WILL NOT BE
RESPONSIBLE FOR ANY CONSTRUCTION BASED ON PLANS
THAT HAVE NOT BEEN RELEASED FOR CONSTRUCTION.

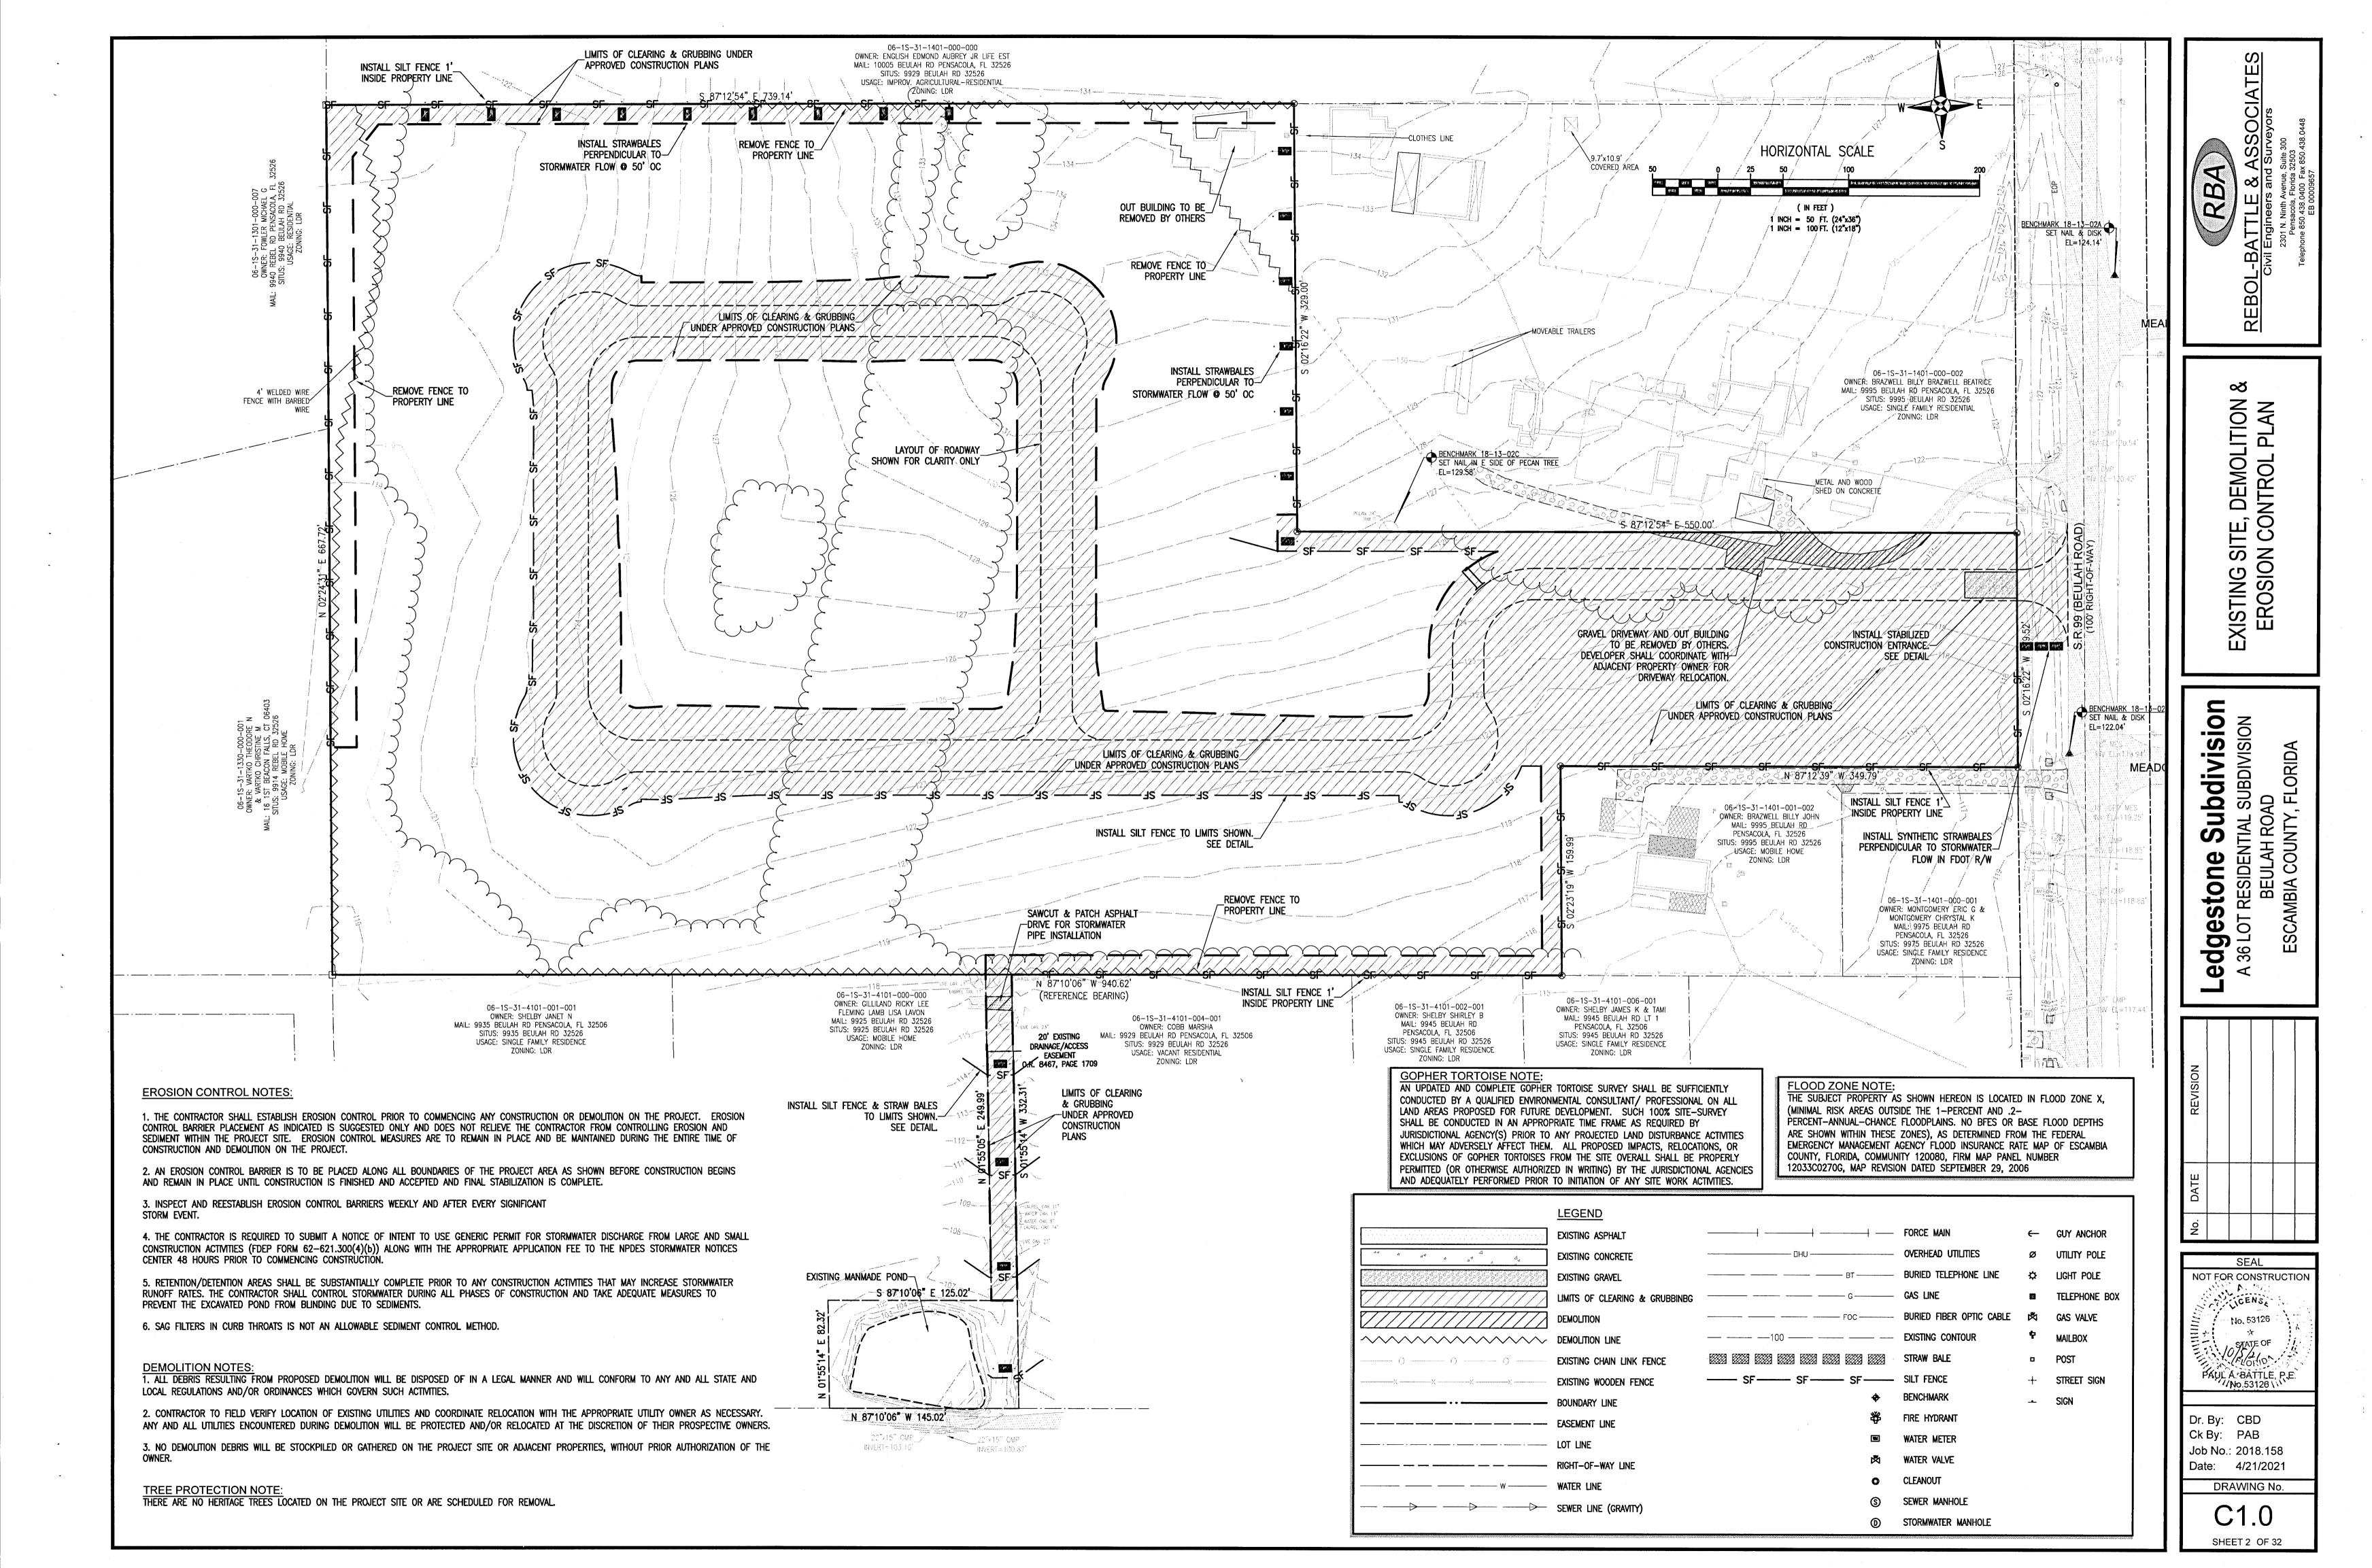

1. ALL EROSION AND SEDIMENT CONTROL PRACTICES TO BE INSTALLED PRIOR TO ANY MAJOR SOIL DISTURBANCE, OR IN THEIR PROPER SEQUENCE, AND MAINTAINED UNTIL PERMANENT PROTECTION IS

2. ANY DISTURBED AREAS THAT WILL BE LEFT EXPOSED MORE THAN 30 DAYS, AND NOT SUBJECT TO CONSTRUCTION TRAFFIC, WILL IMMEDIATELY RECEIVE A TEMPORARY SEEDING. IF THE SEASON PREVENTS THE ESTABLISHMENT OF A TEMPORARY COVER, THE DISTURBED AREAS WILL BE MULCHED WITH STRAW, OR EQUIVALENT MATERIAL, AT A RATE OF TWO (2) TONS PER ACRE, ACCORDING TO STATE STANDARDS.

3. PERMANENT VEGETATION TO BE SEEDED OR SODDED ON ALL EXPOSED AREAS WITHIN TEN (10) DAYS AFTER GRADING. MULCH TO BE USED AS NECESSARY FOR PROTECTION UNTIL SEEDING IS ESTABLISHED.

4. ALL WORK AND MATERIALS TO BE IN ACCORDANCE WITH THE FDOT "STANDARD SPECIFICATIONS FOR ROAD AND BRIDGE CONSTRUCTION", LATEST EDITION, SECTIONS 104, 570, 981, 982, 983, 985, & 987.

*5. A BITUMINOUS CONCRETE BASE COURSE WILL BE APPLIED IMMEDIATELY FOLLOWING ROUGH GRADING AND INSTALLATION OF IMPROVEMENTS IN ORDER TO STABILIZE STREETS, ROADS, DRIVEWAYS AND PARKING AREAS. IN AREAS WHERE NO UTILITIES ARE PRESENT, THE BITUMINOUS CONCRETE BASE SHALL BE INSTALLED WITHIN 15 DAYS OF THE PRELIMINARY GRADING.

*6. IMMEDIATELY FOLLOWING INITIAL DISTURBANCE OR ROUGH GRADING, ALL CRITICAL AREAS SUBJECT TO EROSION (I.E. STEEP SLOPES AND ROADWAY EMBANKMENTS) WILL RECEIVE A TEMPORARY SEEDING IN COMBINATION WITH STRAW MULCH OR A SUITABLE EQUIVALENT, AT A THICKNESS OF TWO (2) TO FOUR (4) INCHES MIXED WITH THE TOP TWO (2) INCHES OF SOIL, ACCORDING TO STATE STANDARDS.

*7. ANY STEEP SLOPES RECEIVING PIPELINE INSTALLATION WILL BE BACKFILLED AND STABILIZED DAILY, AS THE INSTALLATION PROCEEDS (I.E. SLOPES GREATER THAN 3:1).

*8. A CRUSHED LIMEROCK, VEHICLE WHEEL-CLEANING BLANKET SHALL BE INSTALLED AT THE CONTRACTOR'S STAGING YARD AND/OR STOCKPILE AREAS TO PREVENT OFF-SITE TRACKING OF SEDIMENT BY CONSTRUCTION VEHICLES ONTO PUBLIC ROADS. BLANKET SHALL BE 15FT. X 50FT. X 6IN. (MINIMUM), CRUSHED LIMEROCK 2 1/2 INCHES IN DIAMETER. SAID BLANKET SHALL BE UNDERLAIN WITH A FDOT CLASS 3 SYNTHETIC FILTER FABRIC AND MAINTAINED IN GOOD ORDER.

9. AT THE TIME WHEN THE SITE PREPARATION FOR PERMANENT VEGETATIVE STABILIZATION IS GOING TO BE ACCOMPLISHED, ANY SOIL THAT WILL NOT PROVIDE A SUITABLE ENVIRONMENT TO SUPPORT ADEQUATE VEGETATIVE GROUND COVER, SHALL BE REMOVED OR TREATED IN SUCH A WAY THAT WILL PERMANENTLY ADJUST THE SOIL CONDITIONS AND RENDER IT SUITABLE FOR VEGETATIVE GROUND COVER. IF THE REMOVAL OR TREATMENT OF THE SOIL WILL NOT PROVIDE SUITABLE CONDITIONS, NON-VEGETATIVE MEANS OF PERMANENT GROUND STABILIZATION WILL HAVE TO BE

*10. CONDUIT OUTLET PROTECTION MUST BE INSTALLED AT ALL REQUIRED OUTFALLS PRIOR TO THE DRAINAGE SYSTEM BECOMING OPERATIONAL.

11. UNFILTERED DEWATERING IS NOT PERMITTED. THE CONTRACTOR SHALL TAKE ALL NECESSARY PRECAUTIONS DURING ALL DEWATERING OPERATIONS TO MINIMIZE SEDIMENT TRANSFER.

12. SHOULD THE CONTROL OF DUST AT THE SITE BE NECESSARY, THE SITE WILL BE SPRINKLED UNTIL THE SURFACE IS WET, TEMPORARY VEGETATION COVER SHALL BE ESTABLISHED OR MULCH SHALL BE APPLIED IN ACCORDANCE WITH STATE STANDARDS FOR EROSION CONTROL.

13. ALL SOIL WASHED, DROPPED, SPILLED OR TRACKED OUTSIDE THE LIMIT OF DISTURBANCE OR ONTO PUBLIC RIGHTS-OF-WAY WILL BE REMOVED IMMEDIATELY.

14. THE CONTRACTOR SHALL BE RESPONSIBLE FOR ANY EROSION OR SEDIMENTATION THAT MAY OCCUR BELOW STORMWATER OUTFALLS OR OFFSITE AS A RESULT OF CONSTRUCTION OF THE PROJECT.

15. ALL SOIL STOCKPILES ARE TO BE TEMPORARILY STABILIZED IN ACCORDANCE WITH SOIL EROSION AND SEDIMENT CONTROL NOTE NUMBER 2 (ABOVE).

16. THE SITE SHALL AT ALL TIMES BE GRADED AND MAINTAINED SUCH THAT ALL STORM WATER RUNOFF IS DIVERTED TO SOIL EROSION AND SEDIMENT CONTROL FACILITIES.

17. ALL SEDIMENTATION STRUCTURES SHALL BE INSPECTED AND MAINTAINED REGULARLY.

18. ALL CATCH BASIN INLETS SHALL BE PROTECTED WITH HAY BALES AS SHOWN ON DETAIL.

19. THE CONTRACTOR SHALL PREPARE A PLAN FOR THE PROPER DEWATERING AND DOWNSTREAM SILTATION PROTECTION OF EACH STREAM CROSSING PRIOR TO EXCAVATING THE STREAM BED. PLAN SHALL BE FORWARDED TO THE ENGINEER FOR APPROVAL. THE ENGINEER SHALL BE NOTIFIED FOR INSPECTION PRIOR TO EACH STREAM CROSSING CONSTRUCTION.

20. ANY AREAS USED FOR THE CONTRACTOR'S STAGING, INCLUDING BUT NOT LIMITED TO, TEMPORARY STORAGE OF STOCKPILED MATERIALS (E.G. CRUSHED STONE, QUARRY PROCESS STONE, SELECT FILL, EXCAVATED MATERIALS, ETC.), SHALL BE ENTIRELY PROTECTED BY A SILT FENCE ALONG THE LOW ELEVATION SIDE TO CONTROL SEDIMENT RUNOFF.

* WHERE APPLICABLE

TEMPORARY SEEDING DETAILS:

SEED BED PREPARATION:

SOIL TO BE THOROUGHLY PULVERIZED BY DISK-HARROWING AND BE LOOSE AND REASONABLY SMOOTH. APPLY FERTILIZER AT A RATE OF 260 LBS/ACRE OF 16-16-16 OR EQUIVALENT, APPLY DOLOMITIC LIMESTONE AT A RATE OF 800 TO 1000 LBS./ACRE TO PROVIDE A SOIL pH OF 5.5 TO 6.5, LIME & FERTILIZER TO BE WORKED INTO THE TOPSOIL TO A DEPTH OF 4". ADD SANDY LOAM TOPSOIL TO A MINIMUM OF TWO (2) INCHES WHERE

SEED MIXTURE

CONSISTING OF ANNUAL RYE (LOLIUM MULTIFLORUM) AT A RATE OF 174 LBS/ACRE.

PERMANENT SEEDING DETAILS:

SEED BED PREPARATION:

SOIL TO BE THOROUGHLY PULVERIZED BY DISK-HARROWING AND BE LOOSE AND REASONABLY SMOOTH. APPLY FERTILIZER AT A RATE OF 260 LBS/ACRE OF 16-16-16 OR EQUIVALENT, APPLY DOLOMITIC LIMESTONE AT A RATE OF 800 TO 1000 LBS./ACRE TO PROVIDE A SOIL pH OF 5.5 TO 6.5, LIME & FERTILIZER TO BE WORKED INTO THE TOPSOIL TO A DEPTH OF 4". ADD SANDY LOAM TOPSOIL TO A MINIMUM OF TWO (2) INCHES WHERE

SEED MIXTURE CONSISTING OF RATE <u>PURITY</u> **GERMINATION** ARGENTINE BAHIA 95% 260 LBS/AC. 80% PENSACOLA BAHIA 260 LBS/AC. 95% 40%(MIN.)-80%(TOTAL)

SOD SHALL BE WELL ROOT MATTED CENTIPEDE OR BAHIA GRASS COMMERCIALLY CUT TO A MINIMUM DIMENSION OF 12" x 24" A MAXIMUM OF 72 HOURS PRIOR TO PLACEMENT. SOD SHALL BE LIVE, FRESH AND UNINJURED, REASONABLY FREE OF WEEDS AND OTHER GRASSES, WITH A HEAVY SOIL MAT ADHERING TO THE ROOT SYSTEM. SOD SHALL BE GROWN, CUT, AND SUPPLIED BY A STATE CERTIFIED GROWER.

TRAFFIC CONTROL STANDARDS:

1. CONSTRUCTION TRAFFIC SHALL BE RESTRICTED TO ONSITE ACCESS BY MEANS SO DESIGNATED BY THE ENGINEER, POLICE/SHERIFF DEPARTMENT, ESCAMBIA COUNTY HIGHWAY DEPARTMENT, AND/OR THE FLORIDA DEPARTMENT OF TRANSPORTATION. 2. TRAFFIC DURING WET WEATHER SHALL BE MINIMIZED AND APPROPRIATE ROADWAY AND SITE CLEAN-UP SHALL

TREE PROTECTION:

1. DAMAGED TRUNKS OR EXPOSED ROOTS WILL BE PAINTED IMMEDIATELY WITH A GOOD GRADE OF "TREE

BE PROVIDED BY THE CONTRACTOR AS SOON AS WEATHER CONDITIONS PERMIT.

2. TREE LIMB REMOVAL, WHERE NECESSARY, WILL BE DONE FLUSH TO TRUNK OR MAIN BRANCH AND THAT AREA PAINTED IMMEDIATELY WITH A GOOD GRADE OF TREE PAINT.

DUST CONTROL

1. ALL AREAS OF CLEARING AND EMBANKMENT AS WELL AS CONSTRUCTION HAUL ROADS SHALL BE TREATED AND MAINTAINED IN SUCH A MANNER AS TO MINIMIZE ANY DUST GENERATION.

2. DISTURBED AREAS SHALL BE MAINTAINED IN A ROUGH GRADED CONDITION AND TEMPORARILY SEEDED AND/OR MULCHED UNTIL PROPER WEATHER CONDITIONS EXIST FOR THE ESTABLISHMENT OF PERMANENT

3. IN EVENT OF EMERGENCY CONDITIONS, TILLAGE WILL BE SATISFACTORY FREE BEFORE SOIL BLOWING STARTS.

4. CALCIUM CHLORIDE MAY BE APPLIED TO UNPAVED ROADWAY AREAS, ONLY, SUBJECT TO THE ENGINEER'S APPROVAL AND CONFORMANCE WITH FDOT STANDARD SPECIFICATIONS, SECTION 102-5, LATEST EDITION.

PROPOSED SEQUENCE OF CONSTRUCTION

1. THE INSTALLATION OF ALL SEDIMENT AND EROSION CONTROL DEVICES THAT CAN BE PLACED PRIOR TO ANY MAJOR SOIL DISTURBANCES.

2. CLEAR AND REMOVE ALL EXISTING VEGETATION IN THOSE AREAS WHERE NECESSARY. ALL REMAINING VEGETATION IS TO BE PROPERLY PROTECTED AND IS TO REMAIN IN ITS NATURAL STATE. TOPSOIL IN AREAS TO BE DISTURBED IS TO BE STRIPPED TO A MINIMUM DEPTH OF SIX (6) INCHES AND STOCKPILED SEPARATELY FROM FROM OTHER EXCAVATED SOIL(S)

3. THE IMMEDIATE INSTALLATION OF ALL REMAINING SEDIMENT AND EROSION CONTROL DEVICES.

PERFORM ALL DEMOLITION WORK.


5. CONSTRUCT ALL UNDERGROUND UTILITIES AND STORM DRAIN SYSTEMS.

6. CONSTRUCT ROADS (SUBGRADE, CURB & GUTTER, BASE, PAVEMENT, SIDEWALKS AND LANDSCAPING).


7. COMPLETE STORMWATER PONDS.

8. UPON THE COMPLETION OF THE CONSTRUCTION ACTIVITIES, PROVIDE RESTORATION, FINE GRADE REMAINDER OF SITE, RESPREAD STOCKPILED TOPSOIL AND STABILIZE WITH PERMANENT VEGETATIVE COVER AND

9. THE REMOVAL OF APPROPRIATE TEMPORARY SEDIMENT AND EROSION CONTROL DEVICES.

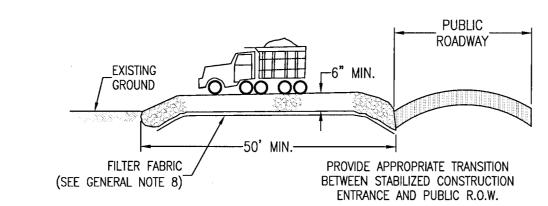

STABILIZED CONSTRUCTION ENTRANCE DETAIL N.T.S.

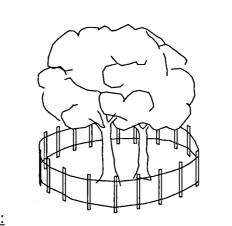

ALL PROTECTED TREES AS SHOWN ON THE PLANS TO REMAIN ARE TO BE PROTECTED DURING CONSTRUCTION. THE CONTRACTOR SHALL INSTALL ORANGE CONSTRUCTION FENCING AT THE DRIP LINE OF EACH PROTECTED TREE BEFORE WORKING IN THE VICINITY OF THE TREE.


TREE BARRICADE DETAIL N.T.S.

FILTER BAGS WILL BE USED AS AN EFFECTIVE FILTER MEDIUM TO CONTAIN SAND, SILT AND FINES WHEN TRENCH DEWATERING. THE WETLAND FILTER BAG CONTAINS THESE MATERIALS WHILE ALLOWING THE WATER TO FLOW THROUGH THE FABRIC.

WETLAND FILTER BAGS MAY REPLACE HAY BALE CORRALS DURING TRENCH DEWATERING, AT THE DISCRETION OF THE ENGINEER INSPECTOR. TO INSURE PROPER INSTALLATION, FILTER BAGS WILL BE PLACED ON RELATIVELY FLAT TERRAIN FREE OF BRUSH AND STUMPS TO AVOID RUPTURES AND PUNCTURES. PROPER INSTALLATION REQUIRES CUTTING A SMALL HOLE IN THE CORNER OF THE BAG, INSERTING THE PUMP DISCHARGE HOSE, AND THEN SECURING THE DISCHARGE HOSE TO THE BAG WITH A HOSE CLAMP. FILTER BAGS WILL BE PLACED AS FAR AWAY FROM FLOWING STREAMS AND WETLANDS AS POSSIBLE.

PRIOR TO REMOVING A BAG FROM THE HOSE, THE BAG WILL BE TIED OFF BELOW THE END OF THE HOSE ALLOWING THE BAG TO DRAIN. DRAINAGE WILL NOT BE ALLOWED THROUGH THE INLET HOLE. TO AVOID RUPTURE, THE BAGS WILL BE ATTENDED AND PUMPING RATES MONITORED. ONCE THE BAG IS INFLATED TO A HEIGHT OF 4 FEET. PUMPING WILL STOP TO AVOID RUPTURE. FILTER BAGS USED DURING CONSTRUCTION WILL BE BUNDLED AND REMOVED FOR PROPER DISPOSAL.

FILTER BAGS ARE CONSTRUCTED OF NON-WOVEN GEOTEXTILE FABRIC. A MAXIMUM OF ONE SIX INCH DISCHARGE HOSE WILL BE ALLOWED PER FILTER BAG. BAG CAPACITY WILL BE EXCEEDED BEYOND 2,000 GALLONS PER MINUTE. TYPICAL BAG DIMENSIONS ARE 15 FEET BY 13.25 FEET. TO HELP PREVENT PUNCTURES, GEOTEXTILE FABRIC WILL BE PLACED BENEATH THE FILTER BAG WHEN USED IN WOODED LOCATIONS. UNATTENDED FILTER BAGS WILL BE ENCIRCLED WITH A HAY BALE OR SILT FENCE CORRAL, HOSE CLAMPS WILL BE USED TO SECURE THE DISCHARGE HOSE, WIRE OR STRING WILL NOT BE USED.

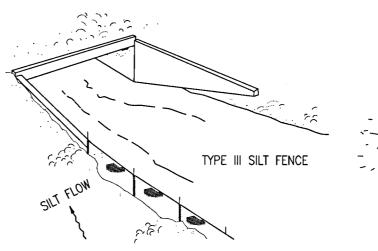

AS REQUIRED-

ANCHOR BALES WITH

STAKES PER BALE.

(2)-2"X2"X4'-

ELEVATION

ELEVATION

GROUND SLOPES AWAY FROM THE TOE OF SLOPE

BARRIERS FOR FILL SLOPES

N.T.S.

PLAN VIEW

29.75.75 XXXXXXXXX

CROSS SECTION

FILTER BAG DETAIL FOR

TRENCH DEWATERING OPERATIONS

N.T.S.

FILTER BAG-

SURFACE

TO BE USED AT SELECTED SITES WHERE THE NATURAL

GROUND SLOPES TOWARD THE TOE OF SLOPE

TO BE USED AT SELECTED SITES WHERE THE NATURAL

ANCHOR BALES WITH

STAKES PER BALE.

LOOSE SOIL PLACED BY SHOVEL AND LIGHTLY

COMPACTED ALONG THE UPSTREAM EDGE OF BALES.

-HOSE CLAMP

_HOSE CLAMP

-WOODEN STAKES

PUMP DISCHARGE


-WOODEN STAKES


HOSE


PUMP DISCHARGE

—(2)-2"X2"X4'

FILL SLOPE

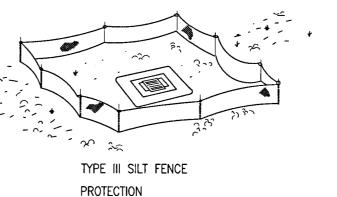

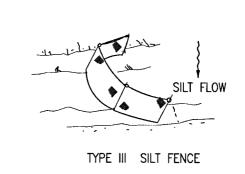


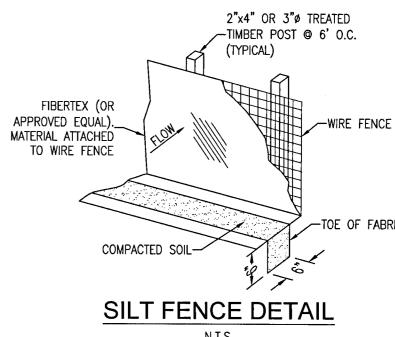




AROUND DITCH BOTTOM INLETS.

DO NOT DEPLOY IN A MANNER THAT SILT FENCES WILL ACT AS A DAM ACROSS PERMANENT FLOWING WATERCOURSES. SILT FENCES ARE TO BE USED AT UPLAND LOCATIONS AND TURBIDITY BARRIERS USED AT PERMANENT BODIES OF WATER.

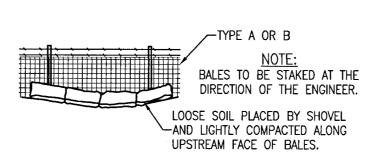


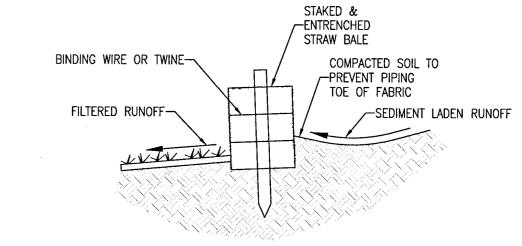

STRAW BALES BACKED BY FENCE

STRAW BALE DETAIL N.T.S.


THE UPSTREAM EDGE OF BALES.

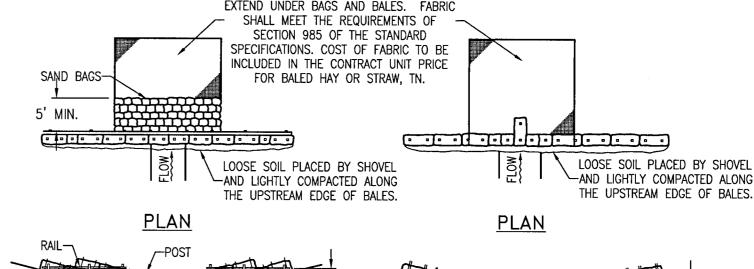


WOVEN FILTER FABRIC IN ABSENCE OF

ESTABLISHED GRASS (APPROX. 12' X 12').

SECURE EDGES BY ENTRENCHING AND

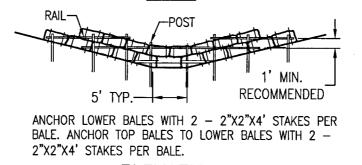

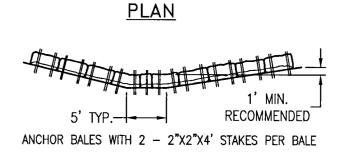



ELEVATION

ELEVATION

APPLICATION AND SPACING: THE USE OF TYPES I & II BALE BARRIERS SHOULD BE LIMITED TO THE CONDITIONS OUTLINED IN CHART I, SHEET 1 OF 3, INDEX NO. 102 TYPE II

BARRIER FOR UNPAVED DITCH N.T.S.

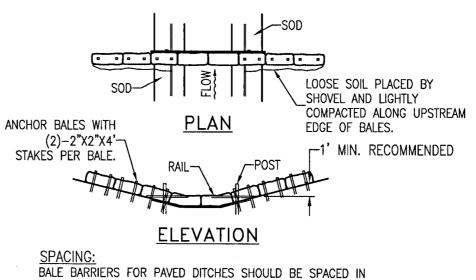


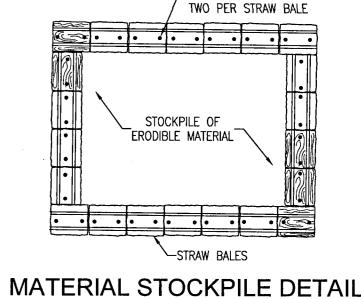

N.T.S.

ANCHOR PINS -No. 5 STEEL BARS

ACCORDANCE WITH CHART I, SHEET 1 OF 3, INDEX NO. 102 BARRIER FOR PAVED DITCH N.T.S.

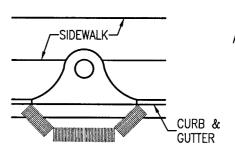

ANCHOR BALES WITH (2)-2"x2"x4' STAKES PER BALE. DITCH ~~~ ---- DITCH

PARTIAL INLET COMPLETED INLET DITCH BOTTOM INLET

PROTECTION AROUND INLETS OR SIMILAR STRUCTURES

0 Ö SION 0

S S 0 2 gestone LOT RESIDE BEULA ESCAMBIA CC ם ב **5** %

• 4

SEAL NOT FOR CONSTRUCTION CENS No. 53126 STATE OF 10/5 /29 RION PAUL'A/BATTLE P.E. No 53126

Dr. By: CBD Ck By: PAB Job No.: 2018.158 Date: 4/21/2021

DRAWING No.

SHEET 3 OF 32

1.0 BACKGROUND & REQUIREMENTS:

1.1 INTRODUCTION:

THE REFERENCED SUPPORT DOCUMENTATION FOR THIS STORM WATER POLLUTION PREVENTION PLAN (SWPPP) IS THE UNITED STATES ENVIRONMENTAL PROTECTION AGENCY'S (EPA) STORM WATER MANAGEMENT FOR CONSTRUCTION ACTIVITIES, DEVELOPING POLLUTION PREVENTION PLANS AND BEST MANAGEMENT PRACTICES SUMMARY GUIDANCE (EPA 833-R-92-001) AND STORM WATER MANAGEMENT FOR CONSTRUCTION ACTIVITIES, DEVELOPING POLLUTION PREVENTION PLANS AND BEST MANAGEMENT PRACTICES (EPA 832-R-92-005). THIS SWPPP IS DESIGNED TO PROTECT ONSITE AND ADJACENT NATURAL RESOURCES, INCLUDING BUT NOT LIMITED TO, WETLANDS, MARSHES, BAYOUS AND BAYS, WHILE PRESERVING WILDLIFE AND ARCHEOLOGICAL RESOURCES.

AN ENVIRONMENTAL RESOURCE PERMIT APPLICATION HAS BEEN SUBMITTED NWFWMD MARCH 2019

1.2 NOTICE OF INTENT (NOI):

RULE 62-621.300(4), FAC REQUIRES THE CONSTRUCTION OPERATOR OF A SITE THAT DISTURBS ONE OR MORE ACRES TO OBTAIN COVERAGE FROM THE GENERIC PERMIT FOR STORMWATER DISCHARGE FROM LARGE AND SMALL CONSTRUCTION ACTIVITIES. THE CONTRACTOR IS REQUIRED TO SUBMIT A NOTICE OF INTENT TO USE GENERIC PERMIT FOR STORMWATER DISCHARGE FROM LARGE AND SMALL CONSTRUCTION ACTIVITIES (FDEP FORM 62-621.300(4)(B)) ALONG WITH THE APPROPRIATE APPLICATION FEE TO THE FOLLOWING ADDRESS 48 HOURS PRIOR TO COMMENCING CONSTRUCTION:

NPDES STORMWATER NOTICES CENTER, MS # 2510 FLORIDA DEPARTMENT OF ENVIRONMENTAL PROTECTION 2600 BLAIR STONE ROAD TALLAHASSEE, FLORIDA 32399-2400

THIS FORM CAN BE OBTAINED FROM FDEP'S WEBSITE (WWW.DEP.STATE.FL.US) OR BY CONTACTING FDEP. PLEASE NOTE THAT THE CURRENT APPLICATION FEE IS \$300; HOWEVER, THIS FEE IS SUBJECT TO CHANGE WITHOUT NOTICE. ALWAYS REFER TO THE MOST CURRENT VERSION OF RULE 62-4.050(4)(D), FAC TO CONFIRM THE AMOUNT BEFORE SUBMITTING PAYMENT. IF CONSTRUCTION ACTIVITY EXCEEDS FIVE YEARS, THE CONTRACTOR MUST RE-APPLY FOR COVERAGE.

1.3 STORMWATER POLLUTION PREVENTION PLAN (SWPPP):

THE CONTRACTOR IS REQUIRED TO CERTIFY THIS STORMWATER POLLUTION PREVENTION PLAN (SWPPP) BELOW PRIOR TO SUBMITTING THE NOI. THIS SWPPP IS NOT REQUIRED TO BE SUBMITTED WITH THE NOI, BUT IS REQUIRED TO BE KEPT ON SITE DURING ALL PHASES OF CONSTRUCTION. BECAUSE EROSION AND SEDIMENT CONTROLS AND CONSTRUCTION METHODS VARY SIGNIFICANTLY FROM CONTRACTOR TO CONTRACTOR, THE CONTRACTOR CAN PROPOSE ALTERNATIVE METHODS TO THIS SWPPP THAT ARE EQUAL OR BETTER AT CONTROLLING EROSION AND SEDIMENTATION. AT A MINIMUM. THE CONTRACTOR MUST FOLLOW THE EROSION CONTROL PLAN SPECIFIED IN THE CONSTRUCTION PLANS AND DOCUMENTS. ANY MODIFICATIONS TO THIS SWPPP MUST BE DOCUMENTED AND KEPT WITH THE PLAN AS PART OF THE RECORDS KEEPING PROCESS TO BE IN FULL COMPLIANCE WITH THE CGP.

1.4 CONTRACTOR'S / SUBCONTRACTOR CERTIFICATION:

I CERTIFY UNDER PENALTY OF LAW THAT I UNDERSTAND, AND SHALL COMPLY WITH, THE TERMS AND CONDITIONS OF THE STATE OF FLORIDA GENERIC PERMIT FOR STORMWATER DISCHARGE FROM LARGE AND SMALL CONSTRUCTION ACTIVITIES AND THIS STROMWATER POLLUTION PREVENTION PLAN PREPARED THEREUNDER.

PRINT & SIGN NAME		COMPANY & ADDRESS
NAME & TITLE (PRINT)		
SIGNATURE	DATE	

1.5 RESPONSIBLE AUTHORITY CERTIFICATION:

SIGNATURE

I CERTIFY UNDER PENALTY OF LAW THAT THIS DOCUMENT AND ALL ATTACHMENTS WERE PREPARED UNDER MY DIRECTION OR SUPERVISION IN ACCORDANCE WITH A SYSTEM DESIGNED TO ASSURE THAT QUALIFIED PERSONNEL GATHERED AND EVALUATED THE INFORMATION SUBMITTED. BASED ON MY INQUIRY OF THE PERSON OR PERSONS WHO MANAGE THE SYSTEM, OR THOSE PERSONS DIRECTLY RESPONSIBLE FOR GATHERING THE INFORMATION, THE INFORMATION SUBMITTED IS, TO THE BEST OF MY KNOWLEDGE AND BELIEF, TRUE, ACCURATE, AND COMPLETE. I AM AWARE THAT THERE ARE SIGNIFICANT PENALTIES FOR SUBMITTING FALSE INFORMATION, INCLUDING THE POSSIBILITY OF FINE AND IMPRISONMENT FOR KNOWING VIOLATIONS.

PRINT & SIGN NAME	COMPANY & ADDRESS
NAME & TITLE (PRINT)	
NAME & TILE (FRINT)	

1.6 NOTICE OF TERMINATION (NOT):

THE CONTRACTOR IS REQUIRED TO SUBMIT A NOTICE OF TERMINATION OF GENERIC PERMIT COVERAGE (FDEP FORM 62-621.300(6)) UPON CONSTRUCTION COMPLETION TO DISCONTINUE PERMIT COVERAGE. THE NOT IS TO BE SUBMITTED TO THE FOLLOWING ADDRESS:

NPDES STORMWATER NOTICES CENTER, MS # 2510 FLORIDA DEPARTMENT OF ENVIRONMENTAL PROTECTION 2600 BLAIR STONE ROAD TALLAHASSEE, FLORIDA 32399-2400

THIS FORM CAN BE OBTAINED FROM FDEP'S WEBSITE (WWW.DEP.STATE.FL.US) OR BY CONTACTING FDEP. THE NOT CAN NOT BE SUBMITTED UNTIL ALL DISTURBED SOILS AT THE CONSTRUCTION SITE HAVE BEEN FINALLY STABILIZED AND TEMPORARY EROSION AND SEDIMENT CONTROL MEASURES HAVE BEEN REMOVED OR WILL BE REMOVED AT AN APPROPRIATE TIME. FINAL STABILIZATION MEANS THAT ALL SOIL DISTURBING ACTIVITIES AT THE SITE HAVE BEEN COMPLETED AND THAT A UNIFORM PERENNIAL VEGETATIVE COVER WITH A DENSITY OF 70 PERCENT OF THE COVER FOR UNPAVED AREAS AND AREAS NOT COVERED BY PERMANENT STRUCTURES HAS BEEN ESTABLISHED, OR EQUIVALENT STABILIZATION MEASURES HAVE BEEN EMPLOYED. IF CONSTRUCTION ACTIVITY EXCEEDS FIVE YEARS, THE CONTRACTOR MUST RE-APPLY FOR COVERAGE.

1.7 APPLICATION INFORMATION:

1.7 AT LIGATION IN ORMATIO	٧.
PROJECT ADDRESS:	8600 BLK BELUAH ROAD PENSACOLA, FL 32526
LATITUDE: LONGITUDE:	N 30°32'37.09" W 87°22'57.40"
WATER MANAGEMENT DISTRICT:	NORTHWEST FLORIDA (NWFWMD)

2.0 SITE DESCRIPTION:

MS4 OPERATOR NAME:

RECEIVING WATER NAME:

2.1 NATURE OF CONSTRUCTION ACTIVITIES:

THIS PROJECT INVOLVES THE CONSTRUCTION OF A 36 LOT SINGLE FAMILY RESIDENTIAL SUBDIVISION, UTILITIES AND STORMWATER COLLECTION SYSTEM.

ESCAMBIA COUNTY

EVENTUAL OUTFALL TO ELEVEN MILE CREEK

2.2 SEQUENCE OF MAJOR SOIL DISTURBING ACTIVITIES:

THE FOLLOWING SEQUENCE OF MAJOR ACTIVITIES SHALL BE FOLLOWED UNLESS THE CONTRACTOR CAN PROPOSE AN ALTERNATIVE THAT IS EQUAL TO OR BETTER AT CONTROLLING EROSION AND SEDIMENTATION. THE DETAILED SEQUENCE FOR THE ENTIRE PROJECT CAN VARY SIGNIFICANTLY FROM CONTRACTOR TO CONTRACTOR. THE CONTRACTOR IS RESPONSIBLE FOR DOCUMENTING ANY CHANGES.

1. CLEAR, GRUB AND PERFORM ALL DEMOLITION WORK.

- 2. COMPLETE ROUGH GRADING OF THE POND AND DIRECT ALL STORMWATER RUNOFF TO THE
- 3. CONSTRUCT ALL UNDERGROUND UTILITIES AND STORM DRAIN SYSTEM.
- 4. CONSTRUCT ROADS (SUBGRADE, CURB & GUTTER, BASE, PAVEMENT, SIDEWALKS, AND LANDSCAPING).
- 5. COMPLETE STORMWATER PONDS.

2.3 AREA ESTIMATES:

ONSITE AREA:	14.37 ACRES
OFFSITE AREA:	0.00 ACRES
TOTAL AREA:	14.37 ACRES
AREA TO BE DISTURBED:	14.37 ACRES

2.4 RUNOFF DATA:

RUNOFF COEFFICIENTS (C):

BEFORE:	TOTAL COMPOSITE C :	= 0.20 AND 0.95
DURING:	VARIES BETWEEN =	0.20 AND 0.95
AFTER:	VARIES BETWEEN =	0.20 AND 0.95
TOTAL COM	POSITE C =	0.60

SOILS DATA: THE SOILS LOCATED AT THE SITE ARE PREDOMINATELY VERY LOOSE TO LOOSE SLIGHTLY SILTY SANDS. GROUNDWATER WAS NOT ENCOUNTERED IN THE 15 FT TO 20 FT DEEP TEST BORING. FOR MORE DETAILED SOILS INFORMATION, REFER TO THE GEOTECHNICAL SERVICES REPORT PREPARED BY UNIVERSAL ENGINEERING SERVICES.

DRAINAGE AREAS FOR EACH OUTFALL:

OUTFALL LOCATION	TOTAL AREA FLOWING TO	POND 'C' COEFFICIENT
EXISTING CONVEYANCE		
PIPED TO NEIGHBORING POND VIA DRAINAGE EASEMENT	14.37	0.60

2.5 SITE MAP:

- THE CONSTRUCTION PLANS ARE TO BE USED AS THE SITE MAPS. THE LOCATION OF THE REQUIRED INFORMATION IS DESCRIBED BELOW. THE SHEET NUMBERS FOR ALL THE ITEMS DISCUSSED BELOW ARE IDENTIFIED ON THE KEY SHEET OF THE CONSTRUCTION PLANS.
- DRAINAGE PATTERNS: ALL DRAINAGE PATTERNS ARE SHOWN ON THE GRADING & DRAINAGE PLANS.
- APPROXIMATE SLOPES: APPROXIMATE SLOPES ARE SHOWN ON THE GRADING & DRAINAGE POND SIDE SLOPES ARE SHOWN ON THE POND CROSS-SECTIONS.
- AREAS OF SOIL DISTURBANCE: ALL DEMOLITION IS SHOWN ON THE EXISTING SITE CONDITIONS AND DEMOLITION AND EROSION CONTROL PLAN SHEET. ALL PROPOSED CONSTRUCTION IS SHOWN ON THE REMAINING PLANS. ANY AREAS WHERE DEMOLITION WORK OR PERMANENT FEATURES ARE SHOWN ABOVE OR BELOW GROUND WILL BE DISTURBED.
- AREAS NOT TO BE DISTURBED: ANY AREAS NOT SHOWING DEMOLITION WORK OR PERMANENT FEATURES ARE ASSUMED NOT TO BE DISTURBED. IT WILL BE THE CONTRACTOR'S RESPONSIBILITY TO INDICATE ON THE PLANS ANY OF THESE AREAS THAT DO GET DISTURBED AS WELL AS ANY AREAS USED FOR STAGING AND MATERIALS STORAGE.
- LOCATIONS OF CONTROLS: ALL PROPOSED TEMPORARY CONTROLS AND EXISTING PERMANENT CONTROLS ARE SHOWN ON THE EXISTING SITE. DEMOLITION AND EROSION CONTROL PLAN. ALL PROPOSED PERMANENT CONTROLS ARE SHOWN ON THE REMAINING PLANS. IT WILL BE THE CONTRACTOR'S RESPONSIBILITY TO INDICATE THE LOCATION OF ANY OTHER CONTROLS ON THE PLANS THAT ARE USED DURING CONSTRUCTION.
- PERMANENT STABILIZATION IS SHOWN ON THE PLANS. IT WILL BE THE CONTRACTOR'S RESPONSIBILITY TO INDICATE THE LOCATION ON THE PLANS OF ALL TEMPORARY STABILIZATION PRACTICES USED DURING CONSTRUCTION.
- SURFACE WATERS: N/A
- <u>DISCHARGE POINTS:</u> ESCAMBIA COUNTY STORMWATER SYSTEM

2.6 RECEIVING WATERS:

EVENTUAL OUTFALL TO ELEVEN MILE CREEK

3.0 CONTROLS:

3.1 EROSION AND SEDIMENT CONTROLS:

ALL EROSION AND SEDIMENT CONTROLS SPECIFIED ON THE DEMOLITION AND EROSION CONTROL PLAN SHEETS, AND THE EROSION CONTROL DETAILS SHALL BE INSTALLED PRIOR TO ANY CONSTRUCTION OR DEMOLITION. SILT FENCING AND STAKED HAY BALES SHALL BE INSTALLED ALONG DOWN-GRADIENT LIMITS.

TEMPORARY SEEDING AND MULCHING SHALL BE APPLIED AFTER 14-DAY INTERVALS OF CEASED DISTURBANCE ACTIVITIES THAT WILL EXCEED 20-DAY PERIODS. GRADED AREAS SHALL BE STABILIZED WITH PERMANENT SEEDING. MULCHING, AND FERTILIZING, OR SODDING WITHIN FIVE DAYS OF FINAL GRADING. LANDSCAPING, INCLUDING SODDING, SHALL BE INSTALLED BY AN EXPERIENCED LANDSCAPE CONTRACTOR. PROPOSED DISTURBED AREAS WILL NOT EXCEED 8 ACRES IN ANY DRAINAGE AREA.

3.2 STORMWATER MANAGEMENT:

PROPOSED STORMWATER MANAGEMENT FACILITIES FOR THIS SITE INCLUDE: A DRY RETENTION POND FOR THE ENTIRE PROPERTY.

THE PROPOSED STORMWATER MANAGEMENT FACILITIES MEET ALL STORMWATER TREATMENT REQUIREMENTS AND ALL RATE CONTROL REQUIREMENTS SET FORTH BY THE LOCAL AND STATE REGULATORY AGENCIES.

3.3 OTHER CONTROLS:

WASTE DISPOSAL: THE CONTRACTOR IS RESPONSIBLE FOR ALL WASTE DISPOSAL FROM THE SITE. THE CONTRACTOR SHALL EMPLOY WASTE DISPOSAL PRACTICES THAT MEET ALL LOCAL, STATE, AND FEDERAL GUIDELINES AND PREVENT DISCHARGE OF SOLID MATERIALS TO WATERS OF THE UNITED STATES. THE CONTRACTOR IS RESPONSIBLE FOR DOCUMENTING THIS PORTION OF THE SWPPP.

OFFSITE VEHICLE TRACKING: IF OFF SITE TRACKING OF SEDIMENTS BY CONSTRUCTION VEHICLES OCCURS, THE CONTRACTOR IS REQUIRED TO INSTALL A SOIL TRACKING PREVENTION DEVICE (STPD) AS PER FDOT STANDARD INDEX 106 AT ALL EXITS TO THE SITE WHERE SEDIMENT TRACKING IS OCCURRING. THE CONTRACTOR IS ALSO RESPONSIBLE FOR DOCUMENTING THIS PORTION OF THE SWPPP.

HAZARDOUS MATERIALS: ALL POLLUTANTS AND HAZARDOUS MATERIALS INCLUDING BUT NOT LIMITED TO FERTILIZERS, HERBICIDES, PESTICIDES, SOLVENTS, OILS AND OIL FILTERS, PETROLEUM PRODUCTS, PAINT, AND EQUIPMENT MAINTENANCE FLUIDS, SHALL BE STORED INDOORS OR UNDER COVER IN AREAS WITH SECONDARY CONTAINMENT. SECONDARY CONTAINMENT PREVENTS A SPILL FROM SPREADING ACROSS THE SITE AND INCLUDES DIKES, BERMS, CURBING, OR OTHER CONTAINMENT METHODS. HAZARDOUS MATERIAL STORAGE AREAS SHALL BE INSPECTED WEEKLY AND AFTER STORM EVENTS. STORAGE AREAS SHALL BE KEPT CLEAN, WELL ORGANIZED, AND EQUIPPED WITH AMPLE CLEANUP SUPPLIES/SPILL KITS AS APPROPRIATE FOR THE MATERIALS BEING STORED. MATERIAL SAFETY DATA SHEETS, MATERIAL INVENTORY, AND EMERGENCY CONTACT INFORMATION SHALL BE MAINTAINED ON-SITE. ALL PERSONNEL SHALL RECEIVE INSTRUCTION REGARDING PROPER PROCEDURES FOR HAZARDOUS MATERIAL HANDLING AND DISPOSAL. HAZARDOUS MATERIALS SHALL NOT BE DISPOSED OF INTO ON-SITE DUMPSTERS; HAZARDOUS MATERIALS SHALL BE DISPOSED OF IN ACCORDANCE WITH FEDERAL, STATE, AND MUNICIPAL REGULATIONS. VEHICLES AND EQUIPMENT WILL BE MAINTAINED OFF-SITE. ALL VEHICLES AND EQUIPMENT INCLUDING SUBCONTRACTOR VEHICLES WILL BE CHECKED FOR LEAKING OIL AND FLUIDS. VEHICLES LEAKING FLUIDS WILL NOT BE ALLOWED ON-SITE. DRIP PANS SHALL BE PLACED UNDER ALL VEHICLES AND EQUIPMENT THAT ARE PARKED OVERNIGHT.

APPLICATION OF FERTILIZERS, HERBICIDES, AND PESTICIDES: FERTILIZERS, HERBICIDES, AND PESTICIDES SHALL BE DELIVERED TO THE SITE IN ORIGINAL, UNOPENED CONTAINERS BEARING MANUFACTURER'S CHEMICAL ANALYSIS. NAME, TRADE NAME, TRADEMARK, AND INDICATION OF CONFORMANCE TO STATE AND FEDERAL LAWS. FERTILIZERS, HERBICIDES, AND PESTICIDES SHALL BE IN APPLIED IN ACCORDANCE WITH THE MANUFACTURER'S SUGGESTED

5.0 INSPECTIONS:

QUALIFIED PERSONNEL SHALL INSPECT THE FOLLOWING ITEMS, BUT NOT LIMITED TO, AT LEAST ONCE EVERY SEVEN CALENDAR DAYS AND WITHIN 24 HOURS OF THE END OF A STORM THAT IS 0.25 INCHES OR GREATER. WHERE SITES HAVE BEEN FINALLY STABILIZED, INSPECTIONS SHALL BE CONDUCTED AT LEAST ONCE EVERY MONTH.

- POINTS OF DISCHARGE TO WATERS OF THE UNITED STATES. POINTS OF DISCHARGE TO MUNICIPAL SEPARATE STORM SEWER
- DISTURBED AREAS OF THE SITE THAT HAVE NOT BEEN FINALLY
- AREAS USED FOR STORAGE OF MATERIALS THAT ARE EXPOSED TO PRECIPITATION.
- STRUCTURAL CONTROLS.
- STORMWATER MANAGEMENT SYSTEMS.
- LOCATIONS WHERE VEHICLES ENTER OR EXIT THE SITE.

6.0 NON-STORMWATER DISCHARGES:

THE CONTRACTOR SHALL BE RESPONSIBLE FOR REPORTING ANY HAZARDOUS SUBSTANCE SPILLS THAT MAY EQUAL OR EXCEED A REPORTABLE QUANTITY (RQ). REFER TO EPA'S LIST OF HAZARDOUS SUBSTANCES AND REPORTABLE QUANTITIES (EPA 40 CFR 302.4 & 117). V THIS LIST CAN BE OBTAINED FROM EPA'S WEBSITE (WWW.EPA.GO) OR BY CONTACTING EPA. IF AN RQ RELEASE DOES OCCUR THE CONTRACTOR SHALL PERFORM THE FOLLOWING PROCEDURES:

- NOTIFY THE NATIONAL RESPONSE CENTER IMMEDIATELY AT
- 800-424-8802. PROVIDE WRITTEN DESCRIPTION OF THE RELEASE WITHIN 14 DAYS PROVIDING DATES, CAUSE AND PREVENTION METHODS TO THE REGIONAL
- EPA OFFICE. MODIFY THE SWPPP AS NECESSARY TO ADDRESS ADDED PREVENTION METHODS.

7.0 IMPLEMENTATION CHECKLIST:

7.1 RECORDS:

THE CONTRACTOR SHALL MAINTAIN RECORDS OF CONSTRUCTION ACTIVITIES INCLUDING, BUT NOT LIMITED TO:

- DATES WHEN MAJOR GRADING ACTIVITIES OCCUR. DATES WHEN CONSTRUCTION ACTIVITIES TEMPORARILY CEASE ON A
- PORTION OF THE SITE. DATES WHEN CONSTRUCTION ACTIVITIES PERMANENTLY CEASE ON A
- PORTION OF THE SITE.
- DATES WHEN STABILIZATION MEASURES ARE INITIATED ON THE SITE.

7.2 INSPECTION REPORTS:

THE CONTRACTOR SHALL PREPARE INSPECTION REPORTS SUMMARIZING THE FOLLOWING, BUT NOT LIMITED TO:

- NAME OF INSPECTOR.
- QUALIFICATIONS OF INSPECTOR.
- MEASURES/AREAS INSPECTED. OBSERVED CONDITIONS.
- CHANGES NECESSARY TO THE SWPPP.

7.3 RELEASES OF REPORTABLE QUANTITIES OF OIL OR HAZARDOUS MATERIALS:

THE CONTRACTOR SHALL REPORT ANY RELEASES OF REPORTABLE QUANTITIES OF OIL OR HAZARDOUS MATERIALS IF THEY OCCUR AS PER THE MEASURES OUTLINED IN SECTION 6.0 OF THE SWPPP.

7.4 SWPPP MODIFICATION:

THE CONTRACTOR SHALL MODIFY THE SWPPP AS NECESSARY TO:

- COMPLY WITH MINIMUM PERMIT REQUIREMENTS WHEN NOTIFIED BY FDEP. THAT THE PLAN DOES NOT COMPLY.
- ADDRESS ANY CHANGES IN DESIGN, CONSTRUCTION OPERATIONS OR MAINTENANCE, WHICH HAS AN EFFECT ON THE POTENTIAL FOR DISCHARGE OF POLLUTANTS.
- PREVENT REOCCURRENCE OF REPORTABLE QUANTITY RELEASES OF HAZARDOUS MATERIAL OR OIL.

8.0 TERMINATION CHECKLIST

THE FOLLOWING ITEMS SHALL BE COMPLETE BEFORE SUBMITTING THE NOT:

- ALL SOIL DISTURBING ACTIVITIES ARE COMPLETE. TEMPORARY EROSION AND SEDIMENT CONTROL MEASURES HAVE BEEN
- REMOVED OR WILL BE REMOVED AT AN APPROPRIATE TIME. ALL AREAS OF THE CONSTRUCTION SITE NOT OTHERWISE COVERED BY PERMANENT PAVEMENT OR STRUCTURE HAVE BEEN STABILIZED WITH UNIFORM PERENNIAL VEGETATIVE COVER WITH A DENSITY OF 70% OR EQUIVALENT MEASURES HAVE BEEN EMPLOYED.

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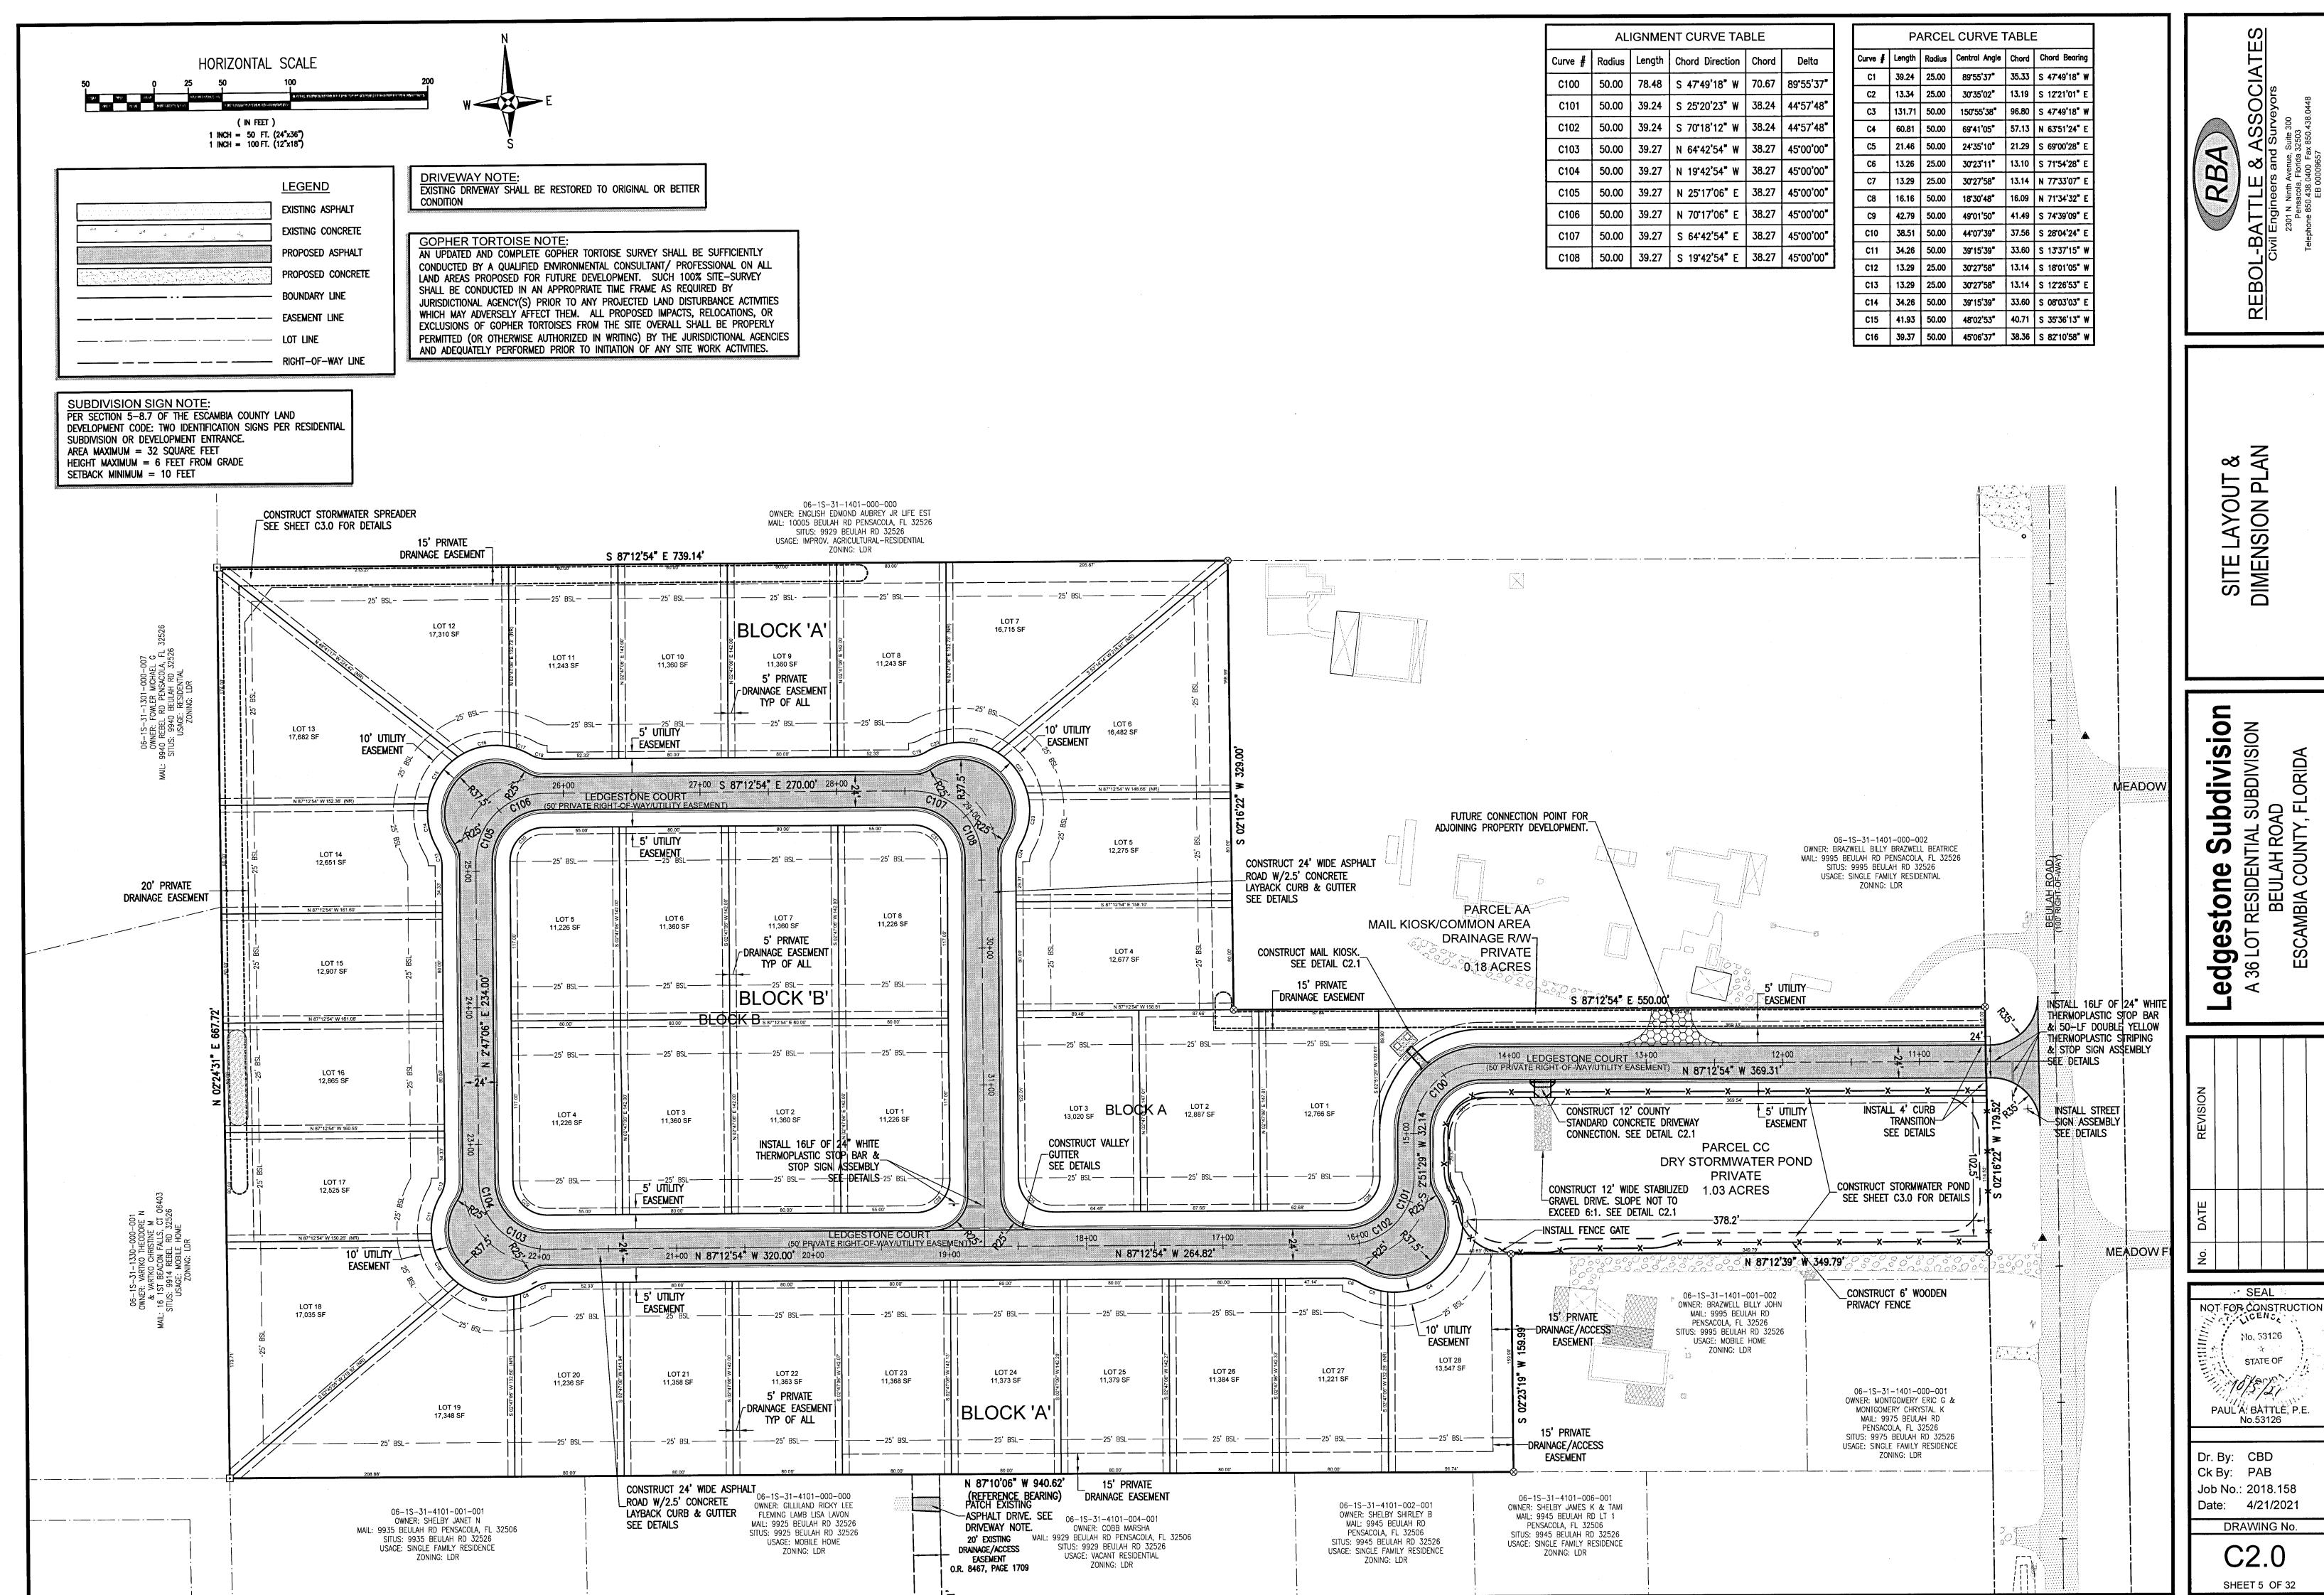
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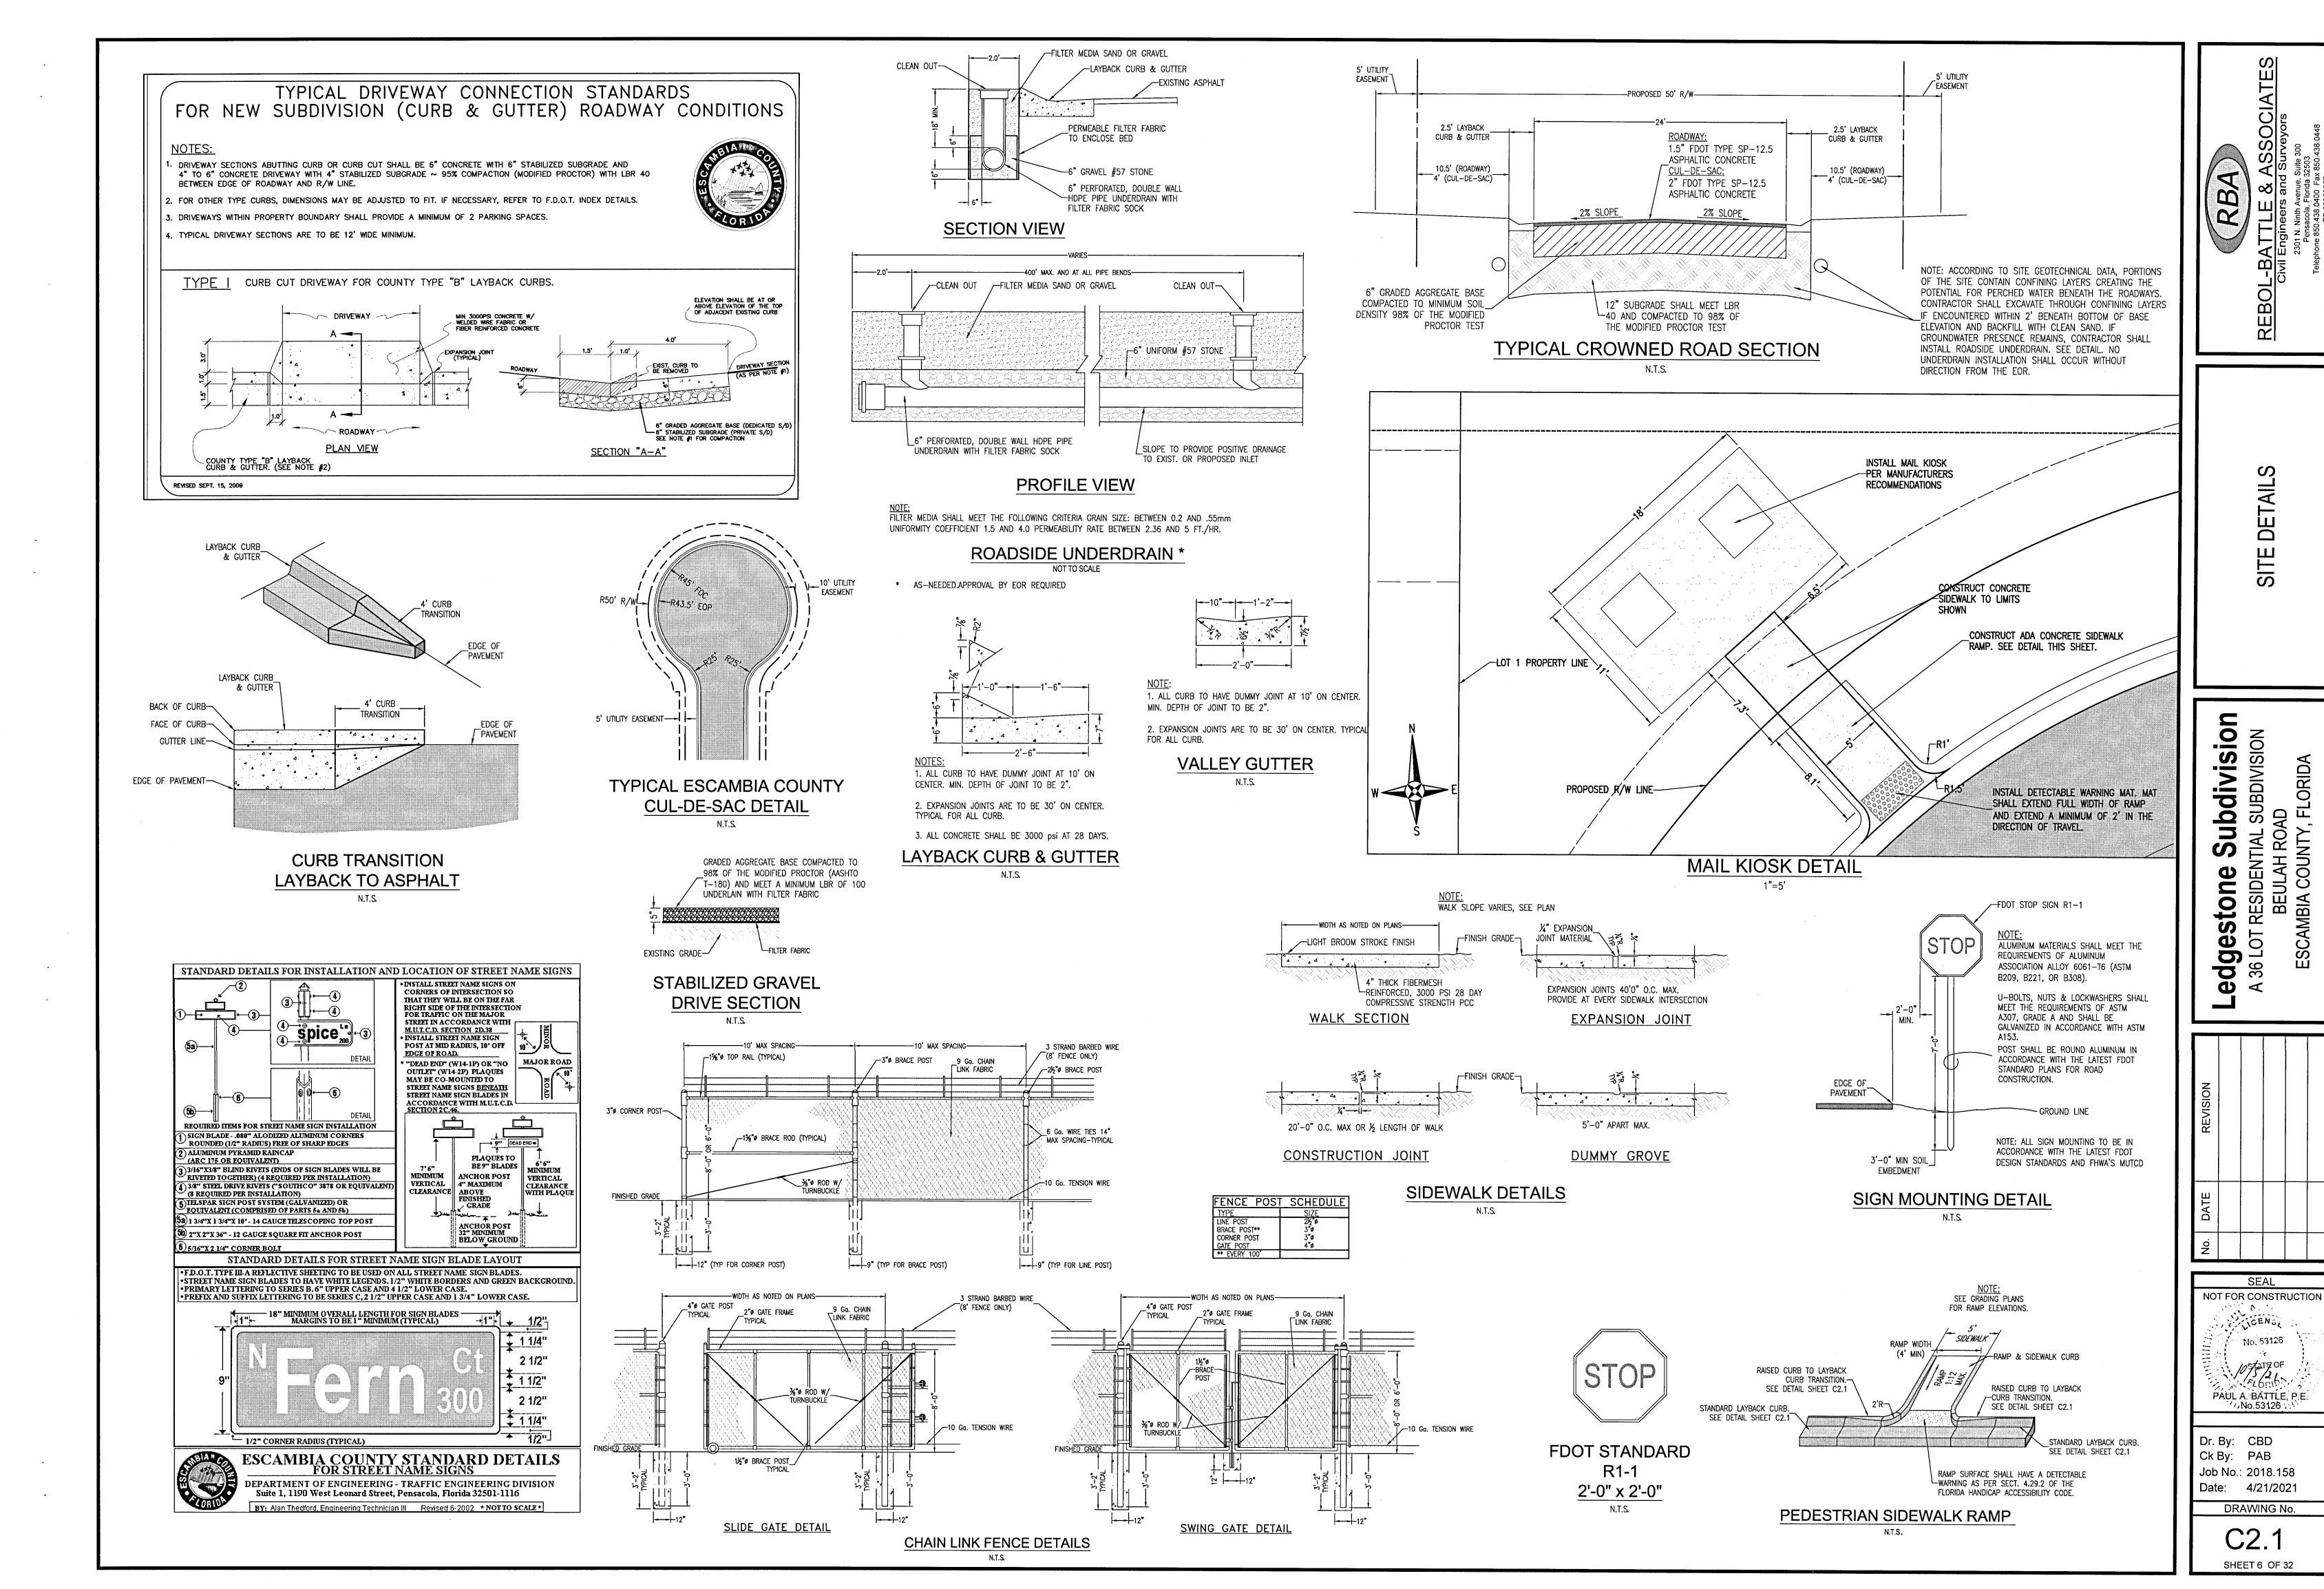
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STATEOF
10/5/26
PAUL A. BATTLE, P.E. No.53126
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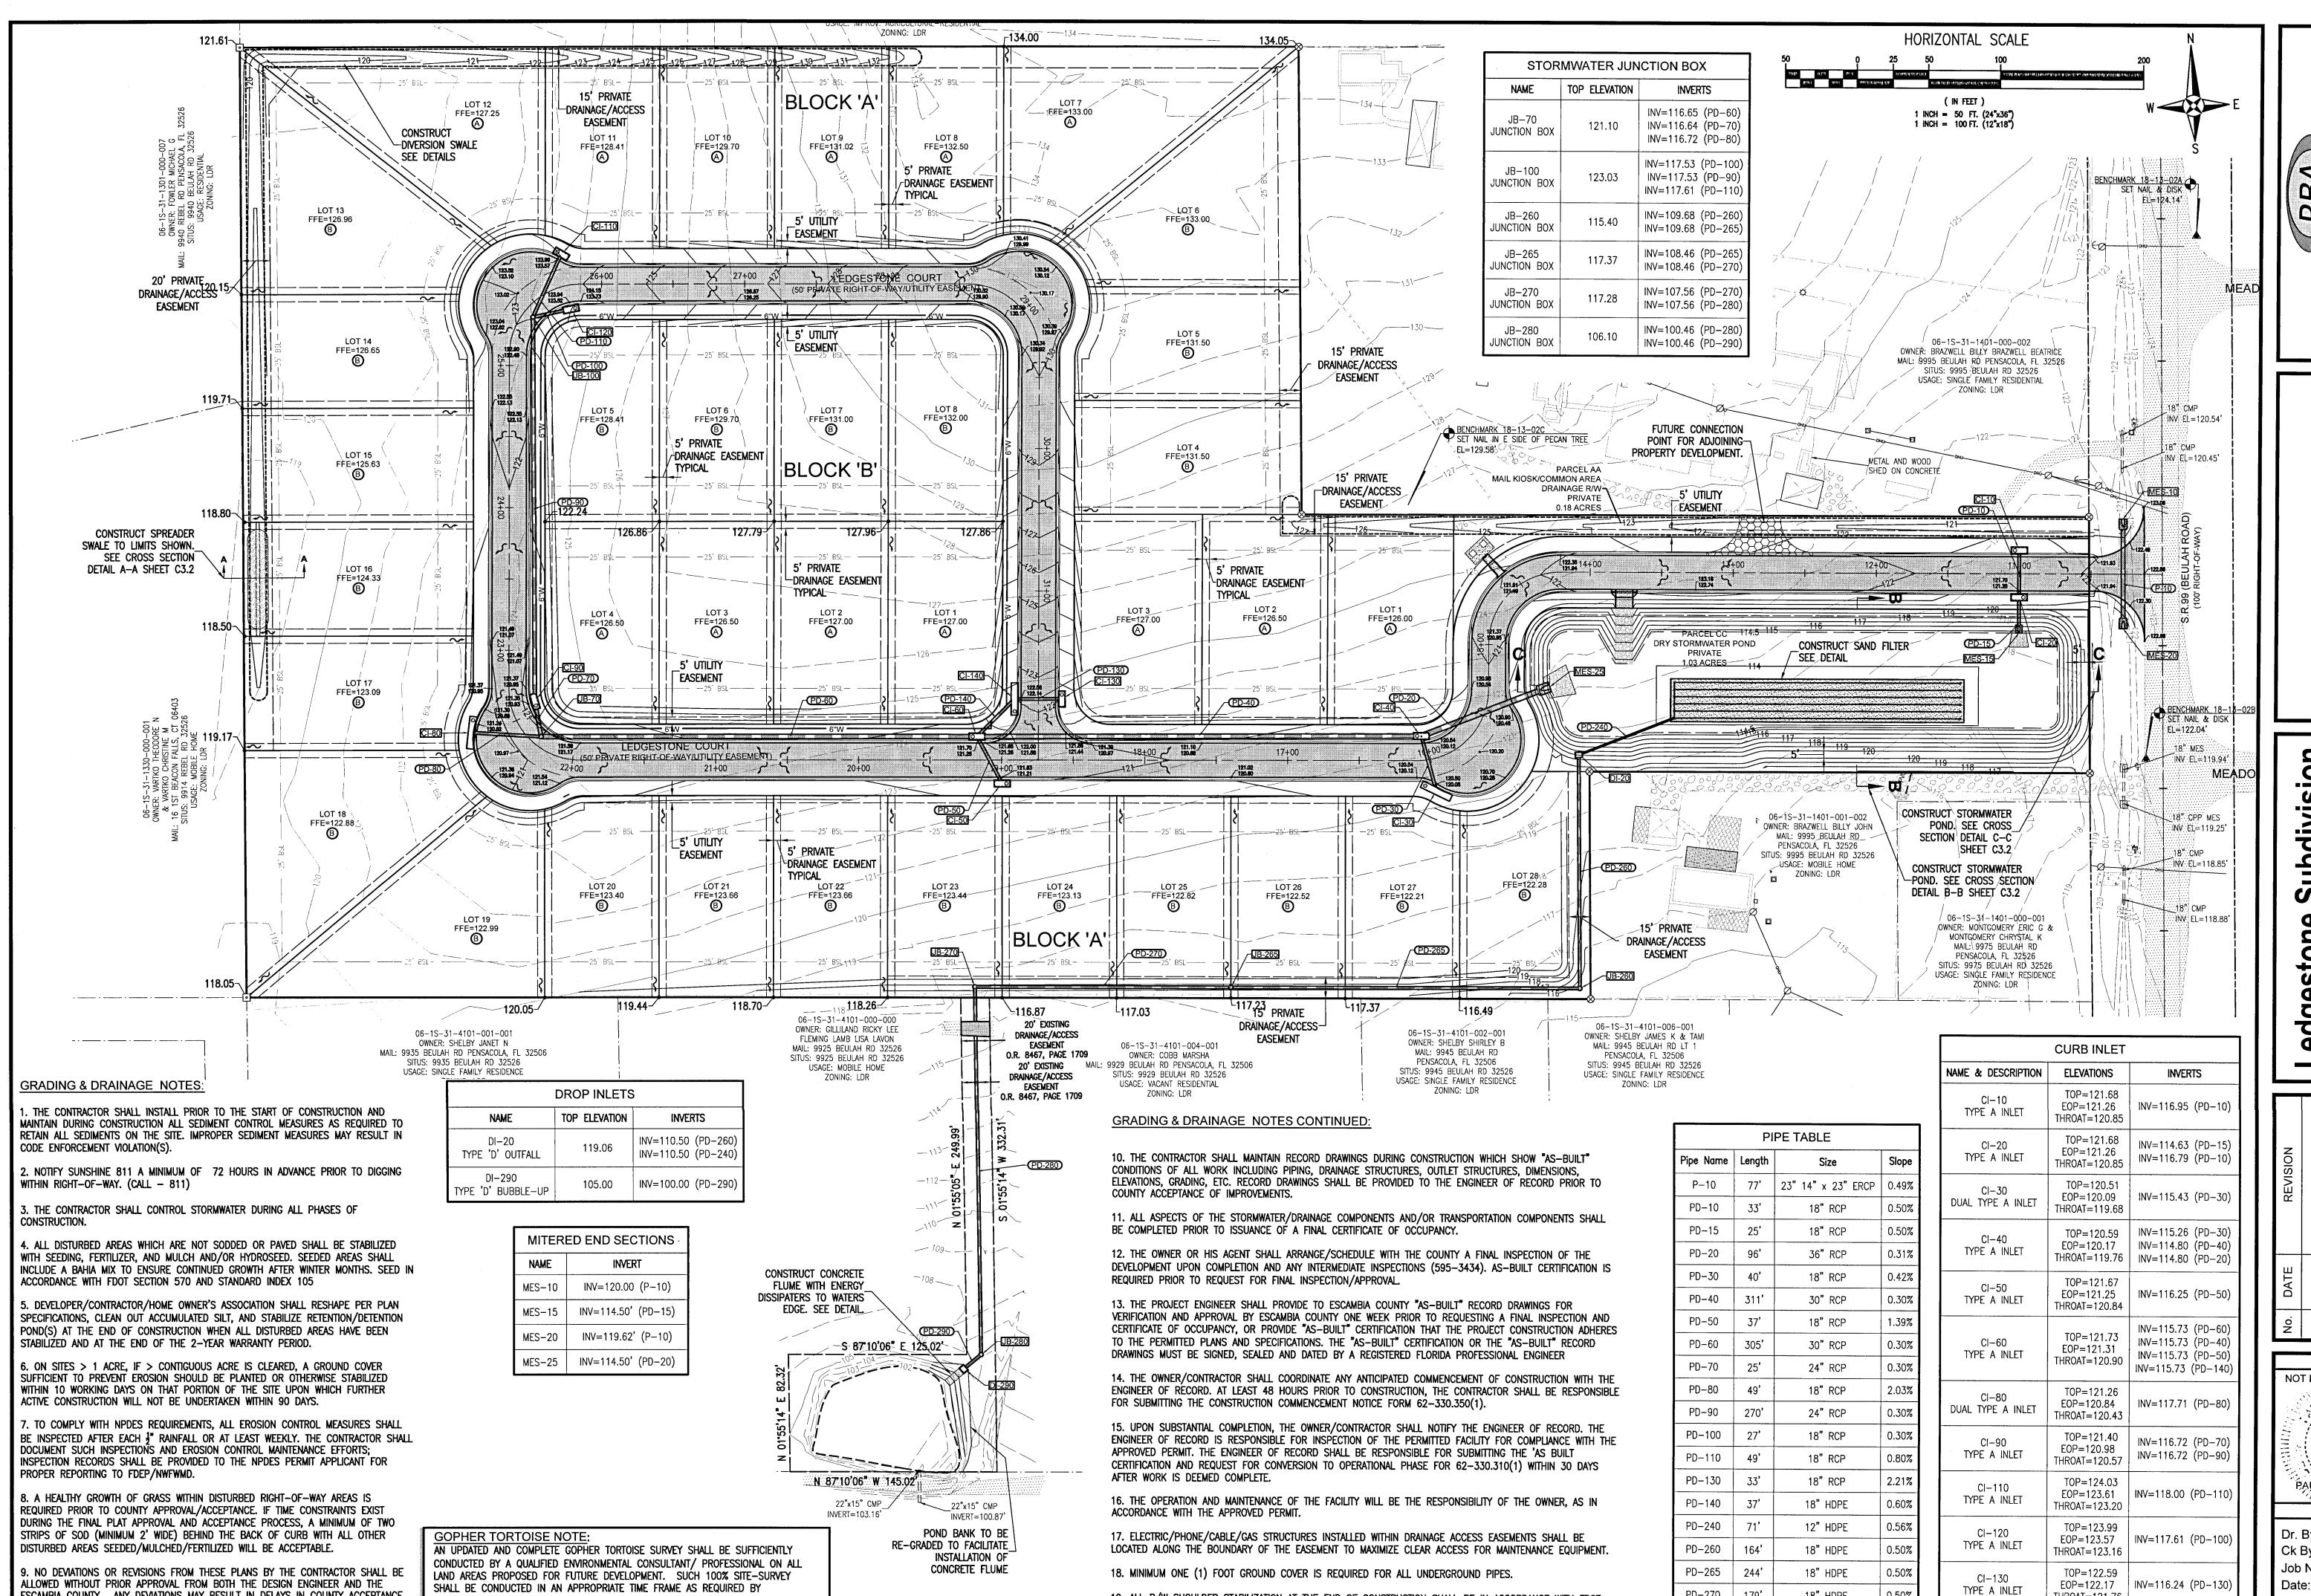
Dr. By: CBD Ck By: PAB Job No.: 2018.158 Date: 4/21/2021

DRAWING No.

SHEET 4 OF 32







19. ALL R/W SHOULDER STABILIZATION AT THE END OF CONSTRUCTION SHALL BE IN ACCORDANCE WITH FDOT

20. ALL STORMWATER RUNOFF GENERATED FROM IMPERVIOUS AREAS ON EACH INDIVIDUAL LOT MUST BE DIRECTED

TO THE STREET. FOR LOTS 13-28 BLOCK 'A' ALL IMPERVIOUS AREAS FROM LOTS MUST BE DIRECTED TO THE

STREET WITH PERVIOUS AREAS AT THE REAR ALLOWED TO DISCHARGE TOWARDS THE BACK OF THE PROPERTY.

STANDARD SPECIFICATIONS FOR ROAD AND BRIDGE CONSTRUCTION SECTION 160, LATEST EDITION

ESCAMBIA COUNTY. ANY DEVIATIONS MAY RESULT IN DELAYS IN COUNTY ACCEPTANCE

OF IMPROVEMENTS.

JURISDICTIONAL AGENCY(S) PRIOR TO ANY PROJECTED LAND DISTURBANCE ACTIVITIES

WHICH MAY ADVERSELY AFFECT THEM. ALL PROPOSED IMPACTS, RELOCATIONS, OR

EXCLUSIONS OF GOPHER TORTOISES FROM THE SITE OVERALL SHALL BE PROPERLY

AND ADEQUATELY PERFORMED PRIOR TO INITIATION OF ANY SITE WORK ACTIVITIES.

PERMITTED (OR OTHERWISE AUTHORIZED IN WRITING) BY THE JURISDICTIONAL AGENCIES

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SEAL NOT FOR CONSTRUCTION CENT No. 53126 PAUL A. BATTLE, P.E. Dr. By: CBD Ck By: PAB Job No.: 2018.158

Date: 4/21/2021 DRAWING No.

SHEET 7 OF 32

PD-270 | 179°

PD-280 | 257'

PD-290 | 16'

18" HDPE

18" HDPE

18" RCP

THROAT=121.76


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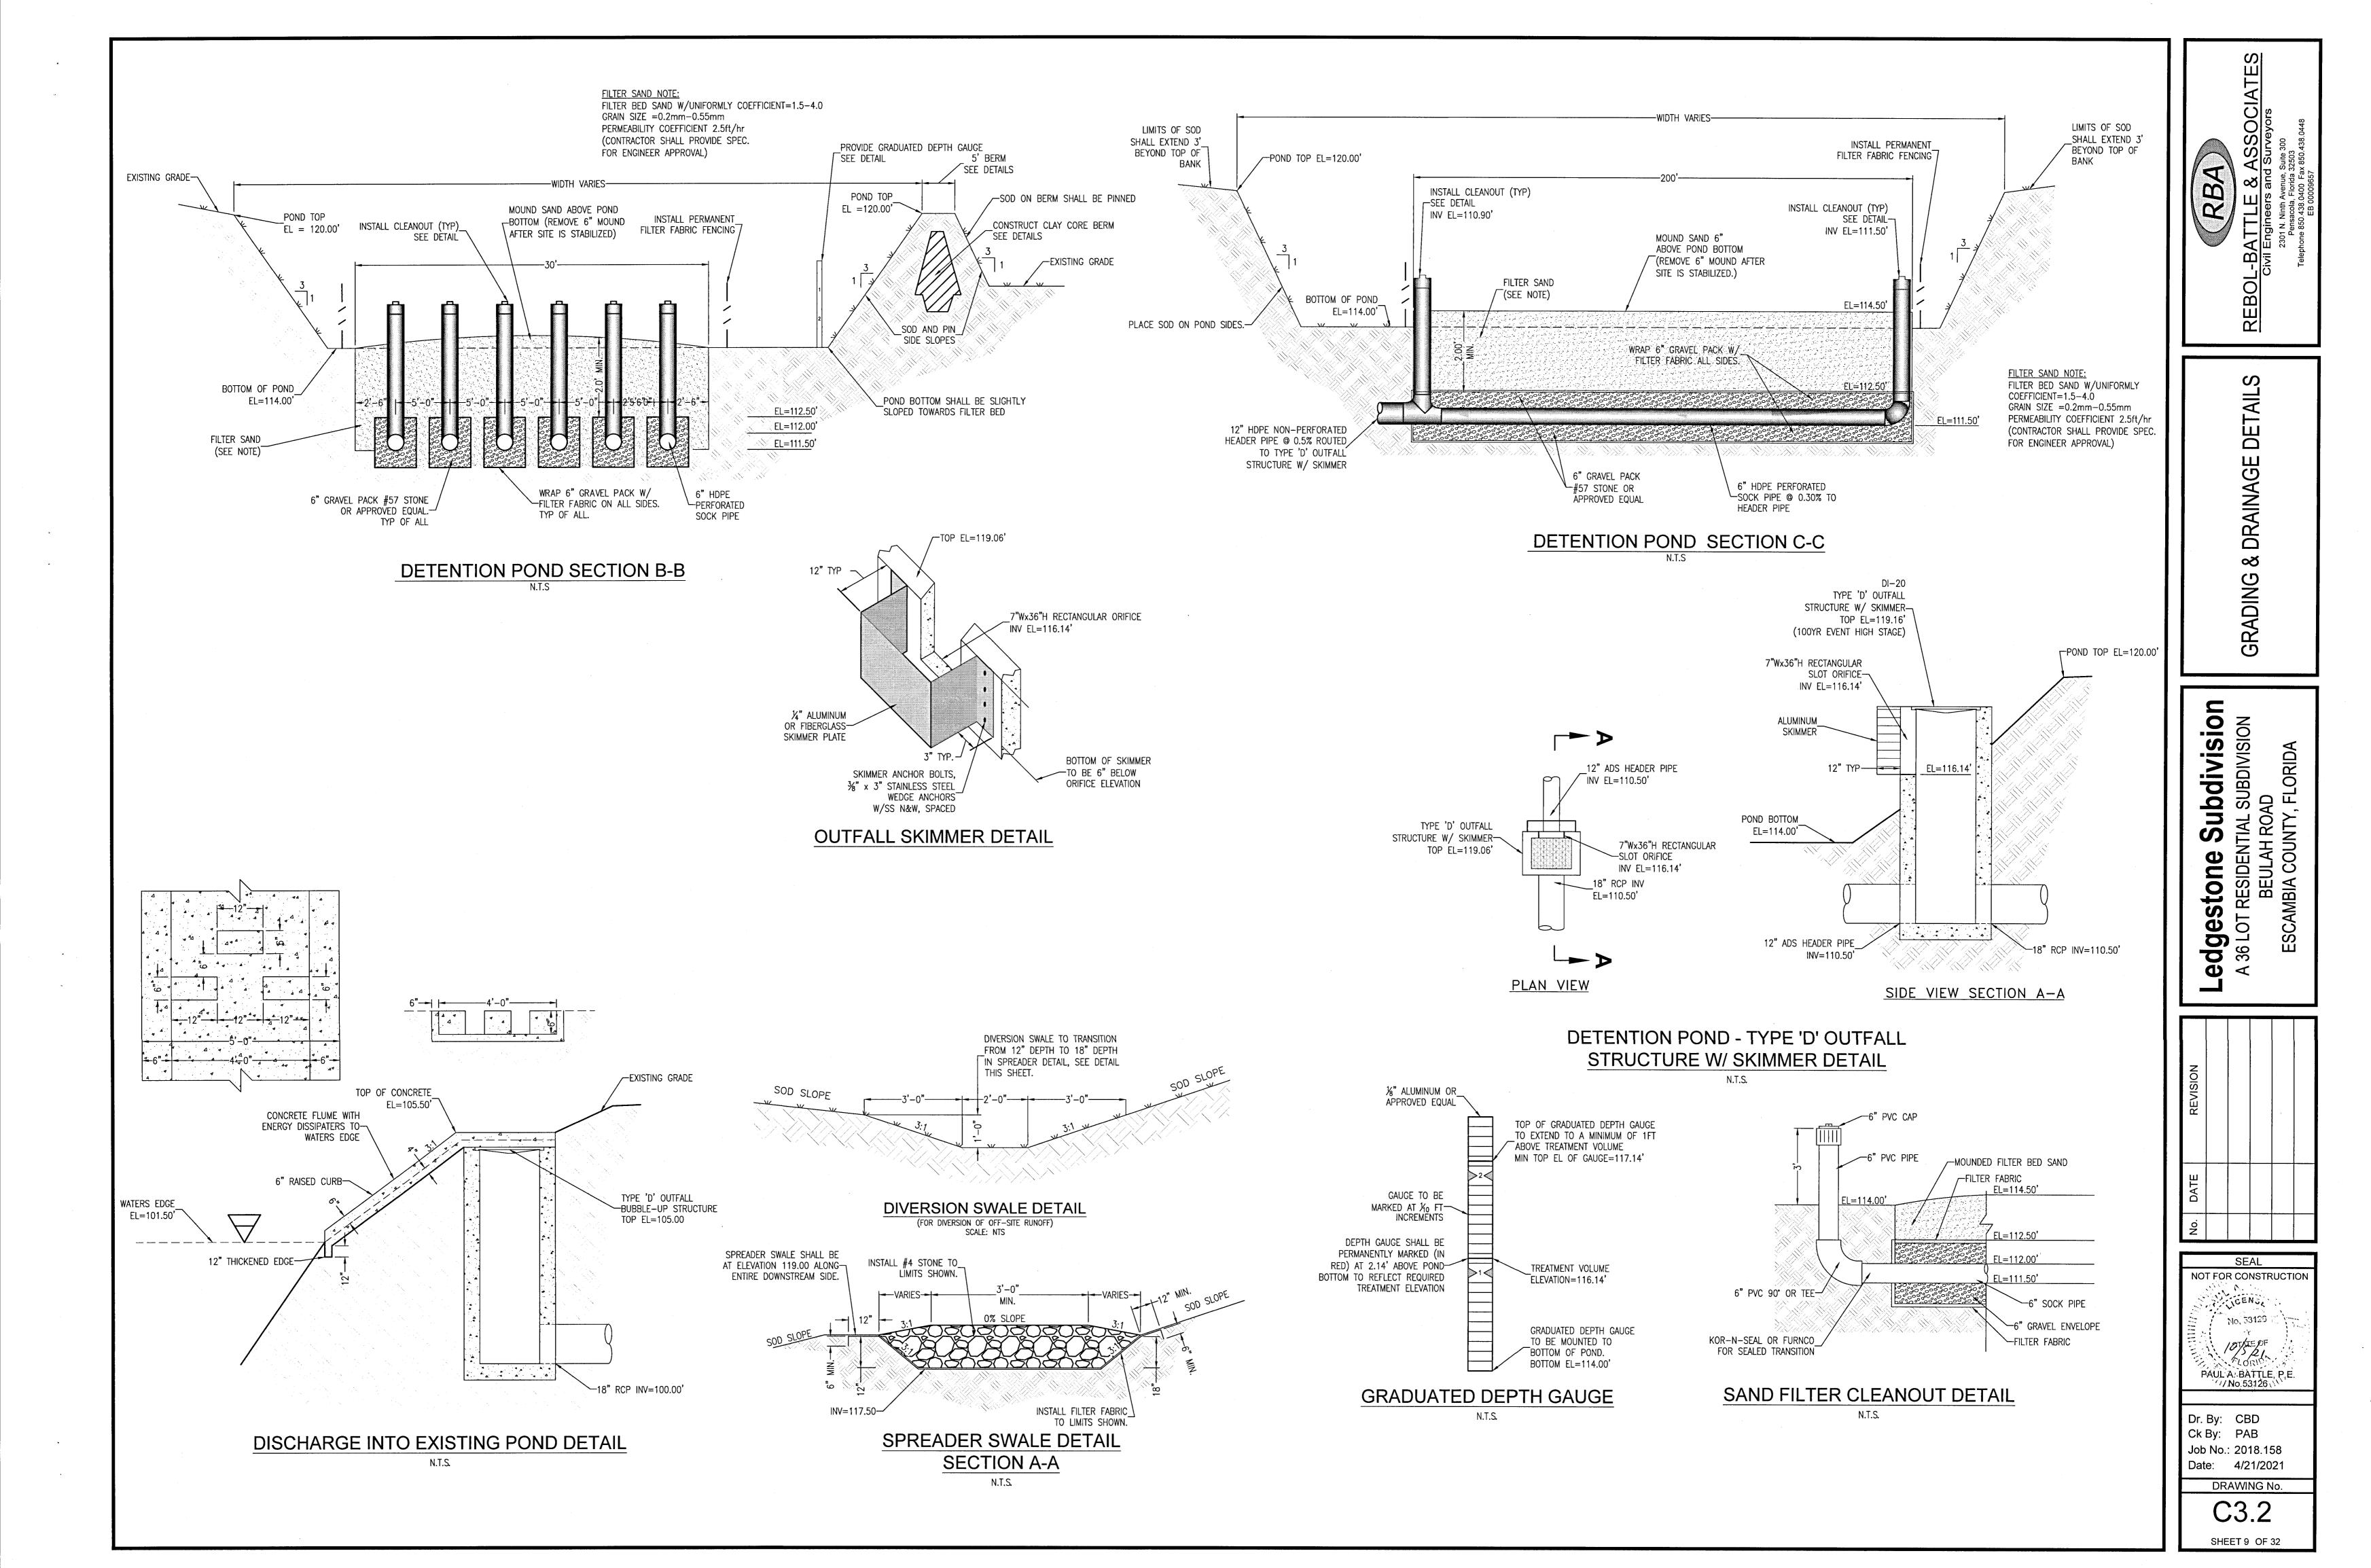
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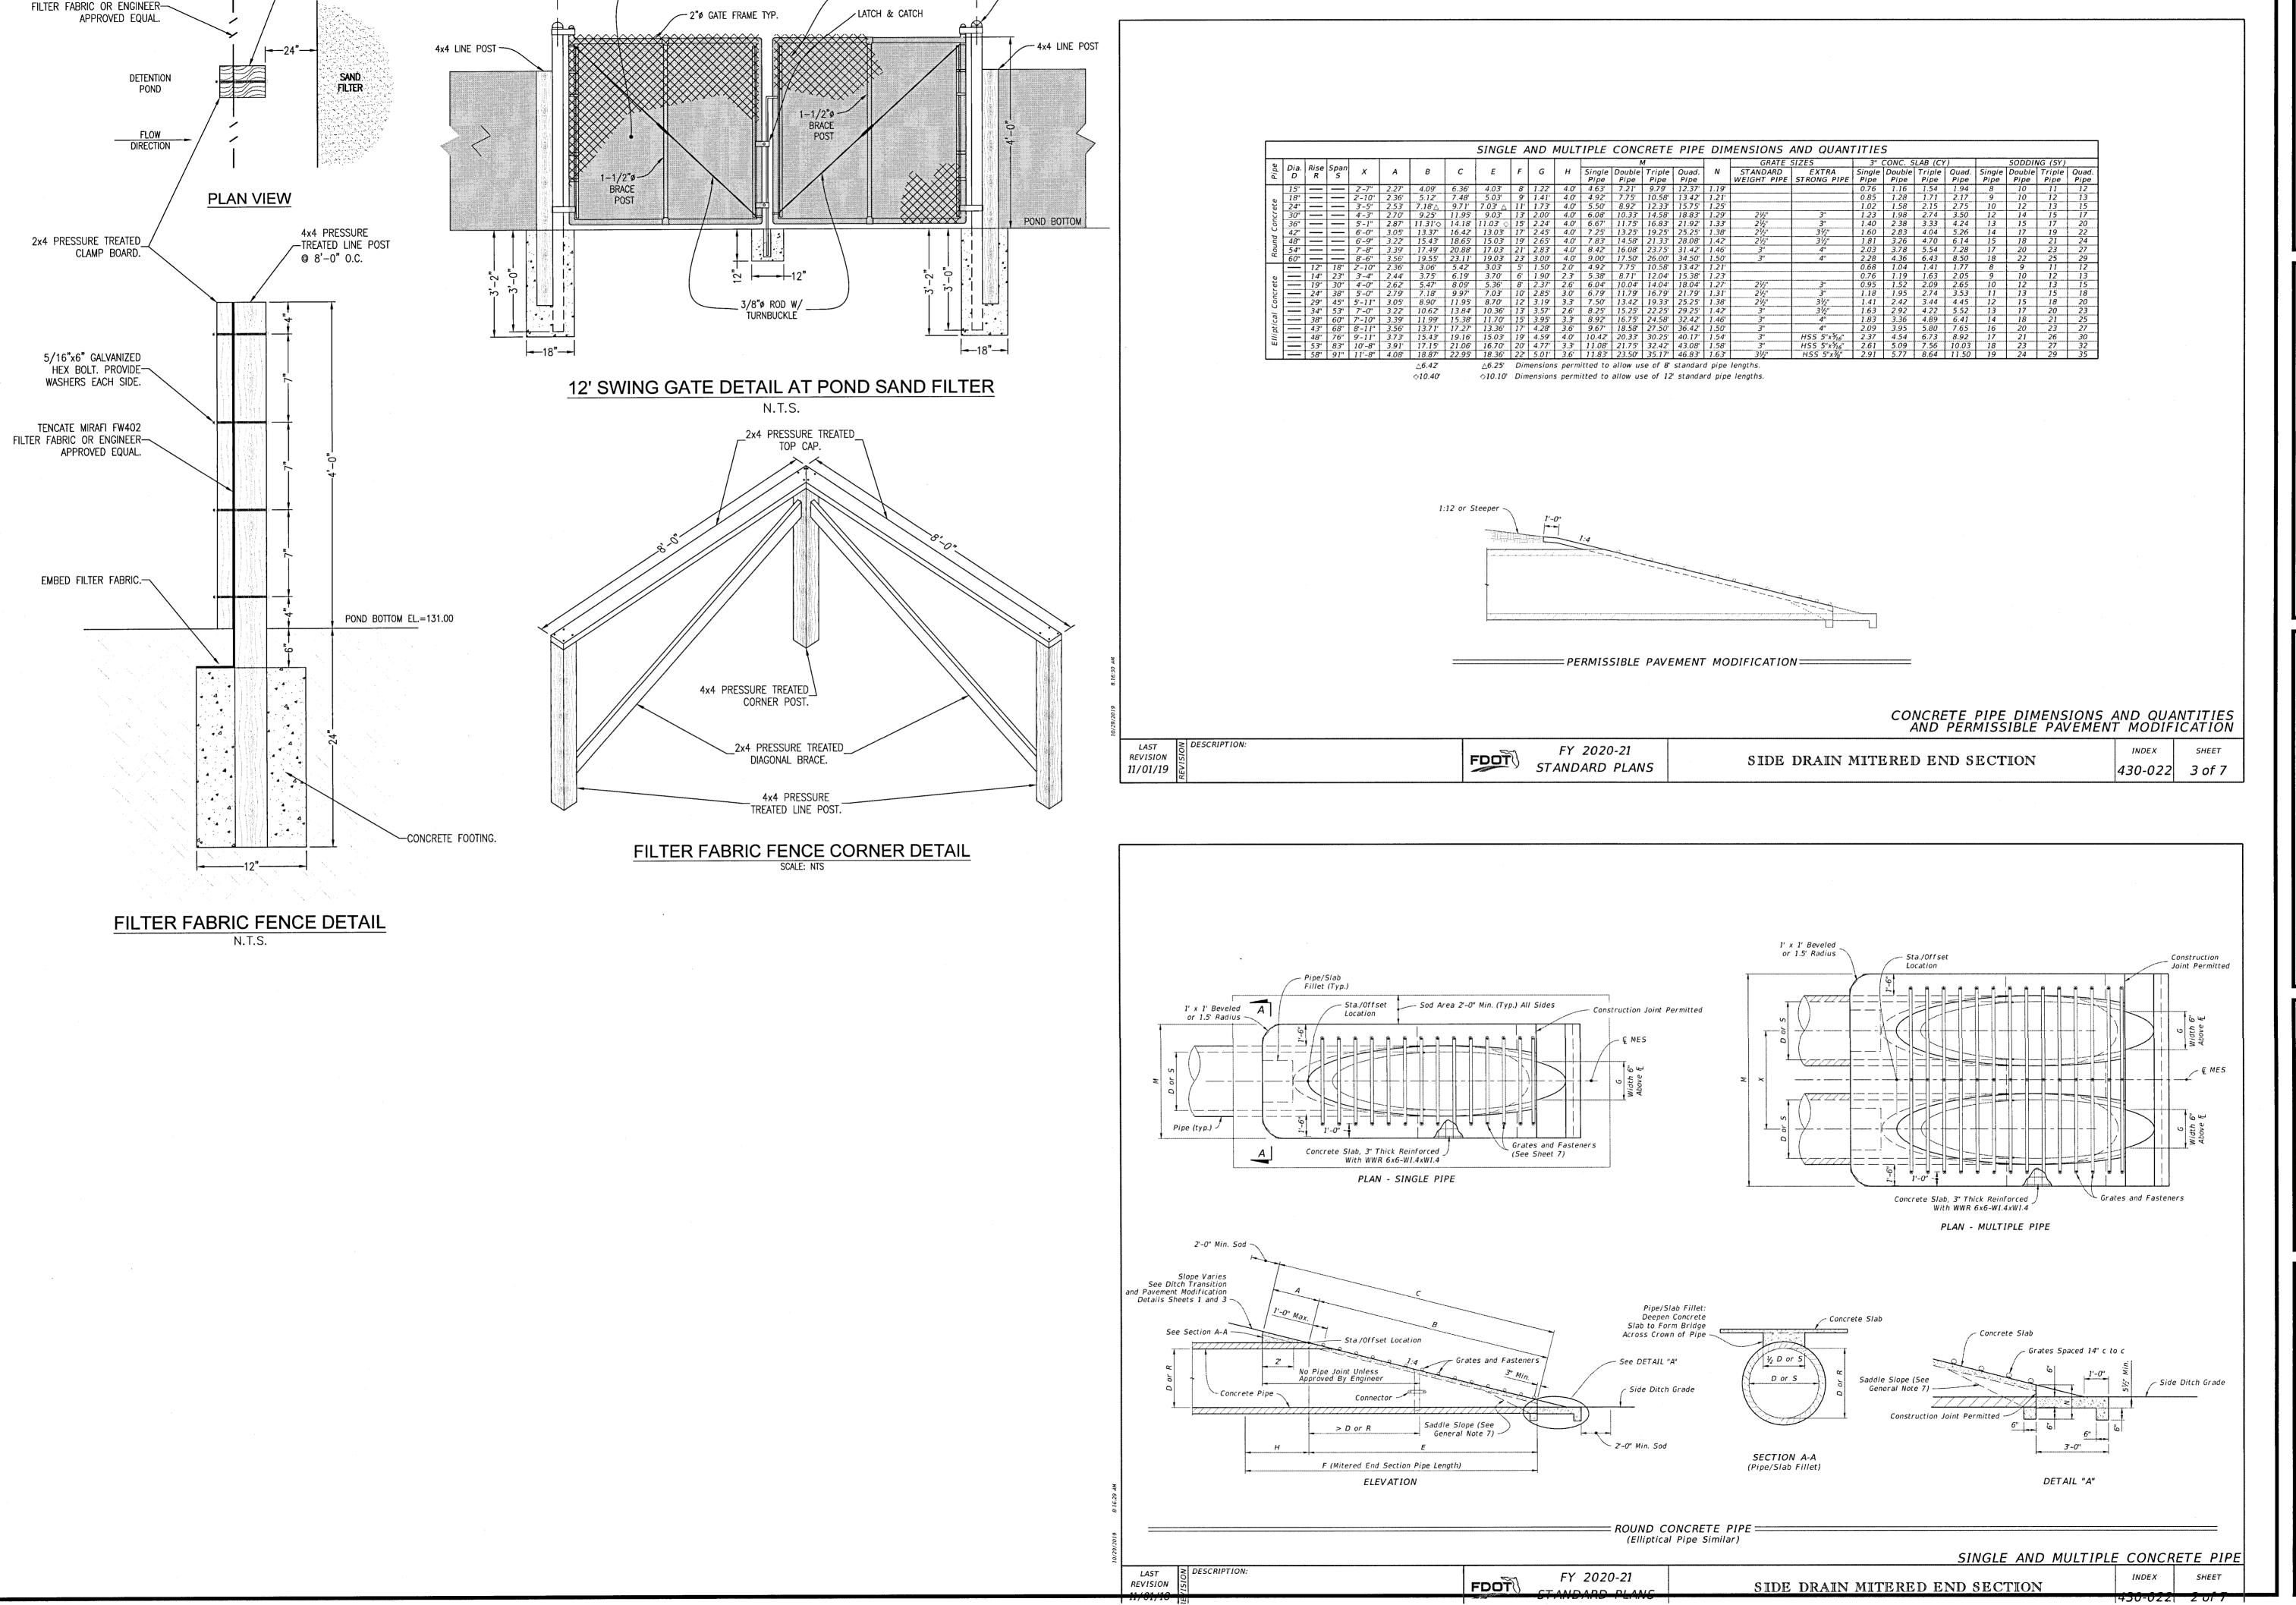
TOP=122.59

INV=115.51 (PD-140)

THROAT=121.76 | INV=115.51 (PD-130)





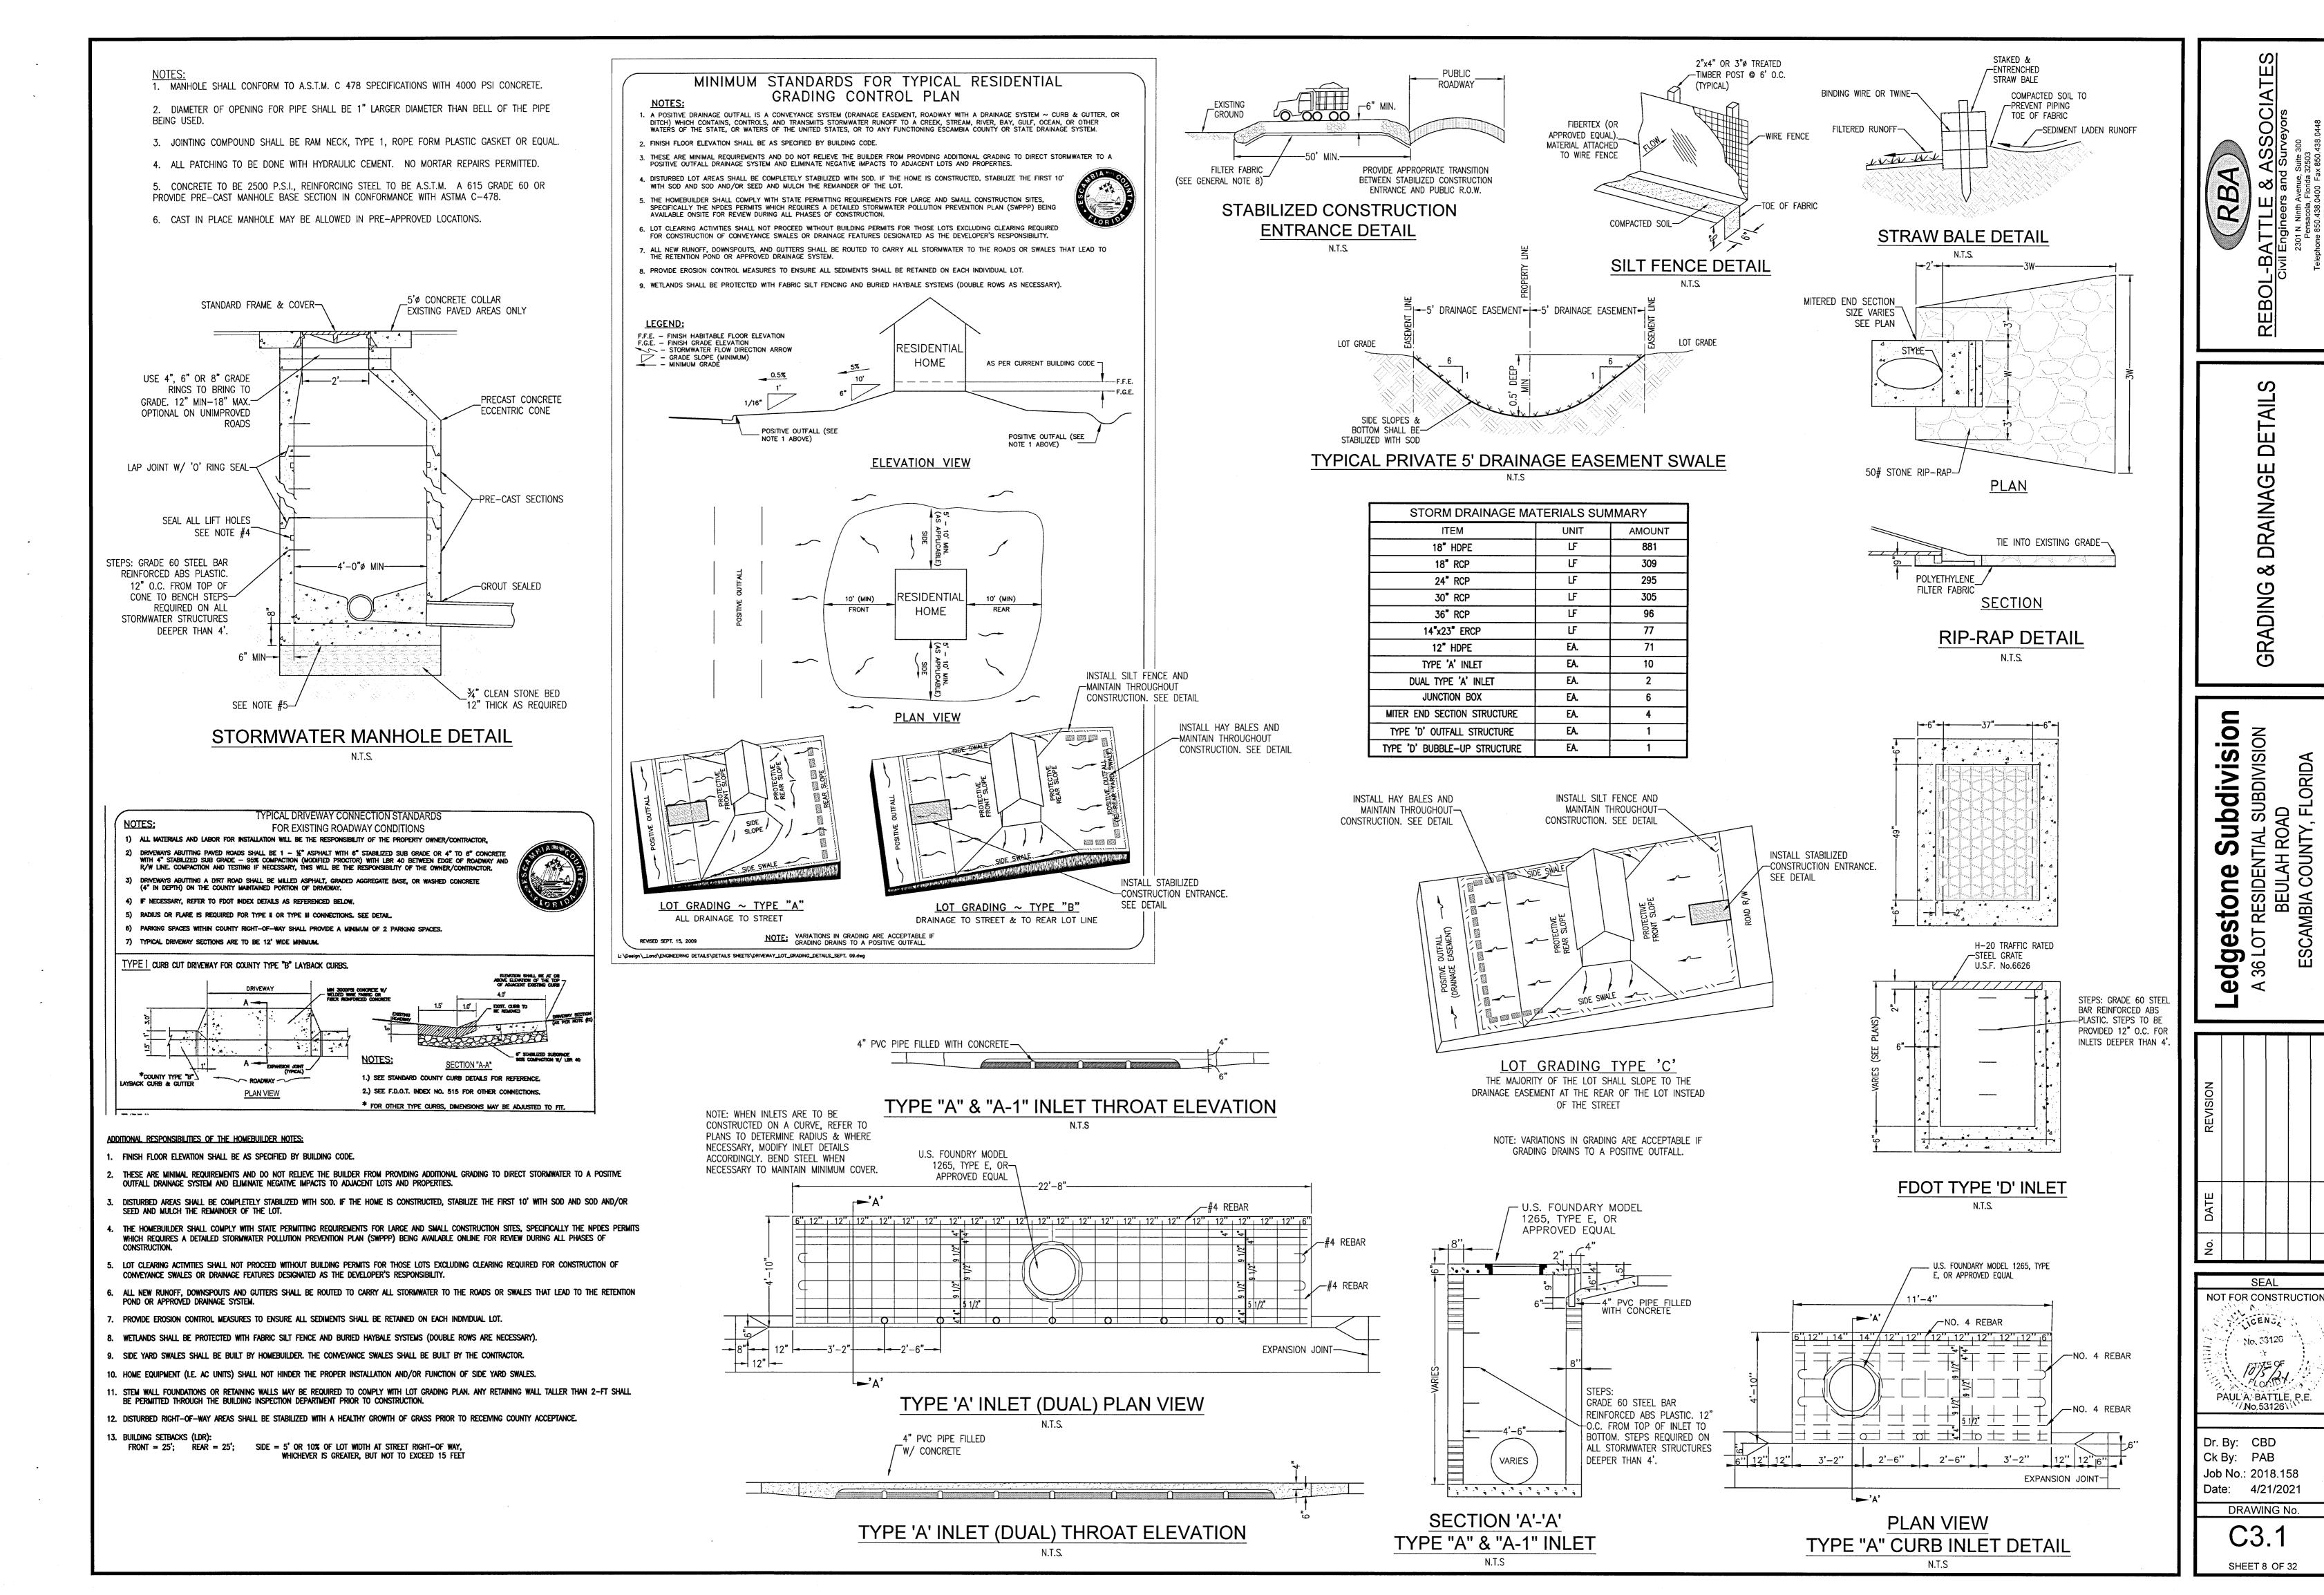

- 4"ø GATE POST TYP.

- 9 ga FENCE FABRIC


4x4 PRESSURE -TREATED LINE POST

@ 8'-0" O.C..

TENCATE MIRAFI FW402

COVER AND SECURE FILTER FABRIC

TO GATES WITH HEAVY DUTY ZIP TIES.

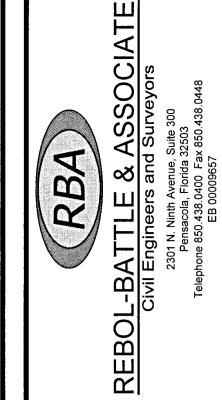

H. DRAINAGE **ං**୪ GRADING


ubdivision AL SUBDIVISION edgestone Su
A 36 LOT RESIDENTIAL
BEULAH RO,
ESCAMBIA COUNTY

SEAL NOT FOR CONSTRUCTION CENO No. 53126 STATE OF PAULA/BATTLE, P.E. No.53126

Dr. By: CBD Ck By: PAB Job No.: 2018.158 Date: 4/21/2021

DRAWING No.

C3.3 SHEET 10 OF 32

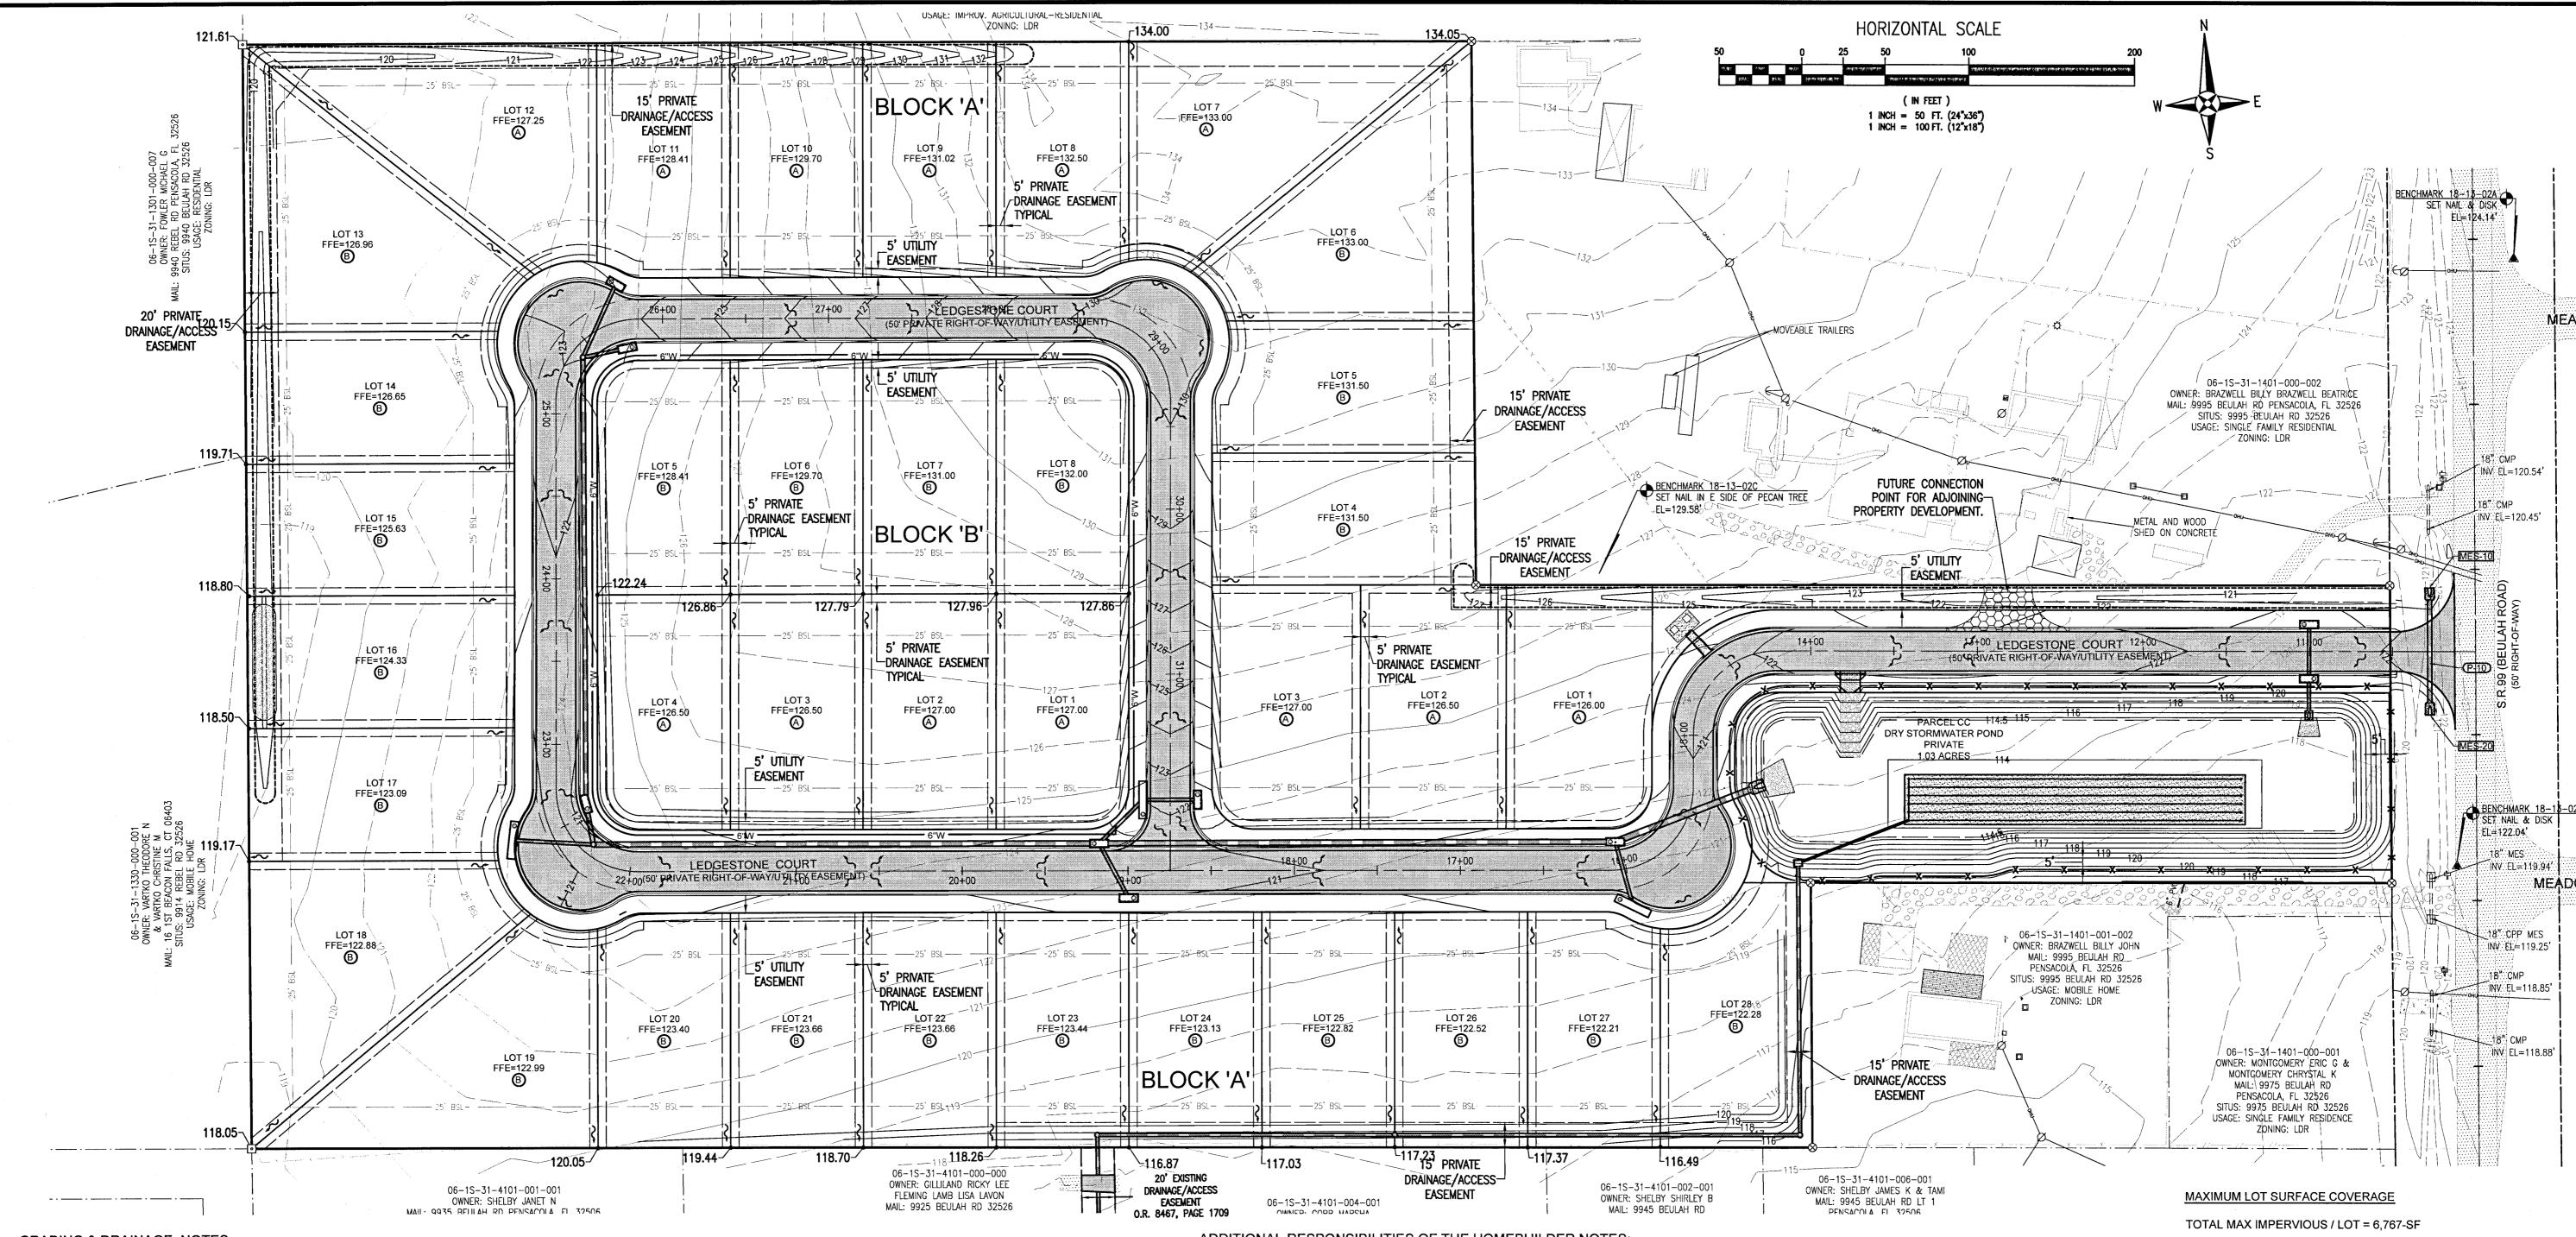

GRADING & DRAINAGE NOTES:

- 1. THE CONTRACTOR SHALL INSTALL PRIOR TO THE START OF CONSTRUCTION AND MAINTAIN DURING CONSTRUCTION ALL SEDIMENT CONTROL MEASURES AS REQUIRED TO RETAIN ALL SEDIMENTS ON THE SITE. IMPROPER SEDIMENT MEASURES MAY RESULT IN CODE ENFORCEMENT VIOLATION(S).
- 2. NOTIFY SUNSHINE 811 A MINIMUM OF 72 HOURS IN ADVANCE PRIOR TO DIGGING WITHIN RIGHT-OF-WAY. (CALL - 811)
- 3. THE CONTRACTOR SHALL CONTROL STORMWATER DURING ALL PHASES OF CONSTRUCTION.
- 4. ALL DISTURBED AREAS WHICH ARE NOT SODDED OR PAVED SHALL BE STABILIZED WITH SEEDING, FERTILIZER, AND MULCH AND/OR HYDROSEED. SEEDED AREAS SHALL INCLUDE A BAHIA MIX TO ENSURE CONTINUED GROWTH AFTER WINTER MONTHS. SEED IN ACCORDANCE WITH FDOT SECTION 570 AND STANDARD INDEX 105
- 5. DEVELOPER/CONTRACTOR/HOME OWNER'S ASSOCIATION SHALL RESHAPE PER PLAN SPECIFICATIONS, CLEAN OUT ACCUMULATED SILT, AND STABILIZE RETENTION/DETENTION POND(S) AT THE END OF CONSTRUCTION WHEN ALL DISTURBED AREAS HAVE BEEN STABILIZED AND AT THE END OF THE 2-YEAR WARRANTY PERIOD.
- 6. ON SITES > 1 ACRE, IF > CONTIGUOUS ACRE IS CLEARED, A GROUND COVER SUFFICIENT TO PREVENT EROSION SHOULD BE PLANTED OR OTHERWISE STABILIZED WITHIN 10 WORKING DAYS ON THAT PORTION OF THE SITE UPON WHICH FURTHER ACTIVE CONSTRUCTION WILL NOT BE UNDERTAKEN WITHIN 90 DAYS.
- 7. TO COMPLY WITH NPDES REQUIREMENTS, ALL EROSION CONTROL MEASURES SHALL BE INSPECTED AFTER EACH 3" RAINFALL OR AT LEAST WEEKLY. THE CONTRACTOR SHALL DOCUMENT SUCH INSPECTIONS AND EROSION CONTROL MAINTENANCE EFFORTS; INSPECTION RECORDS SHALL BE PROVIDED TO THE NPDES PERMIT APPLICANT FOR PROPER REPORTING TO FDEP/NWFWMD.
- 8. A HEALTHY GROWTH OF GRASS WITHIN DISTURBED RIGHT-OF-WAY AREAS IS REQUIRED PRIOR TO COUNTY APPROVAL/ACCEPTANCE. IF TIME CONSTRAINTS EXIST DURING THE FINAL PLAT APPROVAL AND ACCEPTANCE PROCESS, A MINIMUM OF TWO STRIPS OF SOD (MINIMUM 2' WIDE) BEHIND THE BACK OF CURB WITH ALL OTHER DISTURBED AREAS SEEDED/MULCHED/FERTILIZED WILL BE ACCEPTABLE.
- 9. NO DEVIATIONS OR REVISIONS FROM THESE PLANS BY THE CONTRACTOR SHALL BE ALLOWED WITHOUT PRIOR APPROVAL FROM BOTH THE DESIGN ENGINEER AND THE ESCAMBIA COUNTY. ANY DEVIATIONS MAY RESULT IN DELAYS IN COUNTY ACCEPTANCE OF IMPROVEMENTS.

- 10. THE CONTRACTOR SHALL MAINTAIN RECORD DRAWINGS DURING CONSTRUCTION WHICH SHOW "AS-BUILT" CONDITIONS OF ALL WORK INCLUDING PIPING, DRAINAGE STRUCTURES, OUTLET STRUCTURES, DIMENSIONS, ELEVATIONS, GRADING, ETC. RECORD DRAWINGS SHALL BE PROVIDED TO THE ENGINEER OF RECORD PRIOR TO COUNTY ACCEPTANCE OF IMPROVEMENTS.
- 11. ALL ASPECTS OF THE STORMWATER/DRAINAGE COMPONENTS AND/OR TRANSPORTATION COMPONENTS SHALL BE COMPLETED PRIOR TO ISSUANCE OF A FINAL CERTIFICATE OF OCCUPANCY.
- 12. THE OWNER OR HIS AGENT SHALL ARRANGE/SCHEDULE WITH THE COUNTY A FINAL INSPECTION OF THE DEVELOPMENT UPON COMPLETION AND ANY INTERMEDIATE INSPECTIONS (595-3434). AS-BUILT CERTIFICATION IS REQUIRED PRIOR TO REQUEST FOR FINAL INSPECTION/APPROVAL.
- 13. THE PROJECT ENGINEER SHALL PROVIDE TO ESCAMBIA COUNTY "AS-BUILT" RECORD DRAWINGS FOR VERIFICATION AND APPROVAL BY ESCAMBIA COUNTY ONE WEEK PRIOR TO REQUESTING A FINAL INSPECTION AND CERTIFICATE OF OCCUPANCY, OR PROVIDE "AS-BUILT" CERTIFICATION THAT THE PROJECT CONSTRUCTION ADHERES TO THE PERMITTED PLANS AND SPECIFICATIONS. THE "AS-BUILT" CERTIFICATION OR THE "AS-BUILT" RECORD DRAWINGS MUST BE SIGNED, SEALED AND DATED BY A REGISTERED FLORIDA PROFESSIONAL ENGINEER
- 14. THE OWNER/CONTRACTOR SHALL COORDINATE ANY ANTICIPATED COMMENCEMENT OF CONSTRUCTION WITH THE ENGINEER OF RECORD. AT LEAST 48 HOURS PRIOR TO CONSTRUCTION, THE CONTRACTOR SHALL BE RESPONSIBLE FOR SUBMITTING THE CONSTRUCTION COMMENCEMENT NOTICE FORM 62-330.350(1).
- 15. UPON SUBSTANTIAL COMPLETION, THE OWNER/CONTRACTOR SHALL NOTIFY THE ENGINEER OF RECORD. THE ENGINEER OF RECORD IS RESPONSIBLE FOR INSPECTION OF THE PERMITTED FACILITY FOR COMPLIANCE WITH THE APPROVED PERMIT. THE ENGINEER OF RECORD SHALL BE RESPONSIBLE FOR SUBMITTING THE 'AS BUILT CERTIFICATION AND REQUEST FOR CONVERSION TO OPERATIONAL PHASE FOR 62-330.310(1) WITHIN 30 DAYS AFTER WORK IS DEEMED COMPLETE.
- 16. THE OPERATION AND MAINTENANCE OF THE FACILITY WILL BE THE RESPONSIBILITY OF THE OWNER, AS IN ACCORDANCE WITH THE APPROVED PERMIT.
- 17. ELECTRIC/PHONE/CABLE/GAS STRUCTURES INSTALLED WITHIN DRAINAGE ACCESS EASEMENTS SHALL BE LOCATED ALONG THE BOUNDARY OF THE EASEMENT TO MAXIMIZE CLEAR ACCESS FOR MAINTENANCE EQUIPMENT.
- 18. MINIMUM ONE (1) FOOT GROUND COVER IS REQUIRED FOR ALL UNDERGROUND PIPES.
- 19. ALL R/W SHOULDER STABILIZATION AT THE END OF CONSTRUCTION SHALL BE IN ACCORDANCE WITH FDOT STANDARD SPECIFICATIONS FOR ROAD AND BRIDGE CONSTRUCTION SECTION 160, LATEST EDITION
- 20. ALL STORMWATER RUNOFF GENERATED FROM IMPERVIOUS AREAS ON EACH INDIVIDUAL LOT MUST BE DIRECTED TO THE STREET. FOR LOTS 13-28 BLOCK 'A' ALL IMPERVIOUS AREAS FROM LOTS MUST BE DIRECTED TO THE STREET WITH PERVIOUS AREAS AT THE REAR ALLOWED TO DISCHARGE TOWARDS THE BACK OF THE PROPERTY.

ADDITIONAL RESPONSIBILITIES OF THE HOMEBUILDER NOTES:

- 1. FINISH FLOOR ELEVATION SHALL BE AS SPECIFIED BY BUILDING CODE.
- 2. THESE ARE MINIMAL REQUIREMENTS AND DO NOT RELIEVE THE BUILDER FROM PROVIDING ADDITIONAL GRADING TO DIRECT STORMWATER TO A POSITIVE OUTFALL DRAINAGE SYSTEM AND ELIMINATE NEGATIVE IMPACTS TO ADJACENT LOTS AND
- 3. DISTURBED AREAS SHALL BE COMPLETELY STABILIZED WITH SOD. IF THE HOME IS CONSTRUCTED, STABILIZE THE FIRST 10' WITH SOD AND SOD AND/OR SEED AND MULCH THE REMAINDER OF THE LOT.
- 4. THE HOMEBUILDER SHALL COMPLY WITH STATE PERMITTING REQUIREMENTS FOR LARGE AND SMALL CONSTRUCTION SITES, SPECIFICALLY THE NPDES PERMITS WHICH REQUIRES A DETAILED STORMWATER POLLUTION PREVENTION PLAN (SWPPP) BEING AVAILABLE ONLINE FOR REVIEW DURING ALL PHASES OF CONSTRUCTION.
- 5. LOT CLEARING ACTIVITIES SHALL NOT PROCEED WITHOUT BUILDING PERMITS FOR THOSE LOTS EXCLUDING CLEARING REQUIRED FOR CONSTRUCTION OF CONVEYANCE SWALES OR DRAINAGE FEATURES DESIGNATED AS THE DEVELOPER'S responsibility.
- 6. ALL NEW RUNOFF, DOWNSPOUTS AND GUTTERS SHALL BE ROUTED TO CARRY ALL STORMWATER TO THE ROADS OR SWALES THAT LEAD TO THE RETENTION POND OR APPROVED DRAINAGE SYSTEM.
- 7. PROVIDE EROSION CONTROL MEASURES TO ENSURE ALL SEDIMENTS SHALL BE RETAINED ON EACH INDIVIDUAL LOT.
- 8. WETLANDS SHALL BE PROTECTED WITH FABRIC SILT FENCE AND BURIED HAYBALE SYSTEMS (DOUBLE ROWS ARE NECESSARY).
- 9. FENCES SHALL NOT IMPEDE STORMWATER FLOWS.
- 10. SIDE YARD SWALES SHALL BE BUILT BY HOMEBUILDER. THE CONVEYANCE SWALES SHALL BE BUILT BY THE CONTRACTOR.
- 11. HOME EQUIPMENT (I.E. AC UNITS) SHALL NOT HINDER THE PROPER INSTALLATION AND/OR FUNCTION OF SIDE YARD
- 12. STEM WALL FOUNDATIONS OR RETAINING WALLS MAY BE REQUIRED TO COMPLY WITH LOT GRADING PLAN. ANY RETAINING WALL TALLER THAN 2-FT SHALL BE PERMITTED THROUGH THE BUILDING INSPECTION DEPARTMENT PRIOR TO CONSTRUCTION.
- 13. DISTURBED RIGHT-OF-WAY AREAS SHALL BE STABILIZED WITH A HEALTHY GROWTH OF GRASS PRIOR TO RECEIVING COUNTY ACCEPTANCE.
- 14. BUILDING SETBACKS (LDR): FRONT = 25'; REAR = 25'; SIDE = 5' OR 10% OF LOT WIDTH AT STREET RIGHT-OF WAY, WHICHEVER IS GREATER, BUT NOT TO EXCEED 15 FEET

TOTAL IMPERVIOUS SURFACE

IMPERVIOUS SURFACE AREA / LOT (MAXIMUM) = 6,767-SF NUMBER OF LOTS = 36, TOTAL LOT IMPERVIOUS = 243,612-SF

TOTAL NEW INFRASTRUCTURE:

PAVEMENT w/ CURB AND GUTTER =70,382-SF

TOTAL PROPOSED IMPERVIOUS SURFACE = 313,994-SF

GOPHER TORTOISE NOTE:

AN UPDATED AND COMPLETE GOPHER TORTOISE SURVEY SHALL BE SUFFICIENTLY CONDUCTED BY A QUALIFIED ENVIRONMENTAL CONSULTANT/ PROFESSIONAL ON ALL LAND AREAS PROPOSED FOR FUTURE DEVELOPMENT. SUCH 100% SITE-SURVEY SHALL BE CONDUCTED IN AN APPROPRIATE TIME FRAME AS REQUIRED BY JURISDICTIONAL AGENCY(S) PRIOR TO ANY PROJECTED LAND DISTURBANCE ACTIVITIES WHICH MAY ADVERSELY AFFECT THEM. ALL PROPOSED IMPACTS, RELOCATIONS, OR EXCLUSIONS OF GOPHER TORTOISES FROM THE SITE OVERALL SHALL BE PROPERLY PERMITTED (OR OTHERWISE AUTHORIZED IN WRITING) BY THE JURISDICTIONAL AGENCIES AND ADEQUATELY PERFORMED PRIOR TO INITIATION OF ANY SITE WORK ACTIVITIES.

NEIGHBORHOOD I GRADING PLAN

ion No <u>di</u> O LOT RESI BEU SCAMBIA **D** -**5** %


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SEAL NOT FOR CONSTRUCTION COENCE No. 53126 - VO/SERTE OF PAUL A, BATTLE, P.E. 1/ No.53126 \

Dr. By: CBD Ck By: PAB Job No.: 2018.158 Date: 4/21/2021

DRAWING No.

SHEET 11 OF 32

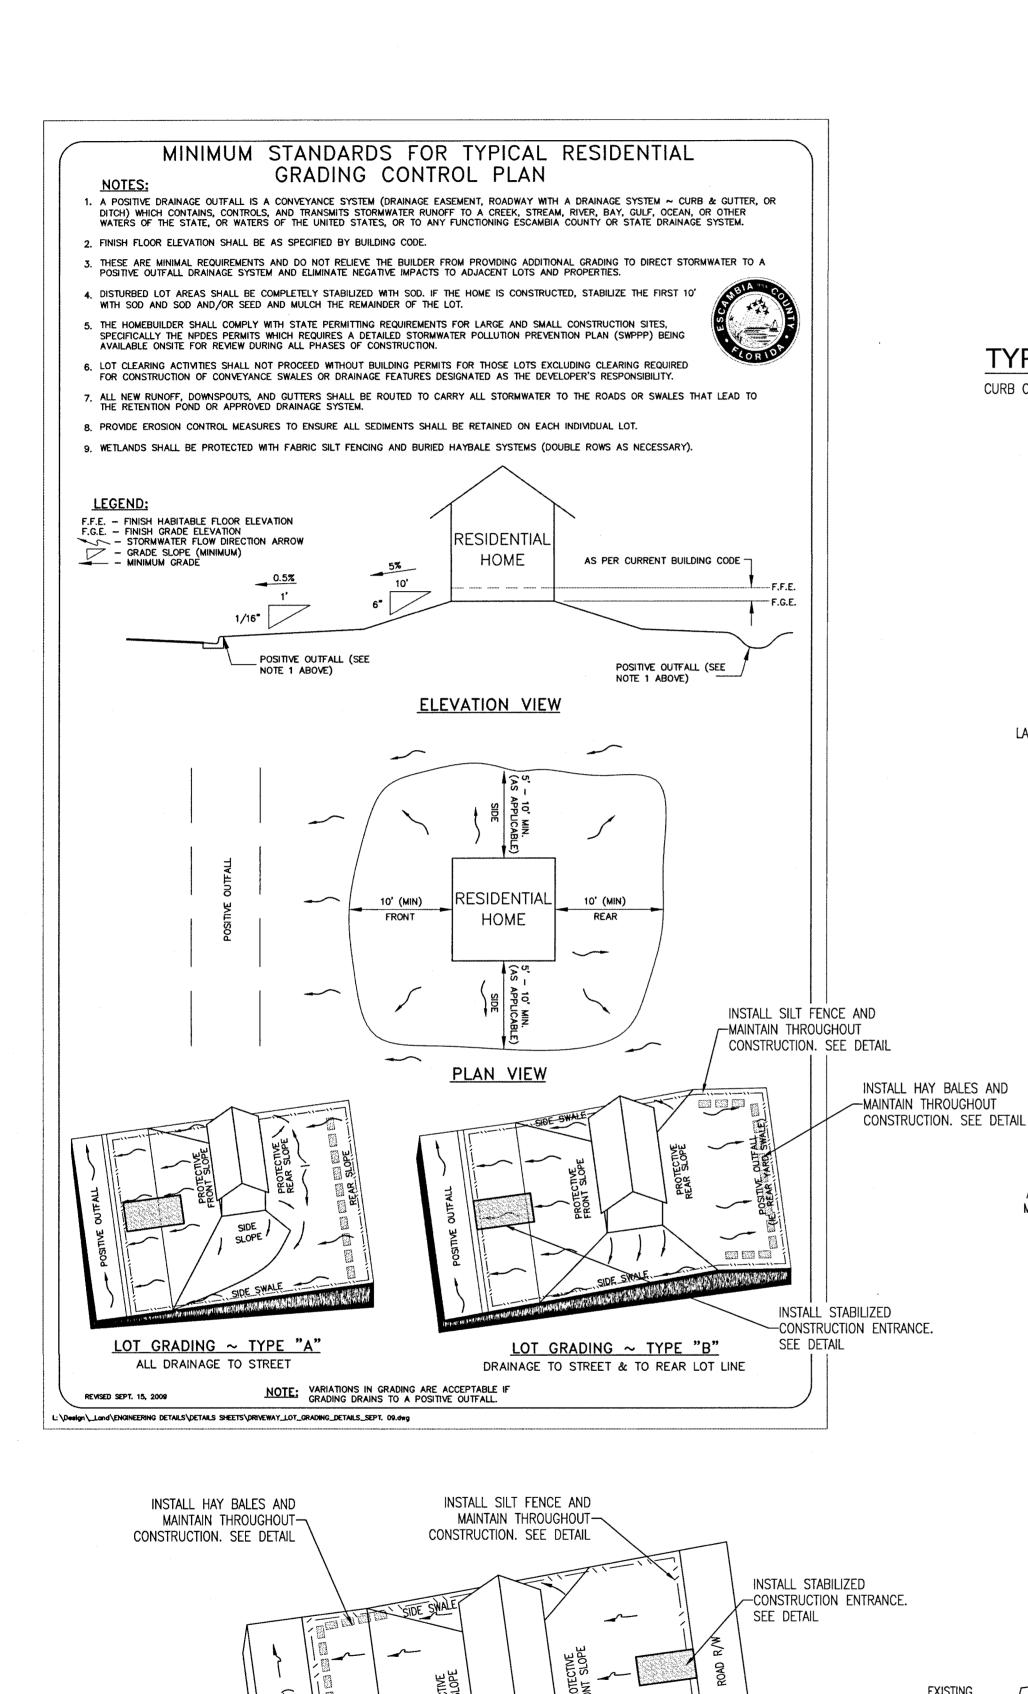

LOT GRADING TYPE 'C'

THE MAJORITY OF THE LOT SHALL SLOPE TO THE

DRAINAGE EASEMENT AT THE REAR OF THE LOT INSTEAD

OF THE STREET

NOTE: VARIATIONS IN GRADING ARE ACCEPTABLE IF

GRADING DRAINS TO A POSITIVE OUTFALL.


- 1) ALL MATERIALS AND LABOR FOR INSTALLATION WILL BE THE RESPONSIBILITY OF THE PROPERTY OWNER/CONTRACTOR.
- 2) DRIVEWAYS ABUTTING PAVED ROADS SHALL BE 1 1/2" ASPHALT WITH 6" STABILIZED SUB GRADE OR 4" TO 6" CONCRETE WITH 4" STABILIZED SUB GRADE - 95% COMPACTION (MODIFIED PROCTOR) WITH LBR 40 BETWEEN EDGE OF ROADWAY AND R/W LINE. COMPACTION AND TESTING IF NECESSARY, THIS WILL BE THE RESPONSIBILITY OF THE OWNER/CONTRACTOR.

PLAN VIEW

- DRIVEWAYS ABUTTING A DIRT ROAD SHALL BE MILLED ASPHALT, GRADED AGGREGATE BASE, OR WASHED CONCRETE (4" IN DEPTH) ON THE COUNTY MAINTAINED PORTION OF DRIVEWAY.
- 4) IF NECESSARY, REFER TO FDOT INDEX DETAILS AS REFERENCED BELOW.
- RADIUS OR FLARE IS REQUIRED FOR TYPE II OR TYPE III CONNECTIONS. SEE DETAIL.
- PARKING SPACES WITHIN COUNTY RIGHT-OF-WAY SHALL PROVIDE A MINIMUM OF 2 PARKING SPACES.
- 7) TYPICAL DRIVEWAY SECTIONS ARE TO BE 12' WIDE MINIMUM.

TYPE I

CURB CUT DRIVEWAY FOR COUNTY TYPE "B" LAYBACK CURBS.

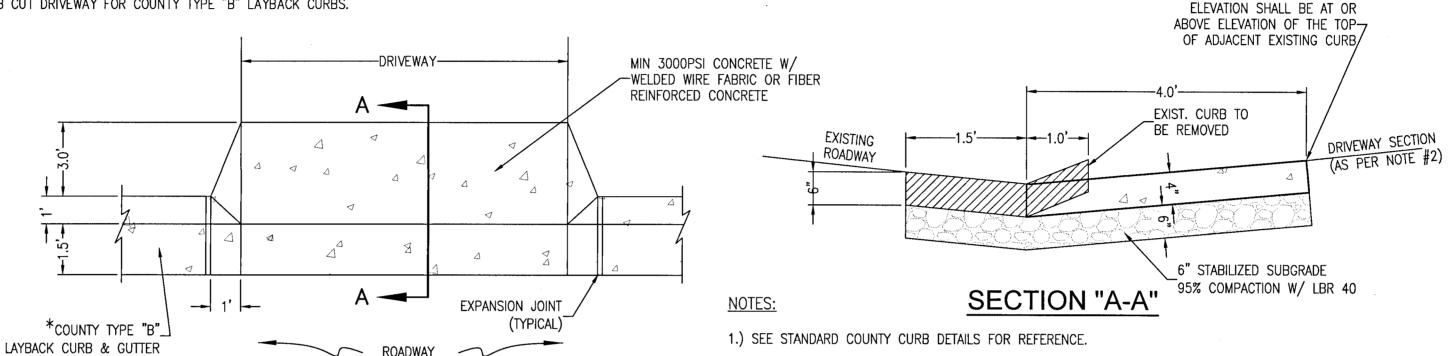


2.) SEE F.D.O.T. INDEX NO. 515 FOR OTHER CONNECTIONS.

* FOR OTHER TYPE CURBS, DIMENSIONS MAY BE ADJUSTED TO FIT.

LOT GRADE

TYPICAL DRIVEWAY CONNECTION STANDARDS FOR EXISTING ROADWAY CONDITIONS

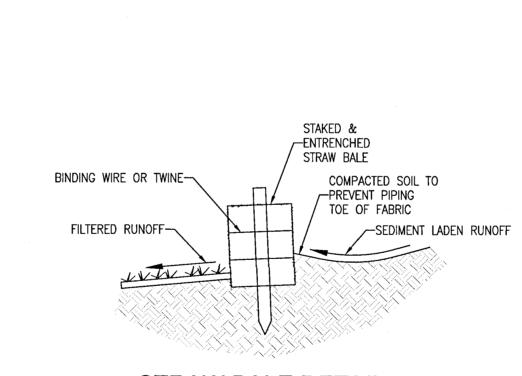

STRAW BALE DETAIL

N.T.S.

ROADWAY PROVIDE APPROPRIATE TRANSITION BETWEEN STABILIZED CONSTRUCTION ENTRANCE AND PUBLIC R.O.W. STABILIZED CONSTRUCTION

-TOE OF FABRIC

2"x4" OR 3"Ø TREATED

-TIMBER POST @ 6' O.C.

FIBERTEX (OR APPROVED EQUAL)._ MATERIAL ATTACHED

TO WIRE FENCE

0 00 00

ENTRANCE DETAIL

N.T.S.

GROUND

FILTER FABRIC

(SEE GENERAL NOTE 8)

COMPACTED SOIL-

SILT FENCE DETAIL

= |----5' Drainage Easement--|----5' Drainage Easement--|= LOT GRADE SIDE SLOPES & BOTTOM SHALL BE-STABILIZED WITH SOD

TYPICAL PRIVATE 5' DRAINAGE EASEMENT SWALE

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WHICHEVER IS GREATER, BUT NOT TO EXCEED 15 FEET

- 12. DISTURBED RIGHT-OF-WAY AREAS SHALL BE STABILIZED WITH A HEALTHY GROWTH OF GRASS PRIOR TO RECEIVING COUNTY ACCEPTANCE.
- 13. BUILDING SETBACKS (LDR): FRONT = 25'; REAR = 25'; SIDE = 5' OR 10% OF LOT WIDTH AT STREET RIGHT-OF WAY.

MAXIMUM LOT SURFACE COVERAGE

TOTAL MAX IMPERVIOUS / LOT = 6,767-SF

TOTAL IMPERVIOUS SURFACE

IMPERVIOUS SURFACE AREA / LOT (MAXIMUM) = 6,767-SF NUMBER OF LOTS = 36, TOTAL LOT IMPERVIOUS = 243,612-SF

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TOTAL PROPOSED IMPERVIOUS SURFACE = 313,994-SF

LO_ [S NEIGHBORHOOD L GRADING DETAIL

Ibdivision SUBDIVISION stone

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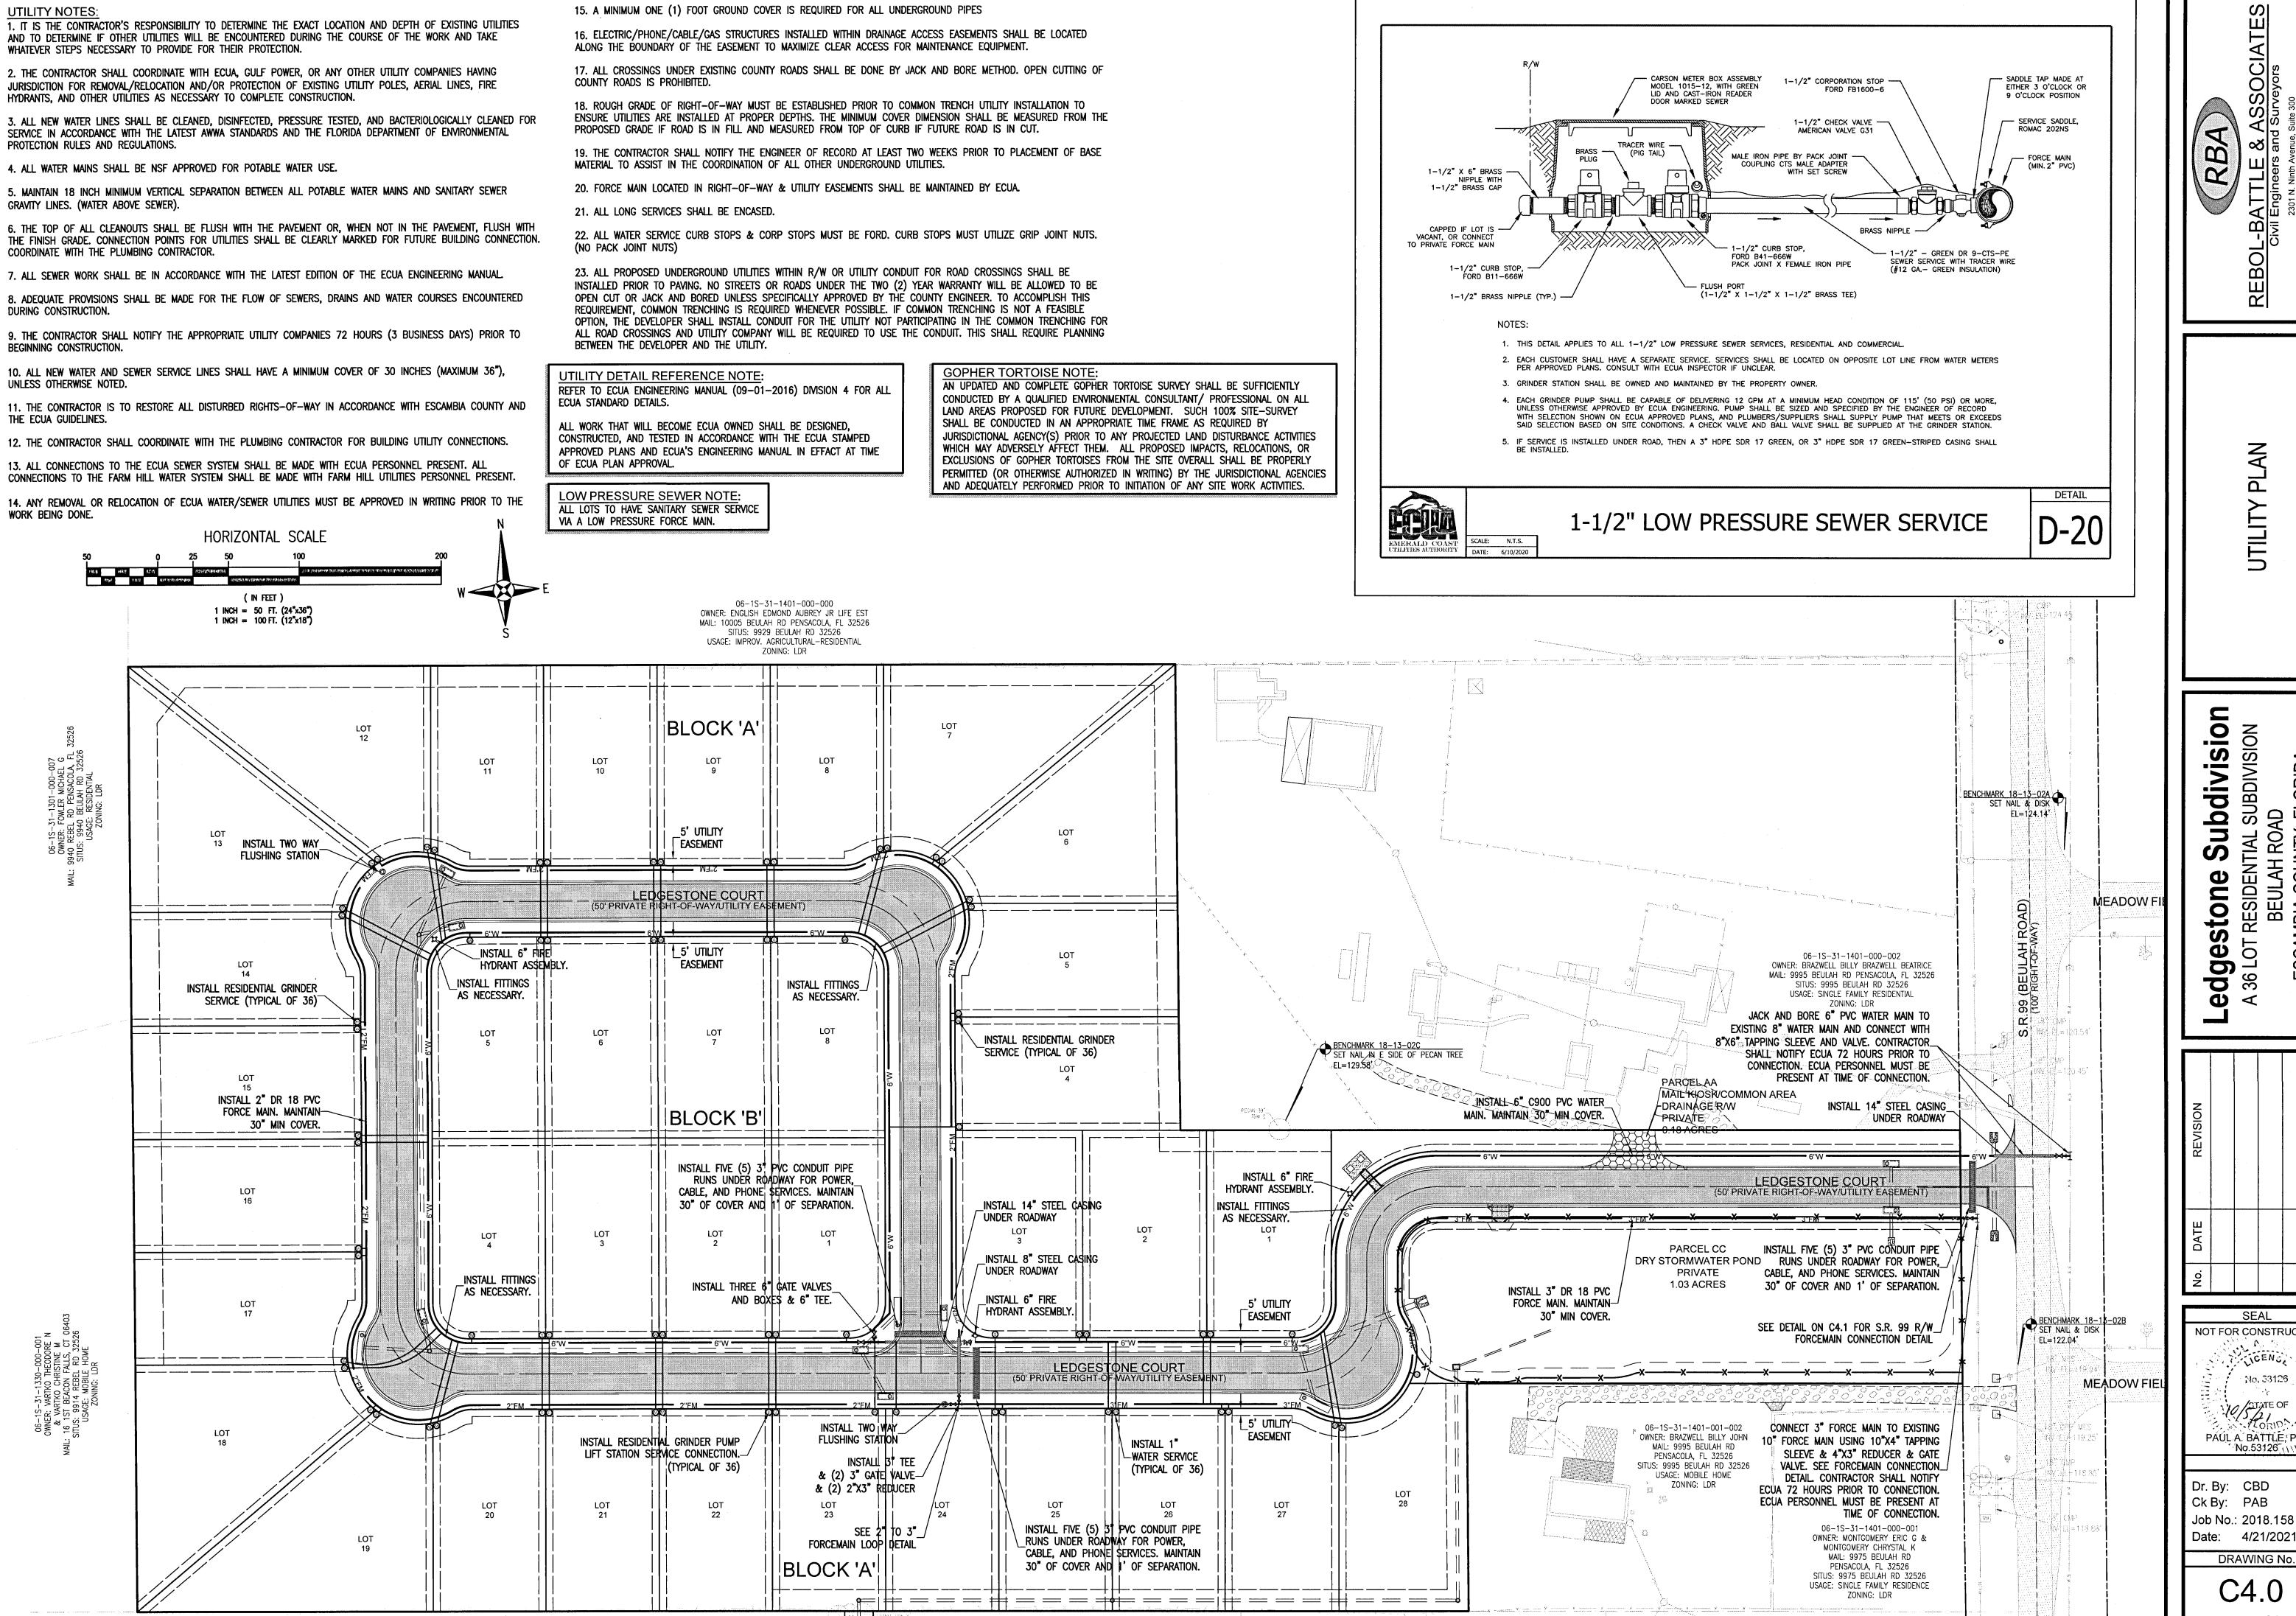
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SEAL NOT FOR CONSTRUCTION CICENS No. 53126 STATE OF PAUL'A., BATTLE, P.E. No.53126

Dr. By: CBD Ck By: PAB Job No.: 2018.158 Date: 4/21/2021

DRAWING No.

SHEET 12 OF 32




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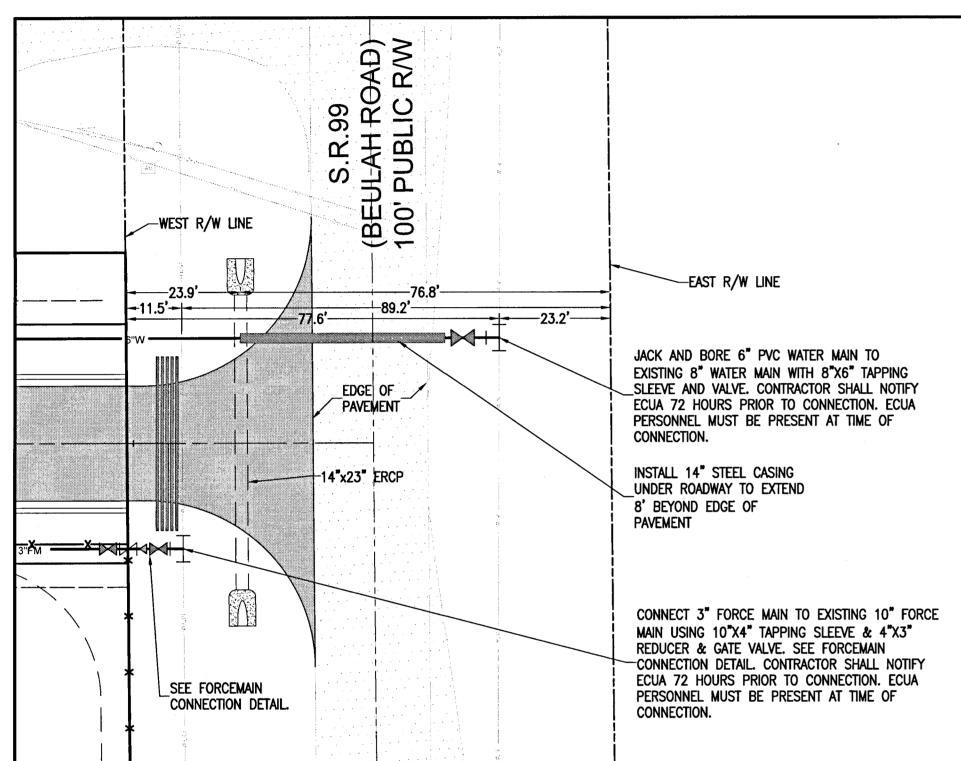
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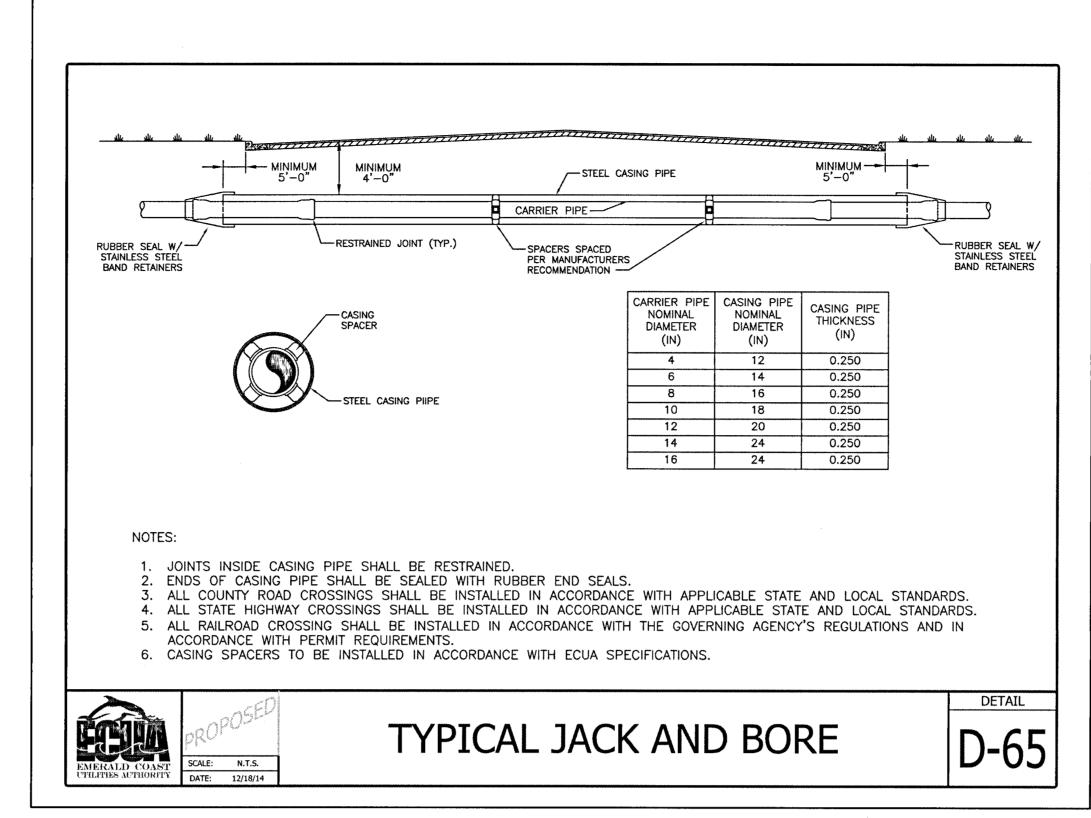
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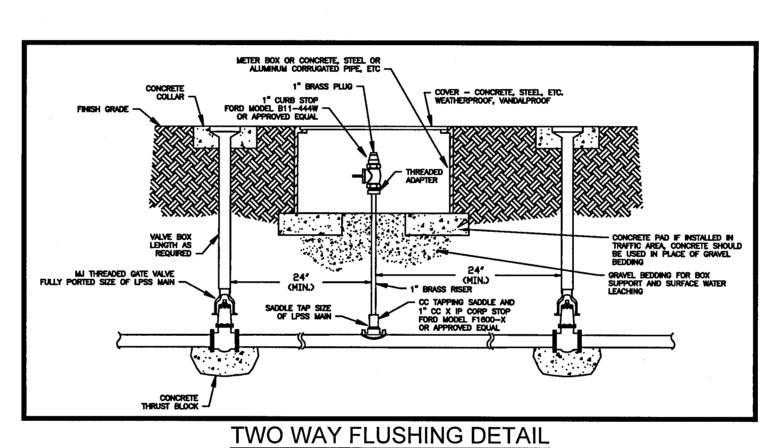
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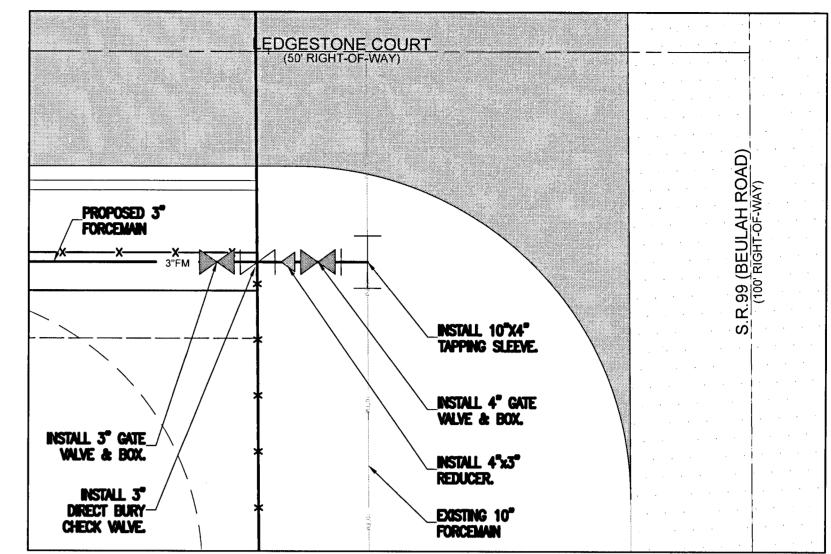
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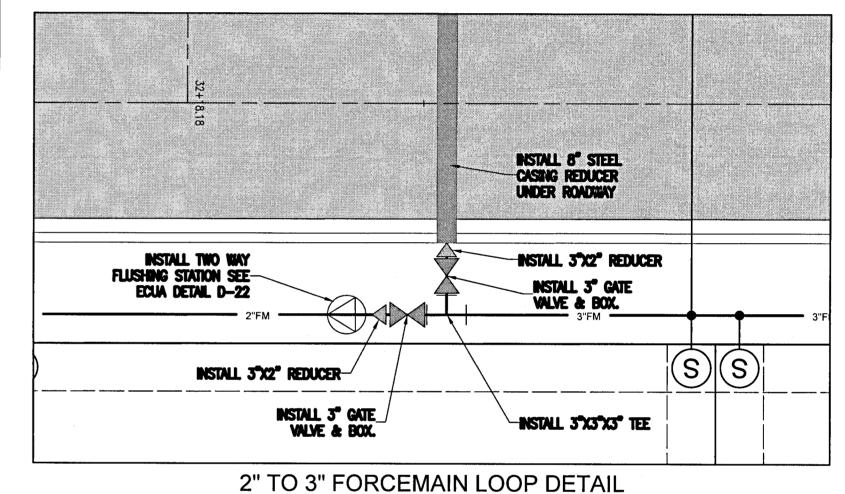









S.R.99 R/W FORCEMAIN CONNECTION DETAIL
SCALE: NTS

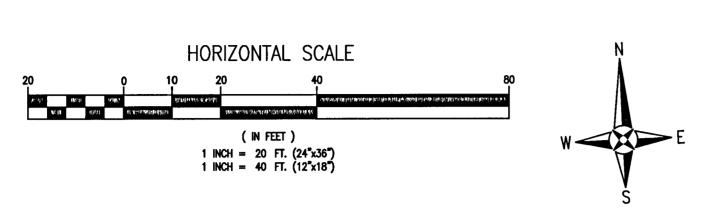

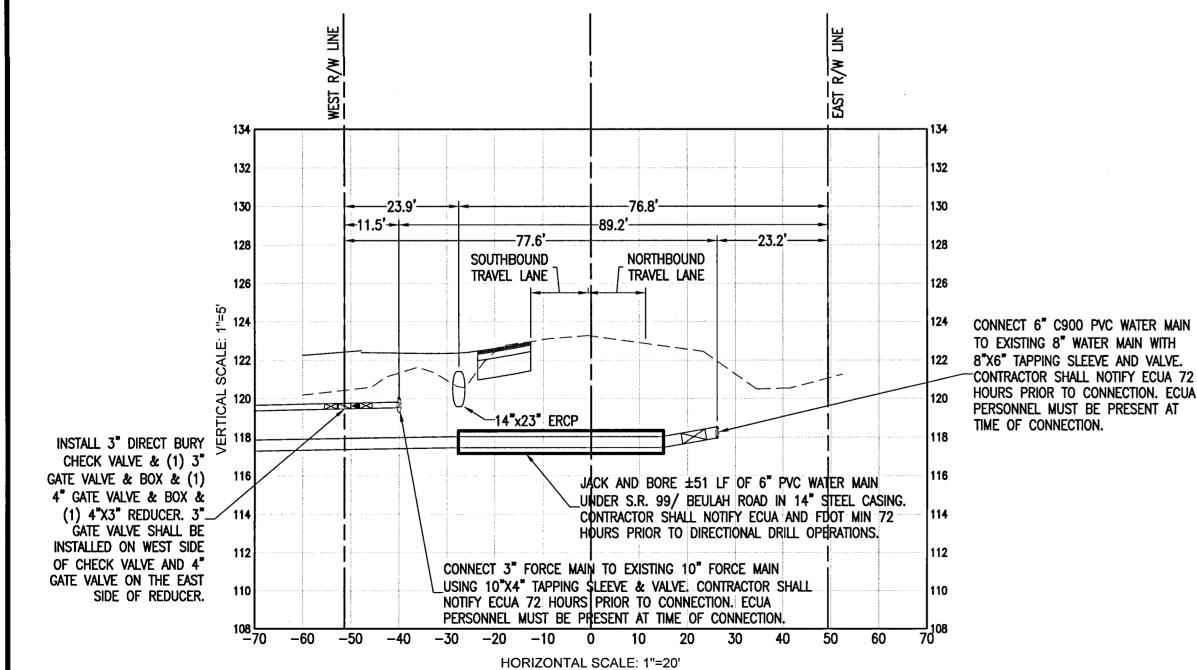

Beulah Road - Sta 10+50

3. ALL NEW WATER LINES SHALL BE CLEANED, DISINFECTED, PRESSURE TESTED, AND BACTERIOLOGICALLY CLEANED FOR SERVICE IN ACCORDANCE WITH THE LATEST AWWA STANDARDS AND THE FLORIDA DEPARTMENT OF ENVIRONMENTAL PROTECTION RULES AND REGULATIONS.

4. ALL WATER MAINS SHALL BE NSF APPROVED FOR POTABLE WATER USE.

5. MAINTAIN 18 INCH MINIMUM VERTICAL SEPARATION BETWEEN ALL POTABLE WATER MAINS AND SANITARY SEWER GRAVITY LINES. (WATER ABOVE SEWER).

6. THE TOP OF ALL CLEANOUTS SHALL BE FLUSH WITH THE PAVEMENT OR, WHEN NOT IN THE PAVEMENT, FLUSH WITH THE FINISH GRADE. CONNECTION POINTS FOR UTILITIES SHALL BE CLEARLY MARKED FOR FUTURE BUILDING CONNECTION. COORDINATE WITH THE PLUMBING CONTRACTOR.

THE ECUA GUIDELINES.

UTILITY NOTES:

7. ALL SEWER WORK SHALL BE IN ACCORDANCE WITH THE LATEST EDITION OF THE ECUA ENGINEERING MANUAL.

1. IT IS THE CONTRACTOR'S RESPONSIBILITY TO DETERMINE THE EXACT LOCATION AND DEPTH OF EXISTING UTILITIES

AND TO DETERMINE IF OTHER UTILITIES WILL BE ENCOUNTERED DURING THE COURSE OF THE WORK AND TAKE

2. THE CONTRACTOR SHALL COORDINATE WITH ECUA, GULF POWER, OR ANY OTHER UTILITY COMPANIES HAVING

JURISDICTION FOR REMOVAL/RELOCATION AND/OR PROTECTION OF EXISTING UTILITY POLES, AERIAL LINES, FIRE

WHATEVER STEPS NECESSARY TO PROVIDE FOR THEIR PROTECTION.

HYDRANTS, AND OTHER UTILITIES AS NECESSARY TO COMPLETE CONSTRUCTION.

8. ADEQUATE PROVISIONS SHALL BE MADE FOR THE FLOW OF SEWERS, DRAINS AND WATER COURSES ENCOUNTERED DURING CONSTRUCTION.

9. THE CONTRACTOR SHALL NOTIFY THE APPROPRIATE UTILITY COMPANIES 72 HOURS (3 BUSINESS DAYS) PRIOR TO BEGINNING CONSTRUCTION.

10. ALL NEW WATER AND SEWER SERVICE LINES SHALL HAVE A MINIMUM COVER OF 30 INCHES (MAXIMUM 36"),

UNLESS OTHERWISE NOTED.

11. THE CONTRACTOR IS TO RESTORE ALL DISTURBED RIGHTS—OF—WAY IN ACCORDANCE WITH ESCAMBIA COUNTY AND

12. THE CONTRACTOR SHALL COORDINATE WITH THE PLUMBING CONTRACTOR FOR BUILDING UTILITY CONNECTIONS.

13. ALL CONNECTIONS TO THE ECUA SEWER SYSTEM SHALL BE MADE WITH ECUA PERSONNEL PRESENT. ALL CONNECTIONS TO THE FARM HILL WATER SYSTEM SHALL BE MADE WITH FARM HILL UTILITIES PERSONNEL PRESENT.

14. ANY REMOVAL OR RELOCATION OF ECUA WATER/SEWER UTILITIES MUST BE APPROVED IN WRITING PRIOR TO THE WORK BEING DONE.

15. A MINIMUM ONE (1) FOOT GROUND COVER IS REQUIRED FOR ALL UNDERGROUND PIPES

16. ELECTRIC/PHONE/CABLE/GAS STRUCTURES INSTALLED WITHIN DRAINAGE ACCESS EASEMENTS SHALL BE LOCATED ALONG THE BOUNDARY OF THE EASEMENT TO MAXIMIZE CLEAR ACCESS FOR MAINTENANCE EQUIPMENT.

17. ALL CROSSINGS UNDER EXISTING COUNTY ROADS SHALL BE DONE BY JACK AND BORE METHOD. OPEN CUTTING OF COUNTY ROADS IS PROHIBITED.

18. ROUGH GRADE OF RIGHT-OF-WAY MUST BE ESTABLISHED PRIOR TO COMMON TRENCH UTILITY INSTALLATION TO ENSURE UTILITIES ARE INSTALLED AT PROPER DEPTHS. THE MINIMUM COVER DIMENSION SHALL BE MEASURED FROM THE PROPOSED GRADE IF ROAD IS IN FILL AND MEASURED FROM TOP OF CURB IF FUTURE ROAD IS IN CUT.

19. THE CONTRACTOR SHALL NOTIFY THE ENGINEER OF RECORD AT LEAST TWO WEEKS PRIOR TO PLACEMENT OF BASE MATERIAL TO ASSIST IN THE COORDINATION OF ALL OTHER UNDERGROUND UTILITIES.

20. FORCE MAIN LOCATED IN RIGHT-OF-WAY & UTILITY EASEMENTS SHALL BE MAINTAINED BY ECUA.

FORCE MAIN LOCATED IN RIGHT-OF-WAY & UTILITY EASEMENTS SHALL BE MAINTAINE

21. ALL LONG SERVICES SHALL BE ENCASED.

22. ALL WATER SERVICE CURB STOPS & CORP STOPS MUST BE FORD. CURB STOPS MUST UTILIZE GRIP JOINT NUTS. (NO PACK JOINT NUTS)

23. ALL PROPOSED UNDERGROUND UTILITIES WITHIN R/W OR UTILITY CONDUIT FOR ROAD CROSSINGS SHALL BE INSTALLED PRIOR TO PAVING. NO STREETS OR ROADS UNDER THE TWO (2) YEAR WARRANTY WILL BE ALLOWED TO BE OPEN CUT OR JACK AND BORED UNLESS SPECIFICALLY APPROVED BY THE COUNTY ENGINEER. TO ACCOMPLISH THIS REQUIREMENT, COMMON TRENCHING IS REQUIRED WHENEVER POSSIBLE. IF COMMON TRENCHING IS NOT A FEASIBLE OPTION, THE DEVELOPER SHALL INSTALL CONDUIT FOR THE UTILITY NOT PARTICIPATING IN THE COMMON TRENCHING FOR ALL ROAD CROSSINGS AND UTILITY COMPANY WILL BE REQUIRED TO USE THE CONDUIT. THIS SHALL REQUIRE PLANNING BETWEEN THE DEVELOPER AND THE UTILITY.

UTILITY DETAIL REFERENCE NOTE:
REFER TO ECUA ENGINEERING MANUAL (09-01-2016) DIVISION 4 FOR ALL ECUA STANDARD DETAILS.

ALL WORK THAT WILL BECOME ECUA OWNED SHALL BE DESIGNED, CONSTRUCTED, AND TESTED IN ACCORDANCE WITH THE ECUA STAMPED APPROVED PLANS AND ECUA'S ENGINEERING MANUAL IN EFFACT AT TIME OF ECUA PLAN APPROVAL.

REBOL-BATTLE & ASSOCIA

Civil Engineers and Surveyors

2301 N. Ninth Avenue, Suite 300
Pensacola, Florida 32503
Telephone 850,438,0400 Fax 850,438,0448

FDOT UTILITY PLAN

tone Subdivision
RESIDENTIAL SUBDIVISION
BEULAH ROAD

ATE REVISION

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SEAL

NOT FOR CONSTRUCTION

No. 53126

STATE OF

PAUL A. BATTLE, P.E.


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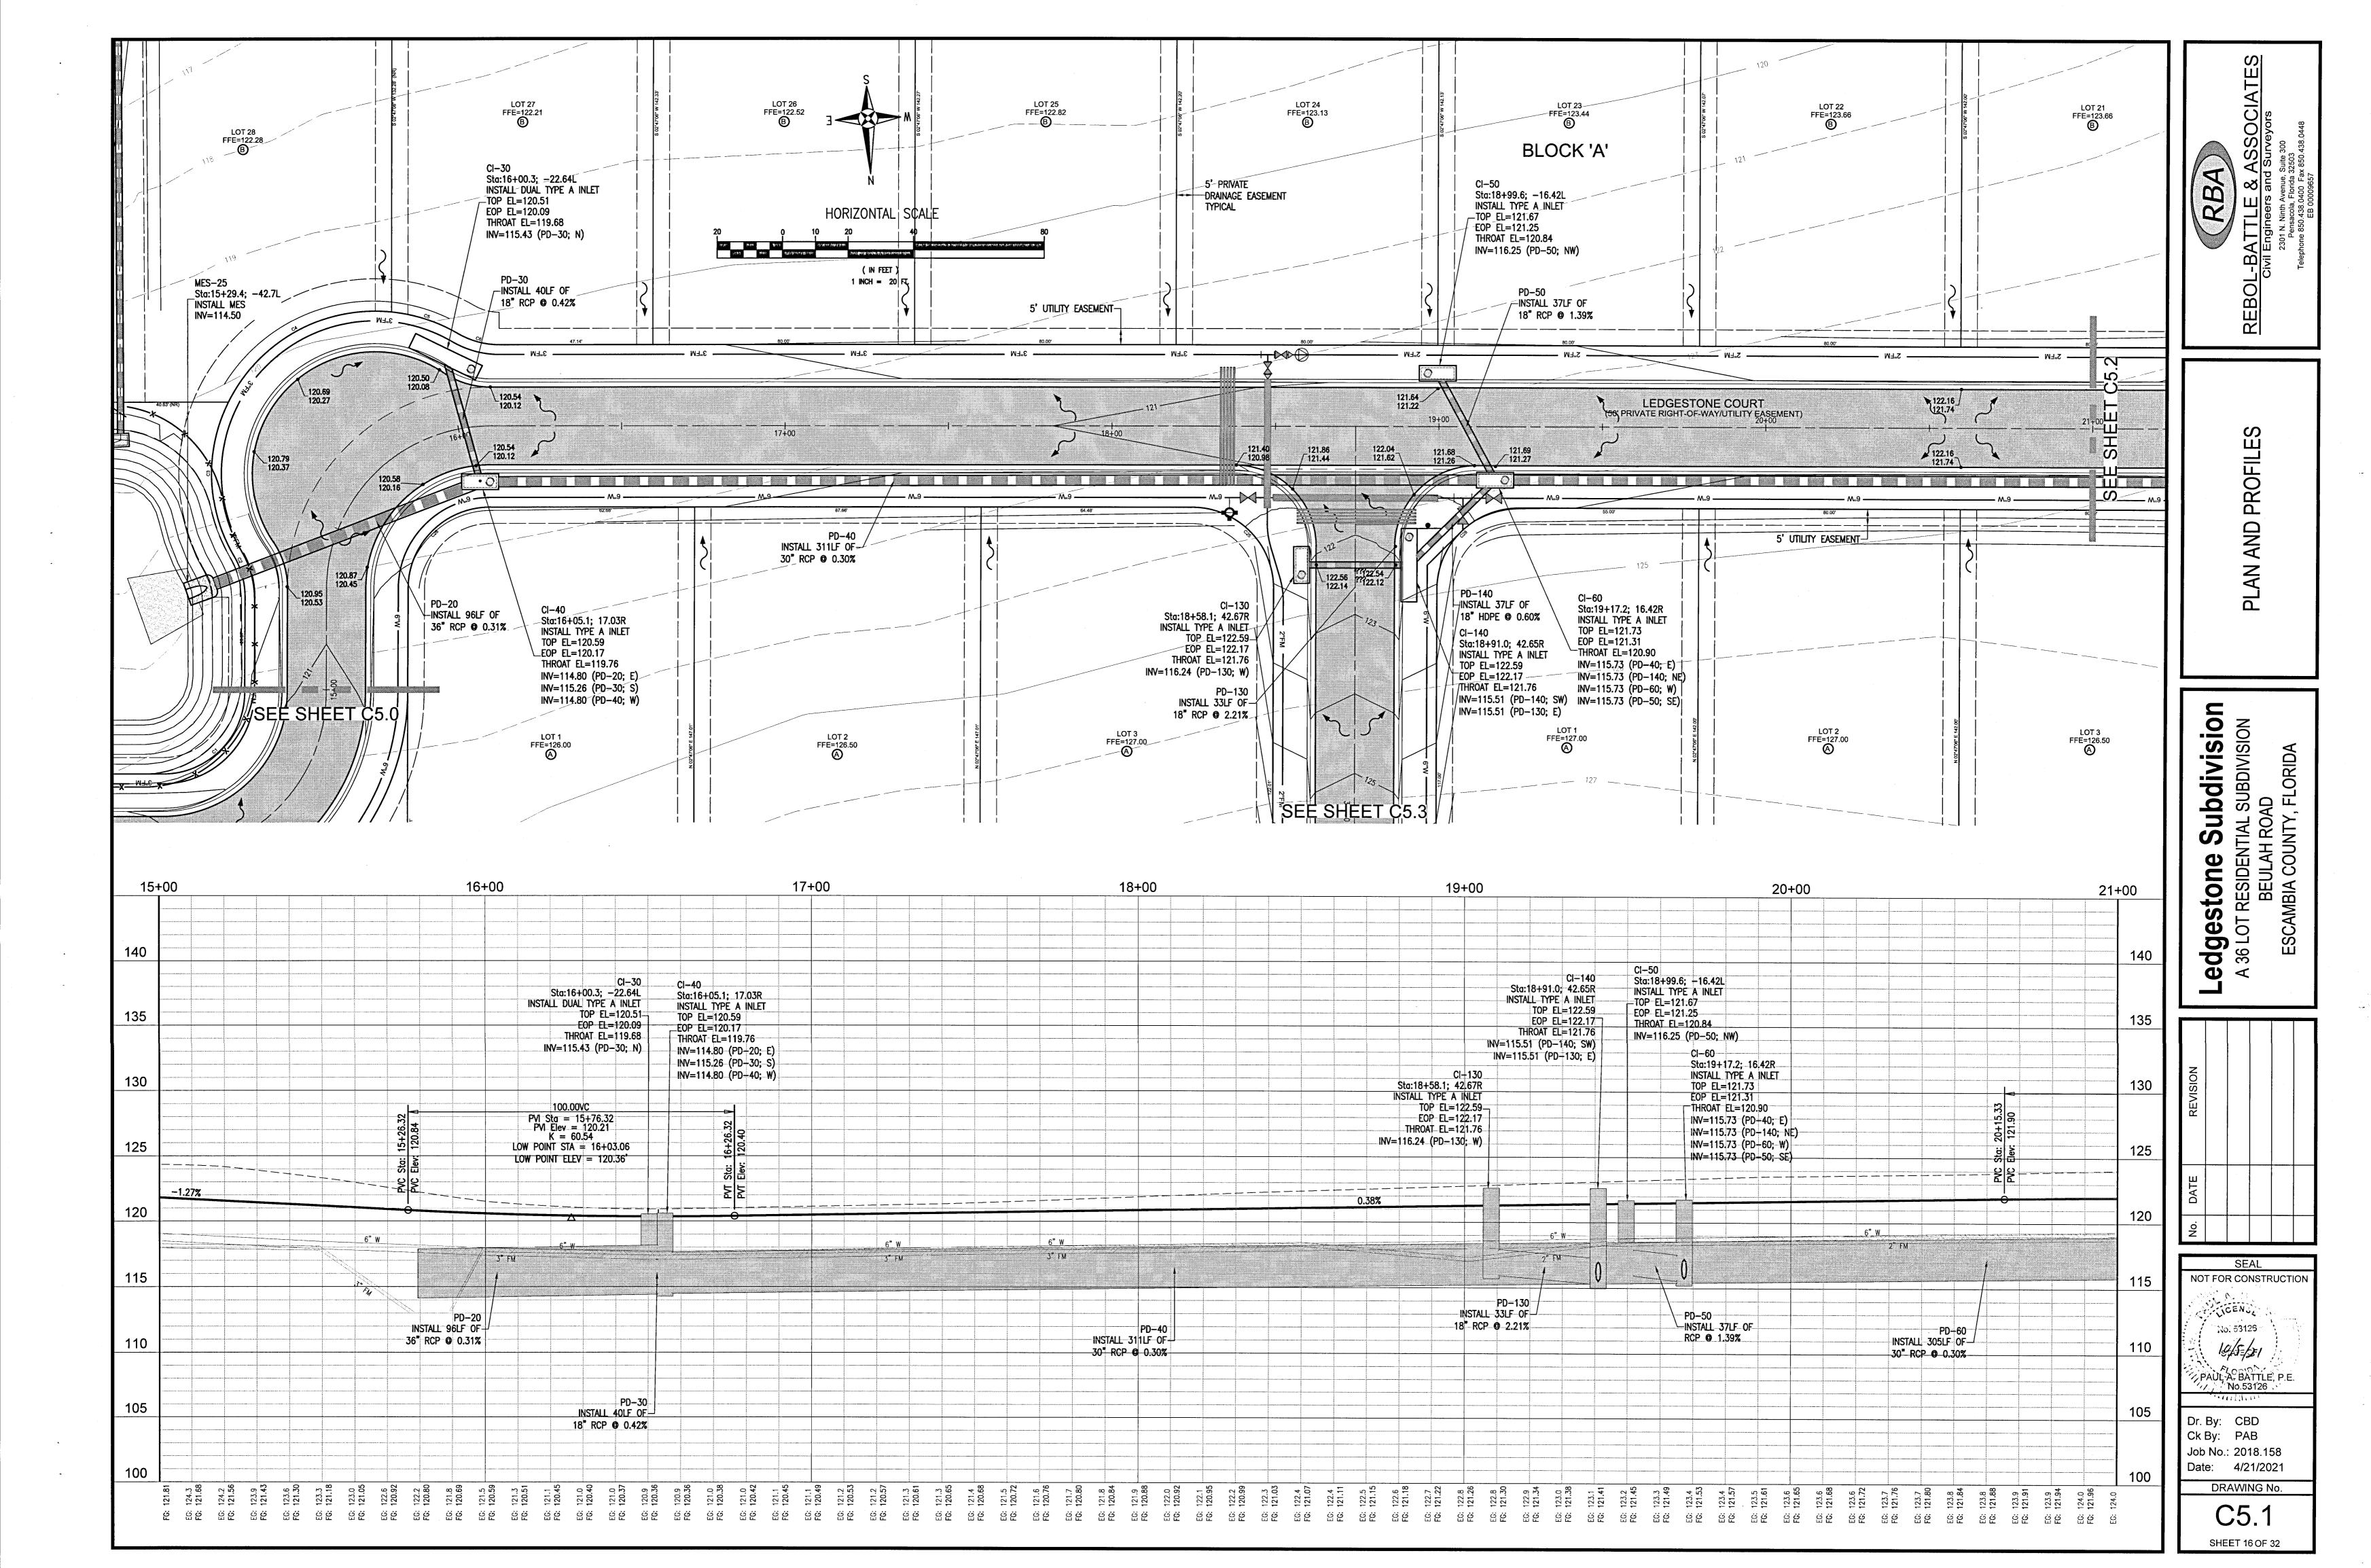
Dr. By: CBD Ck By: PAB Job No.: 2018.158 Date: 4/21/2021


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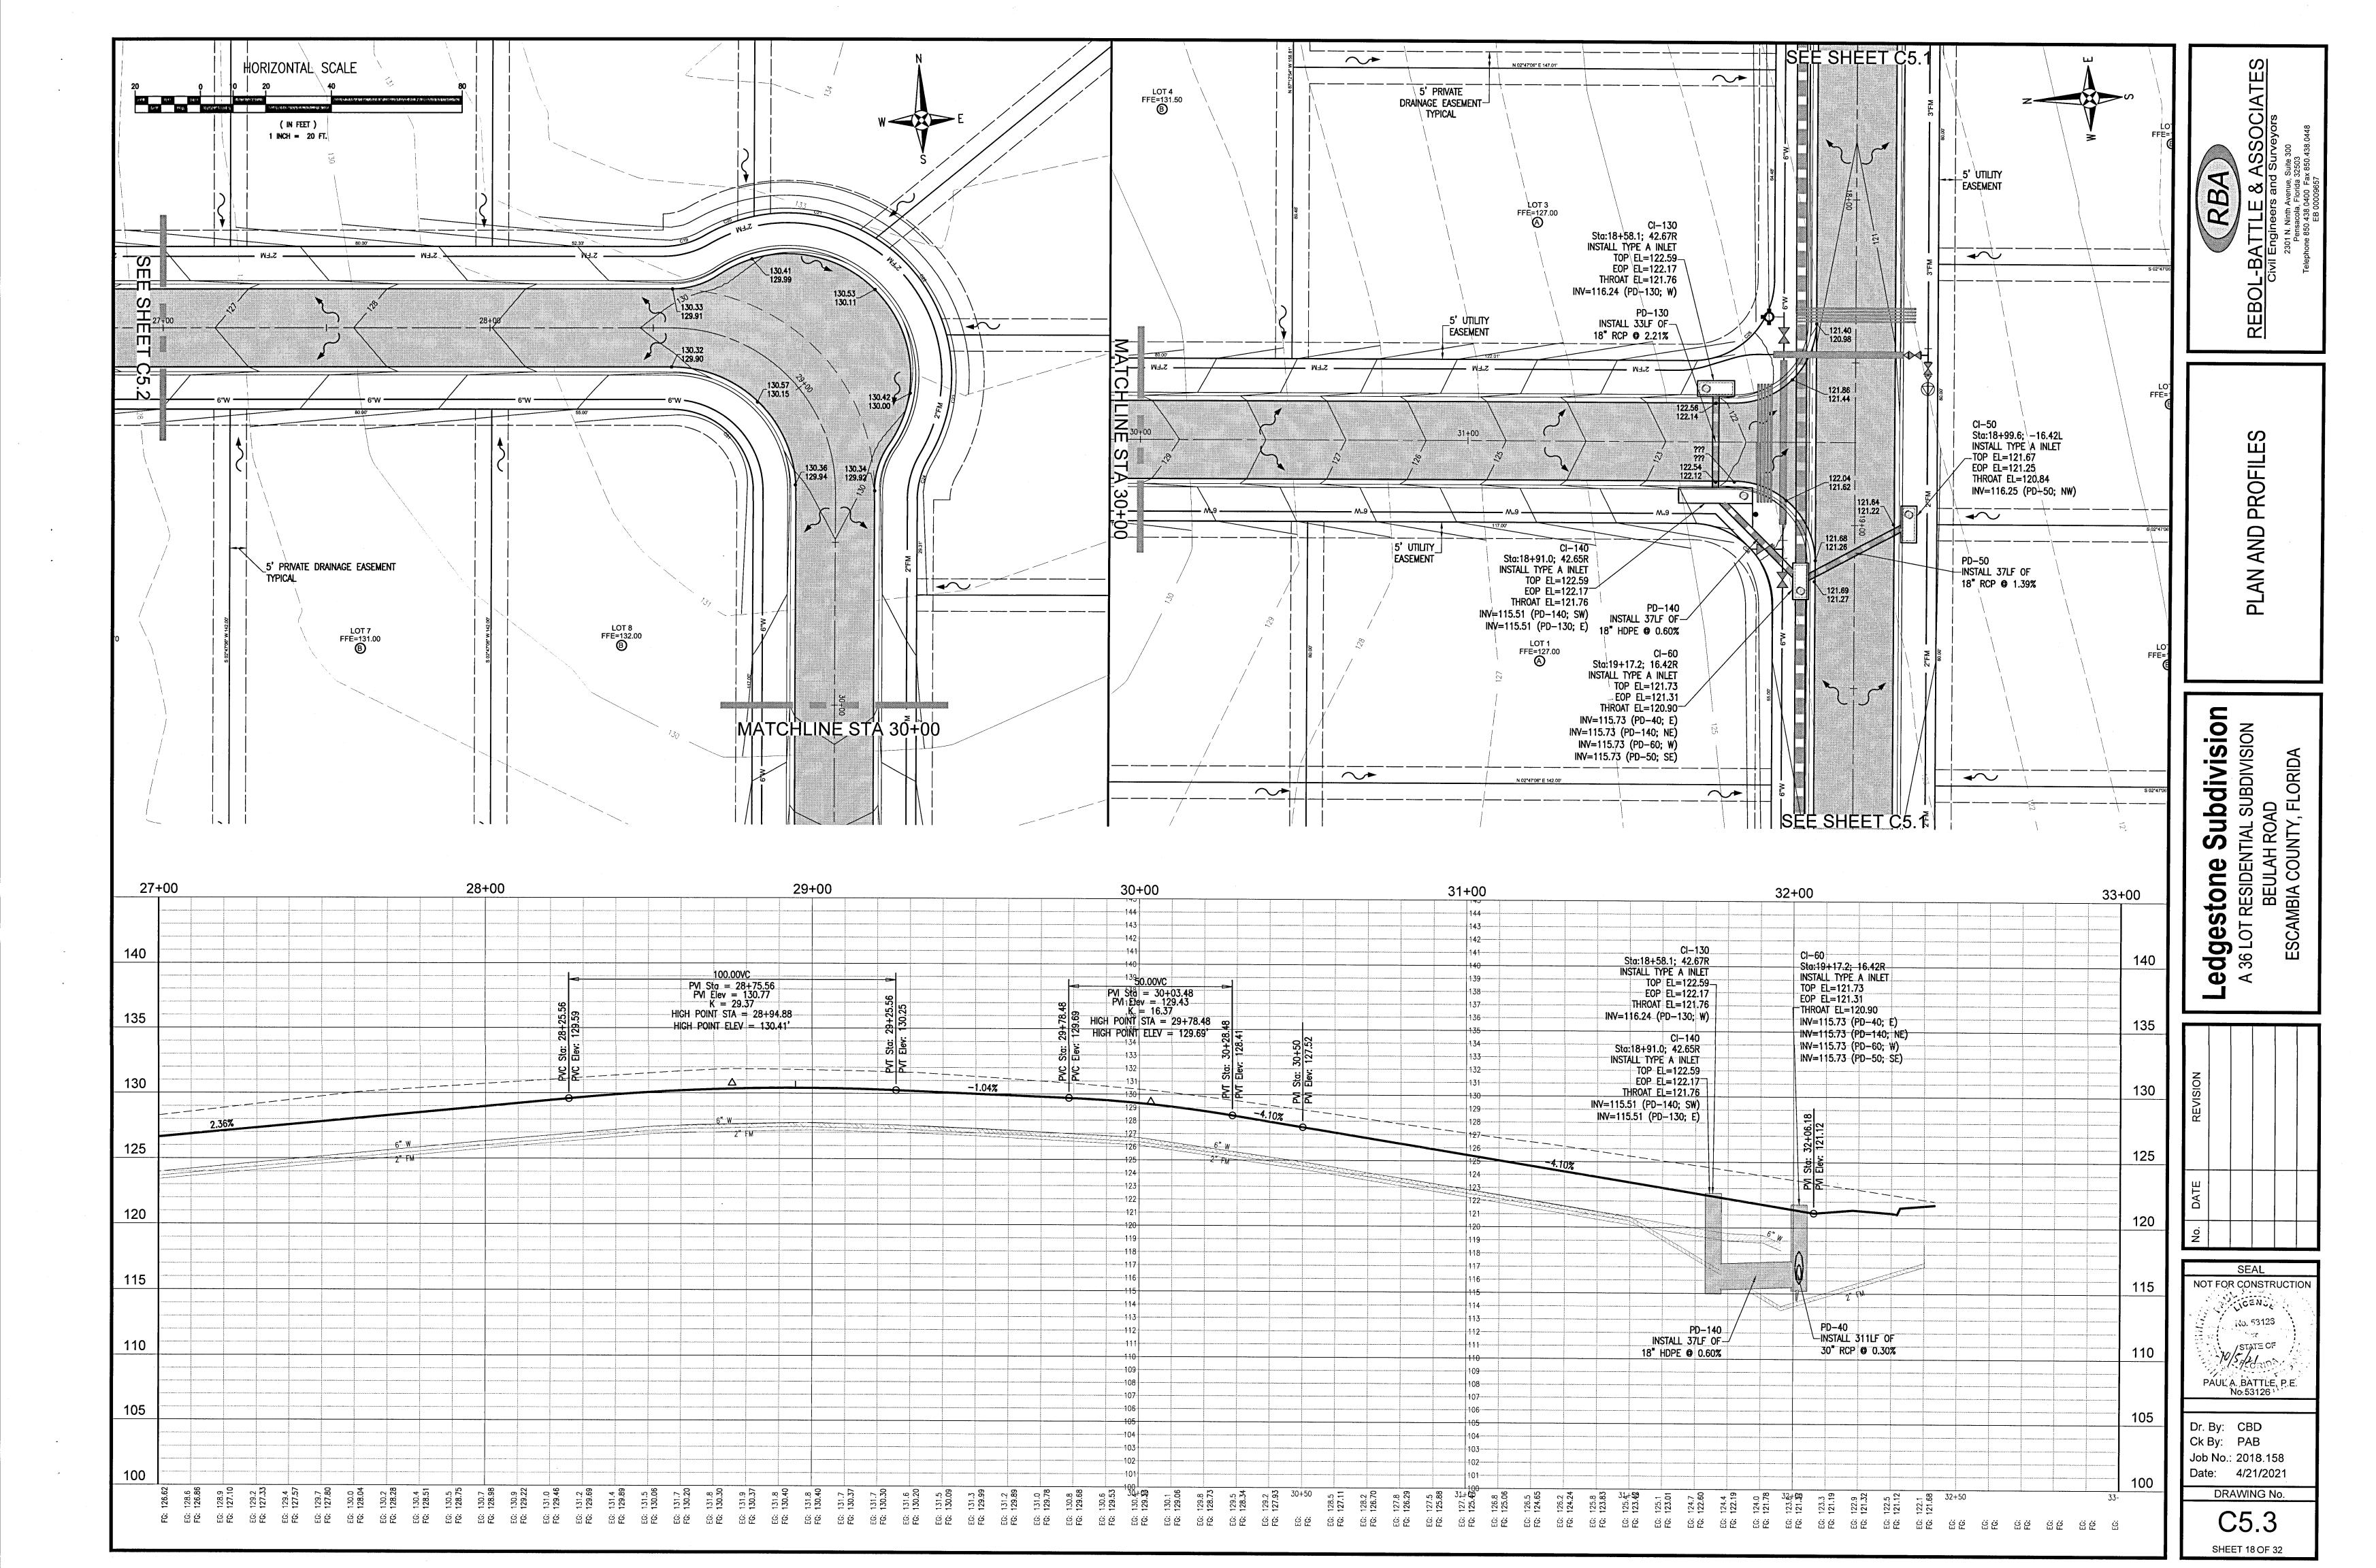
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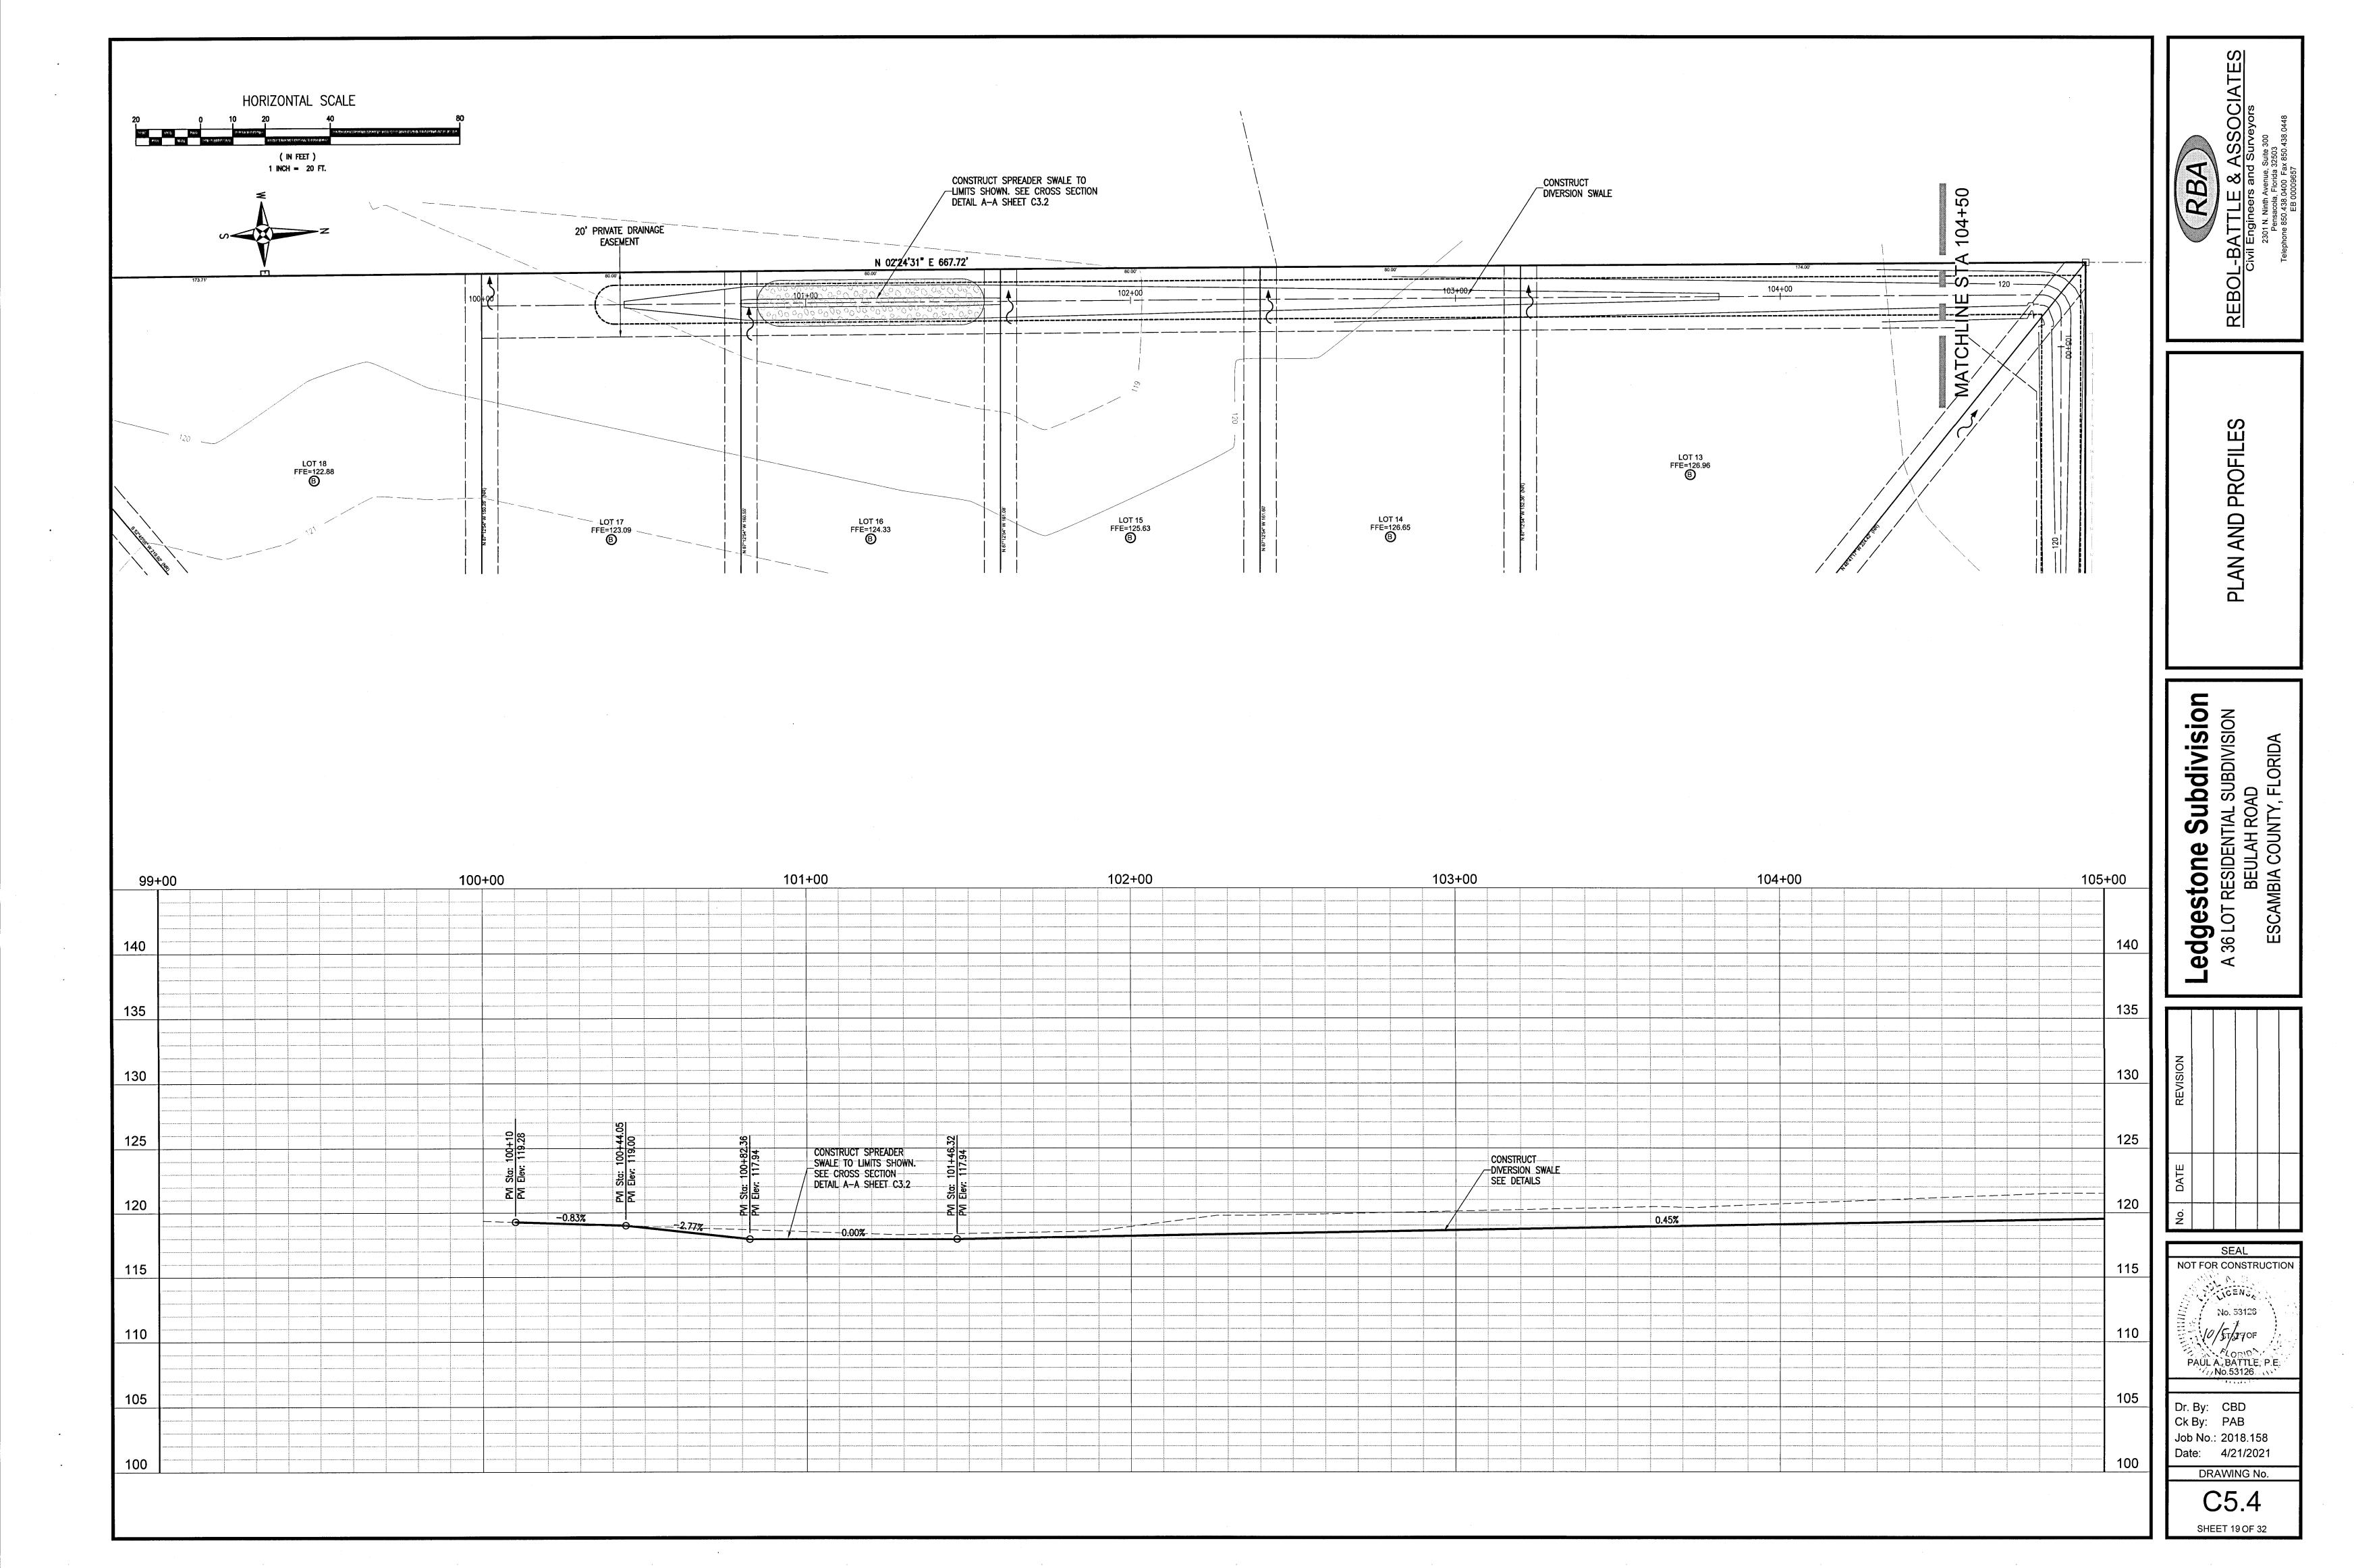
SHEET 14 OF 32










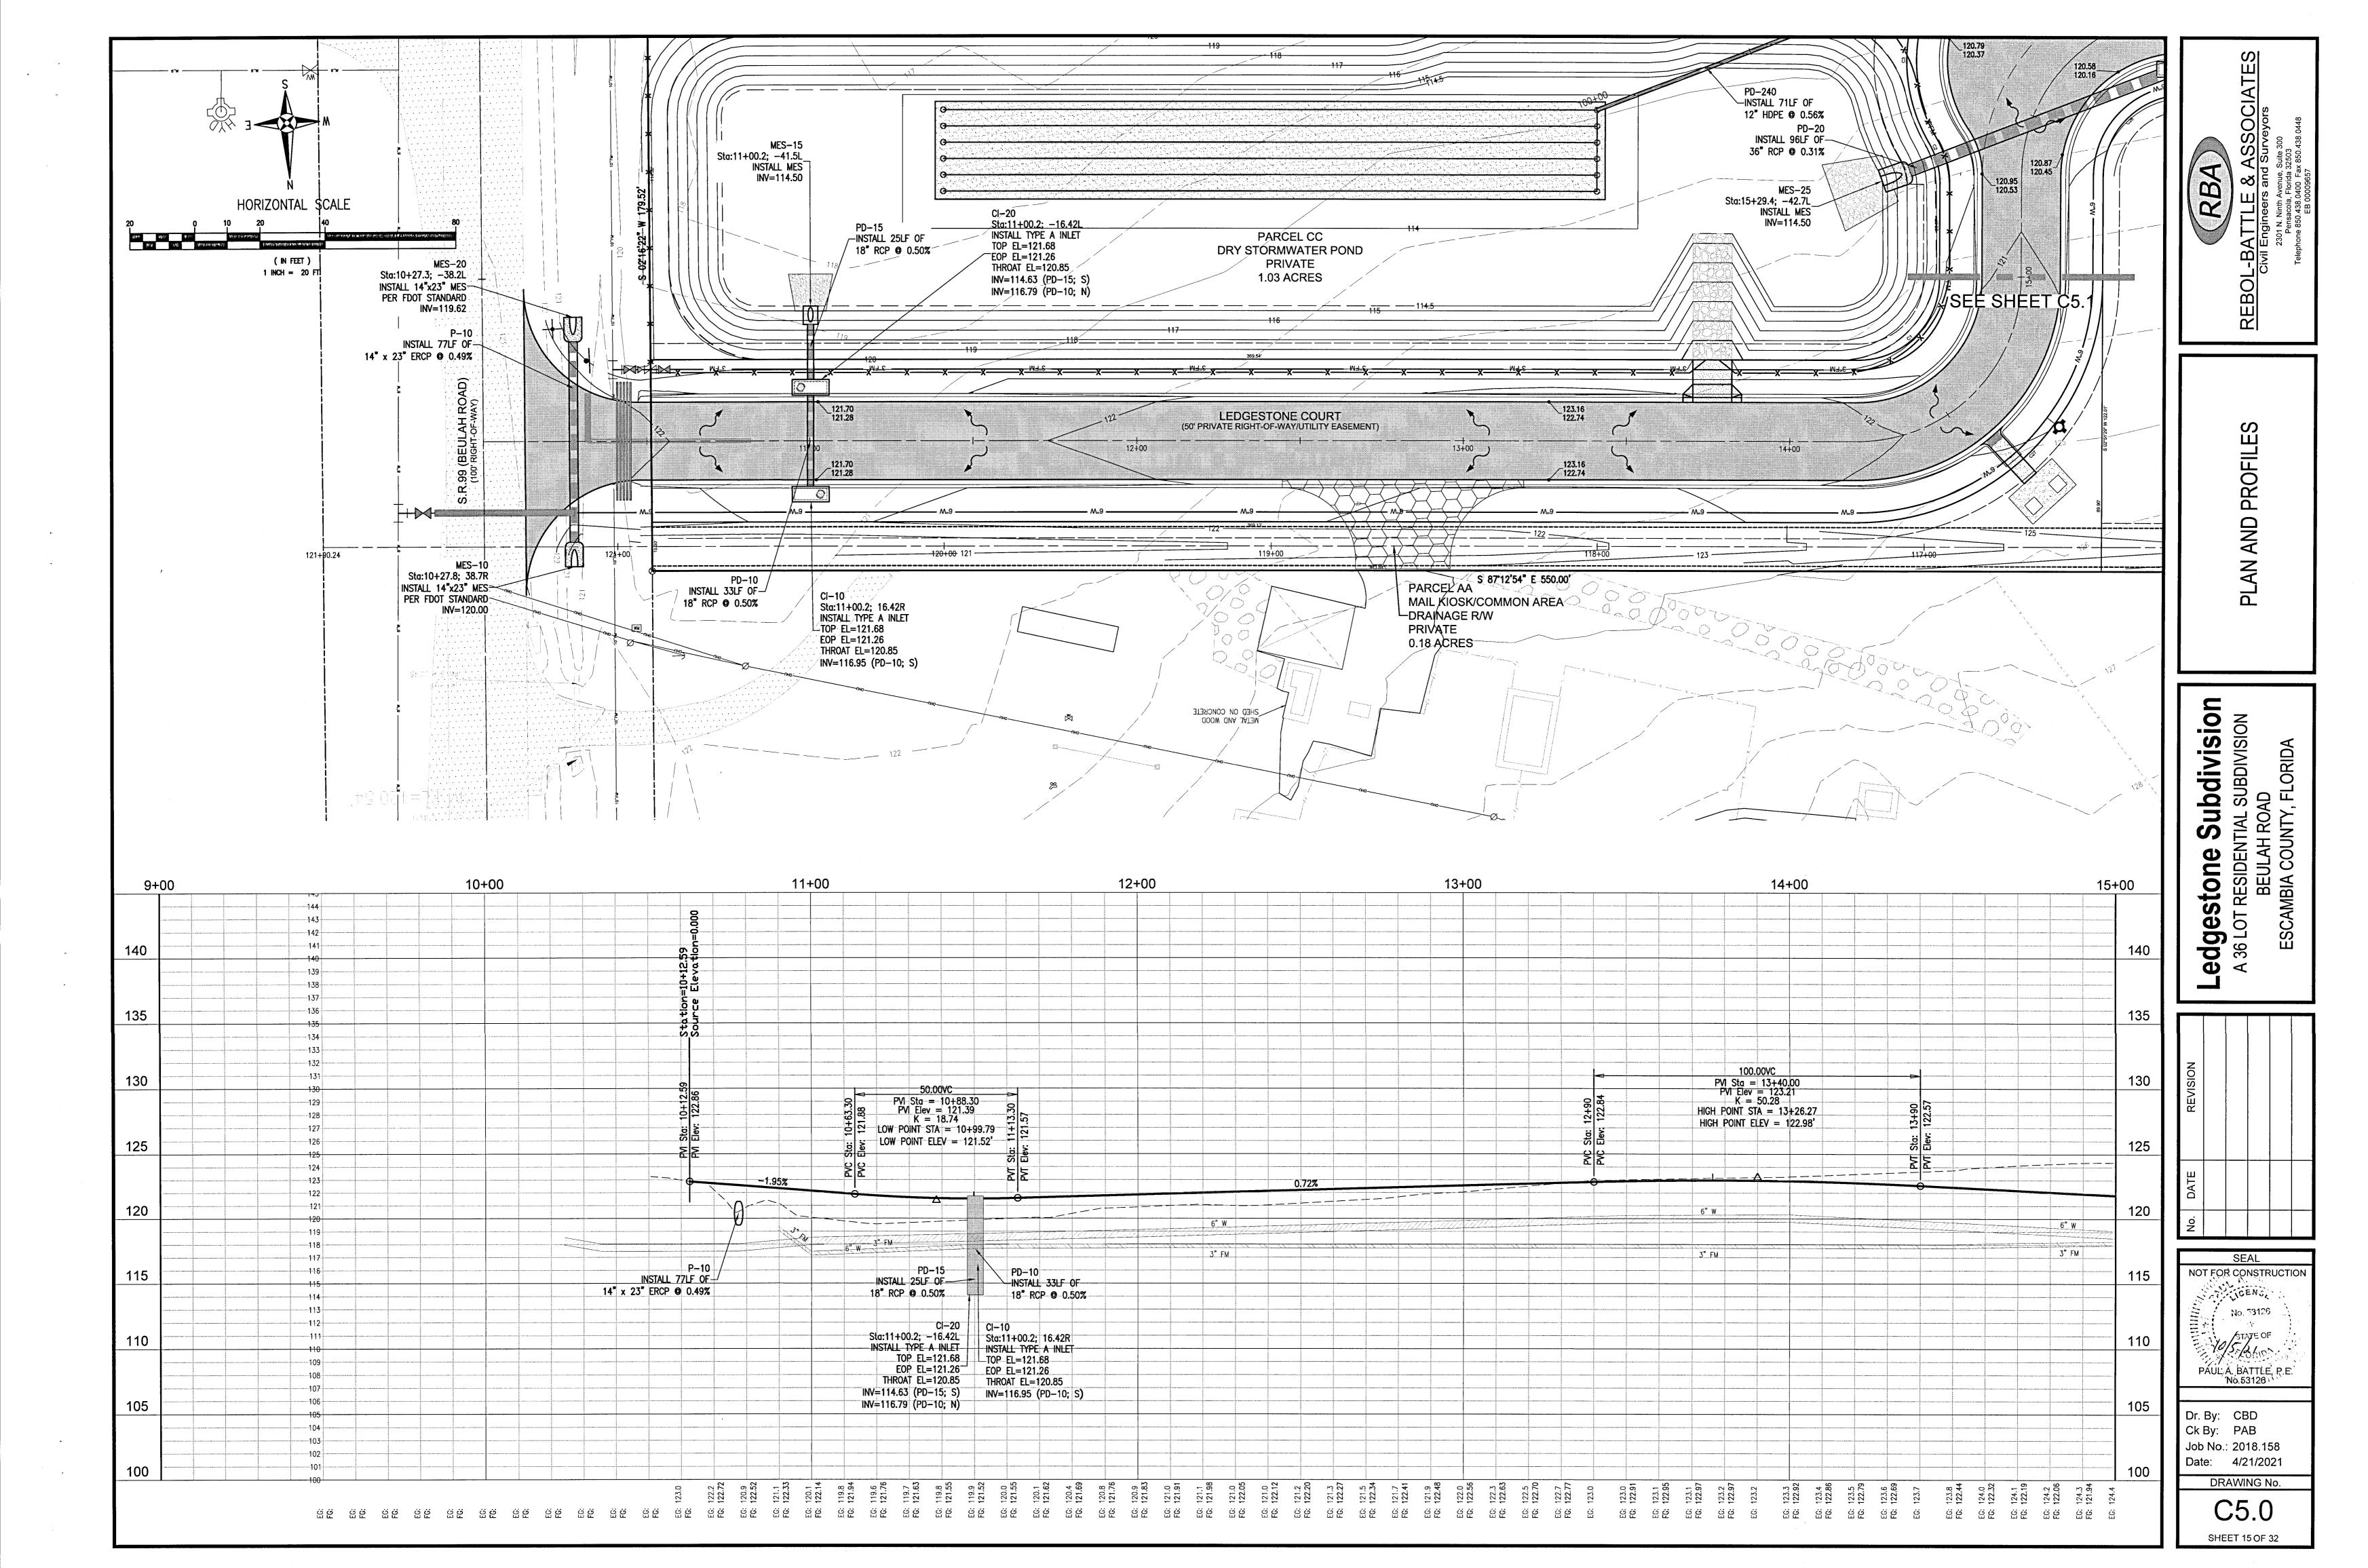

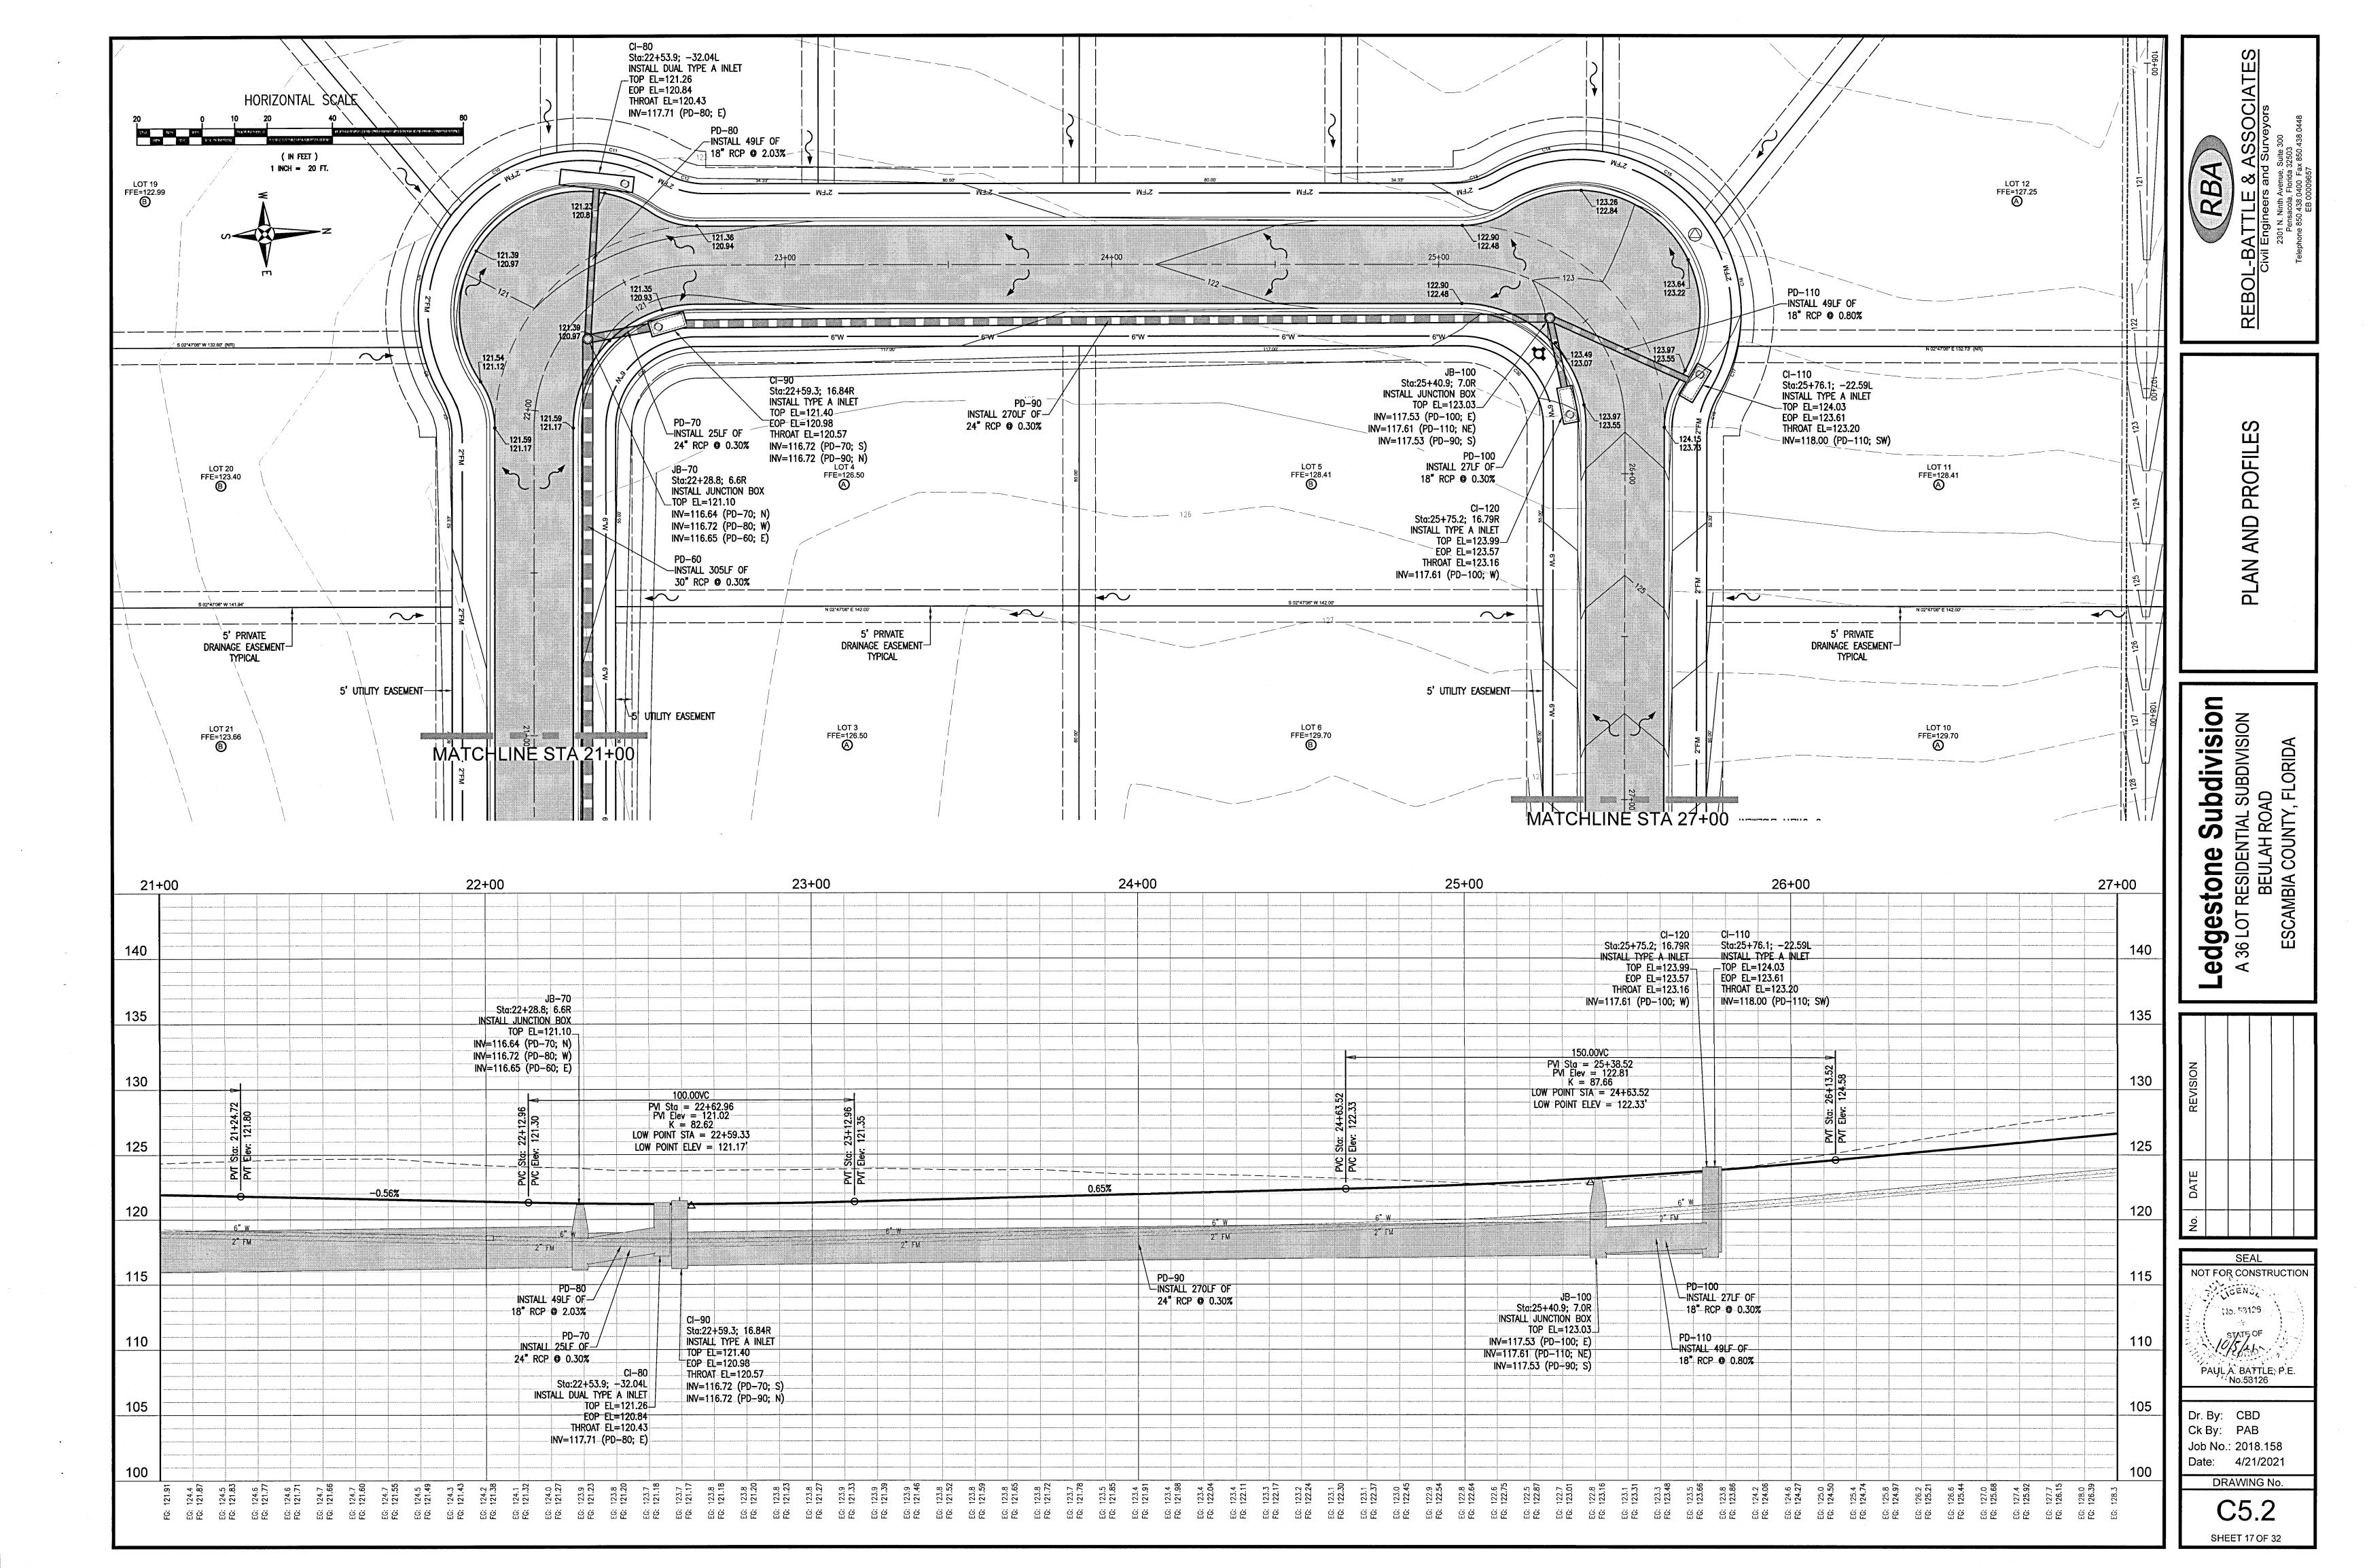

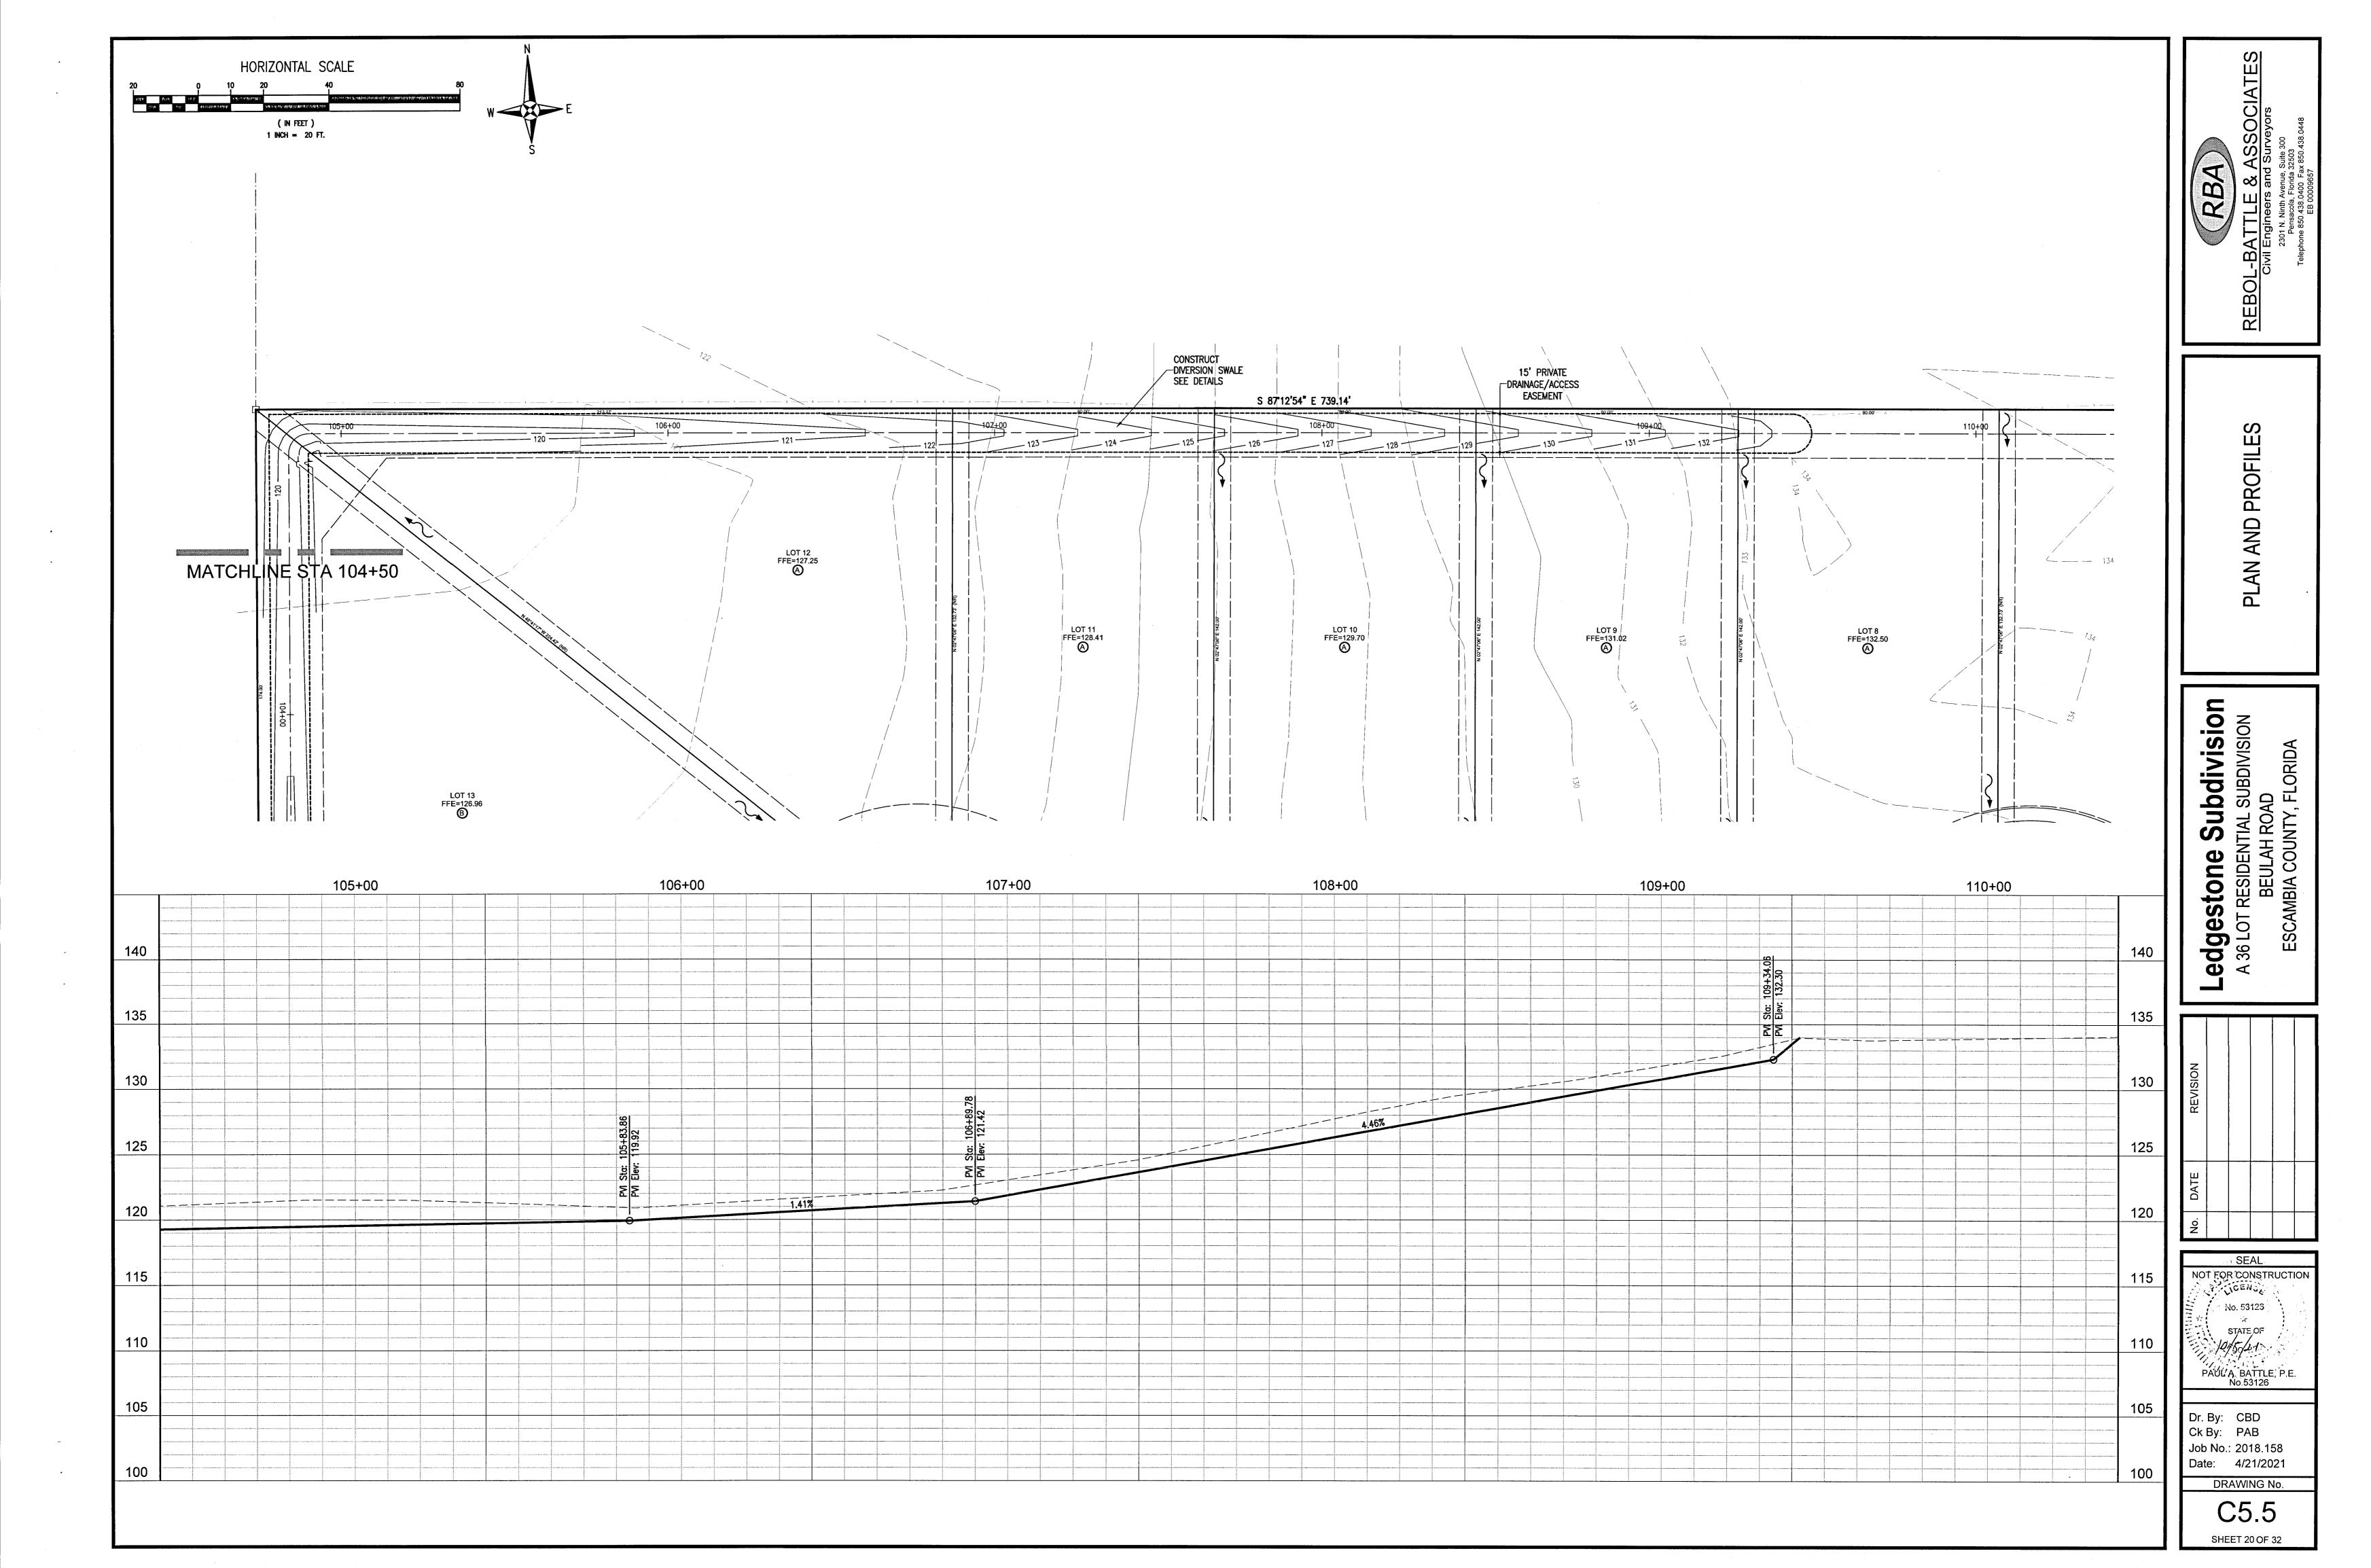

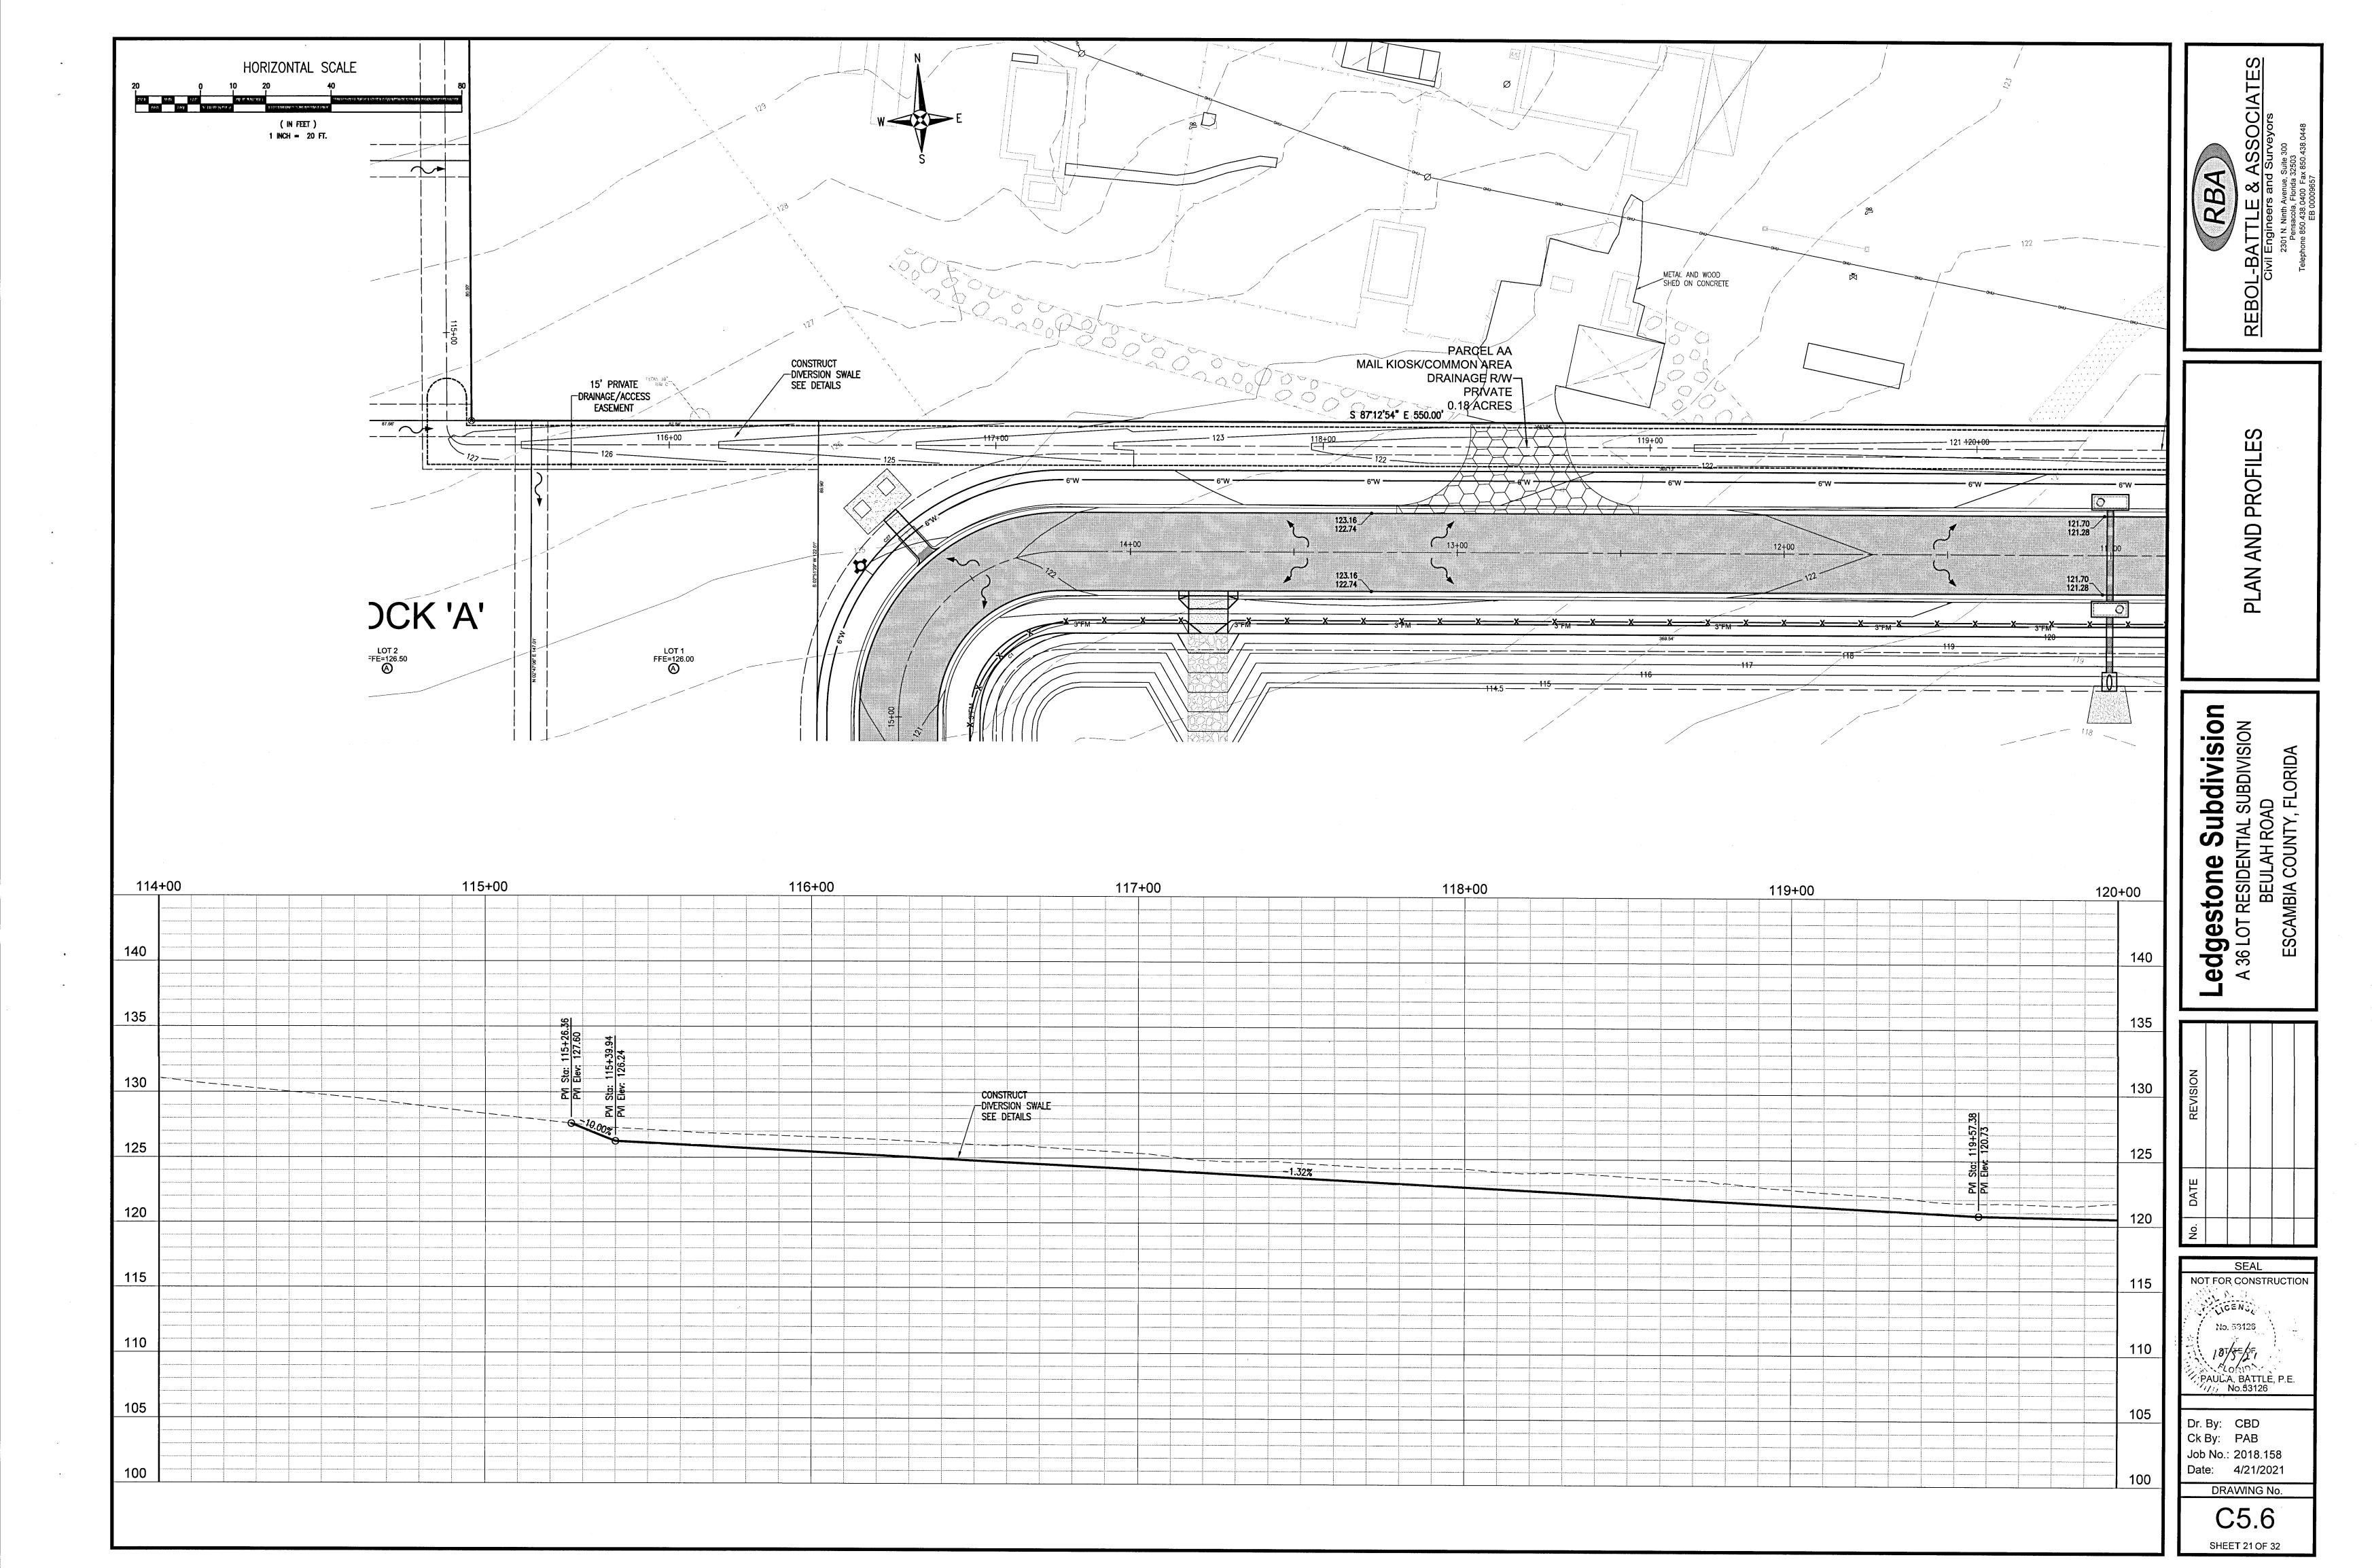

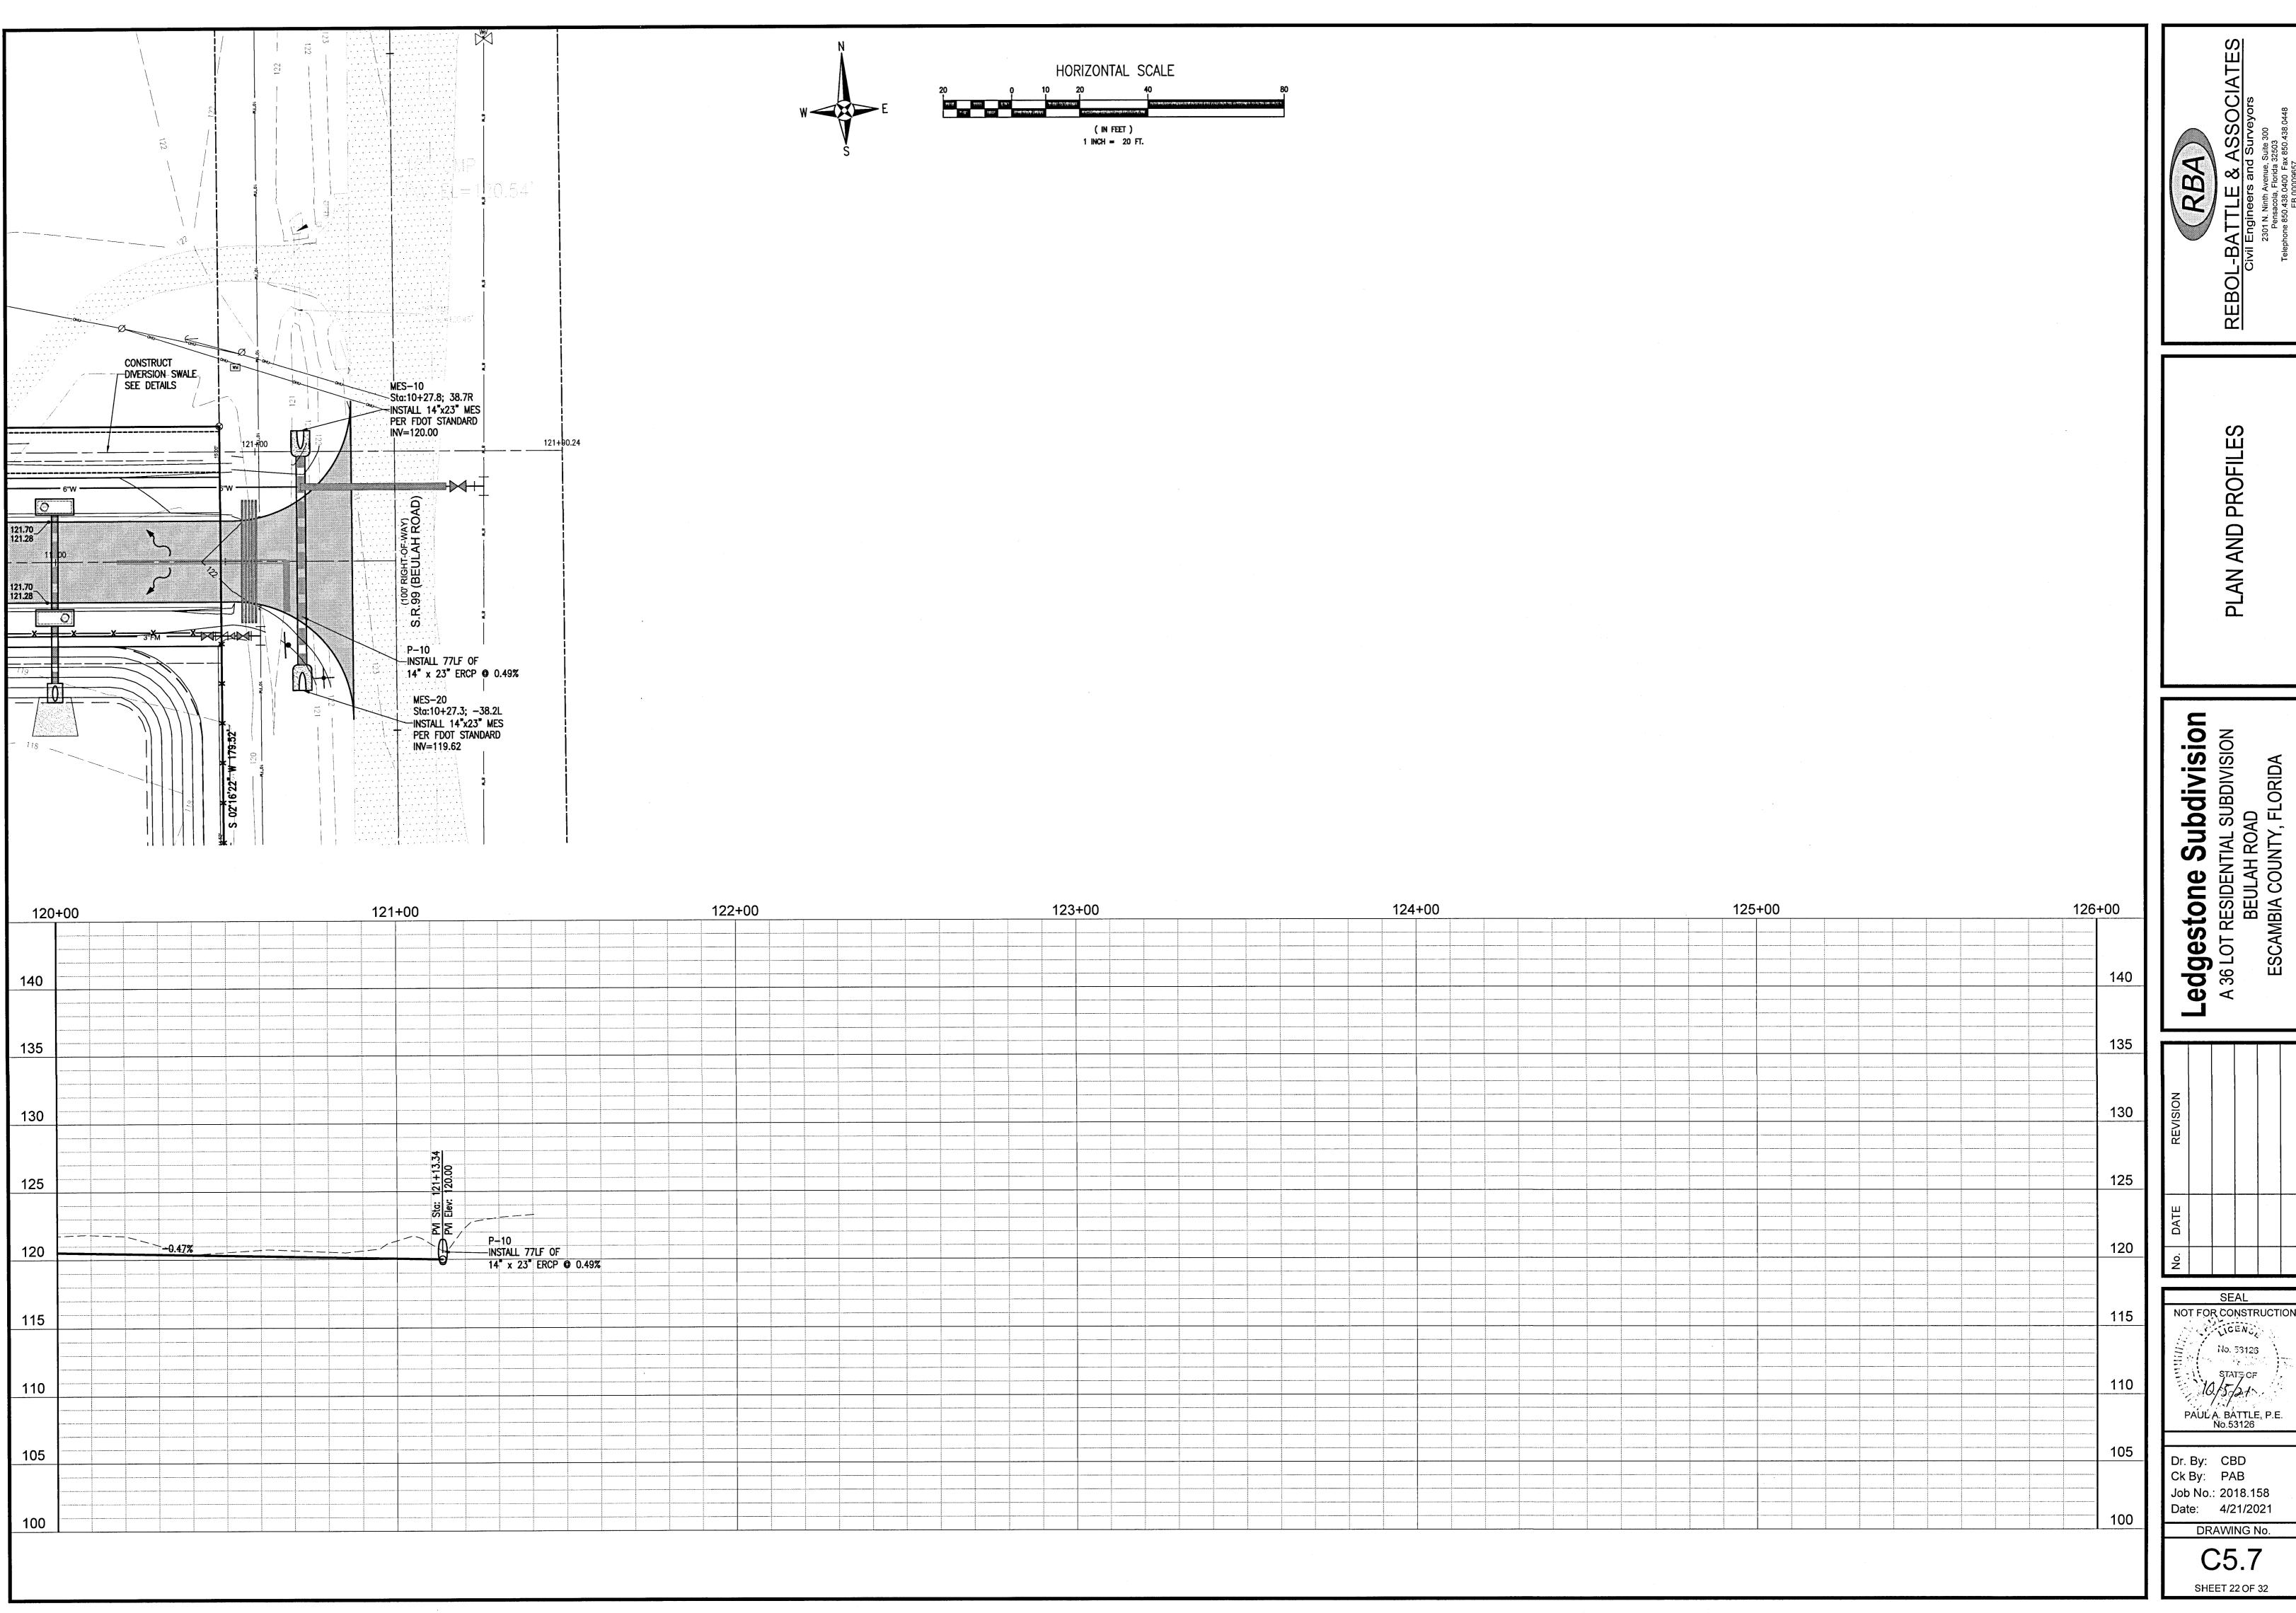

PROFILES AND PLAN


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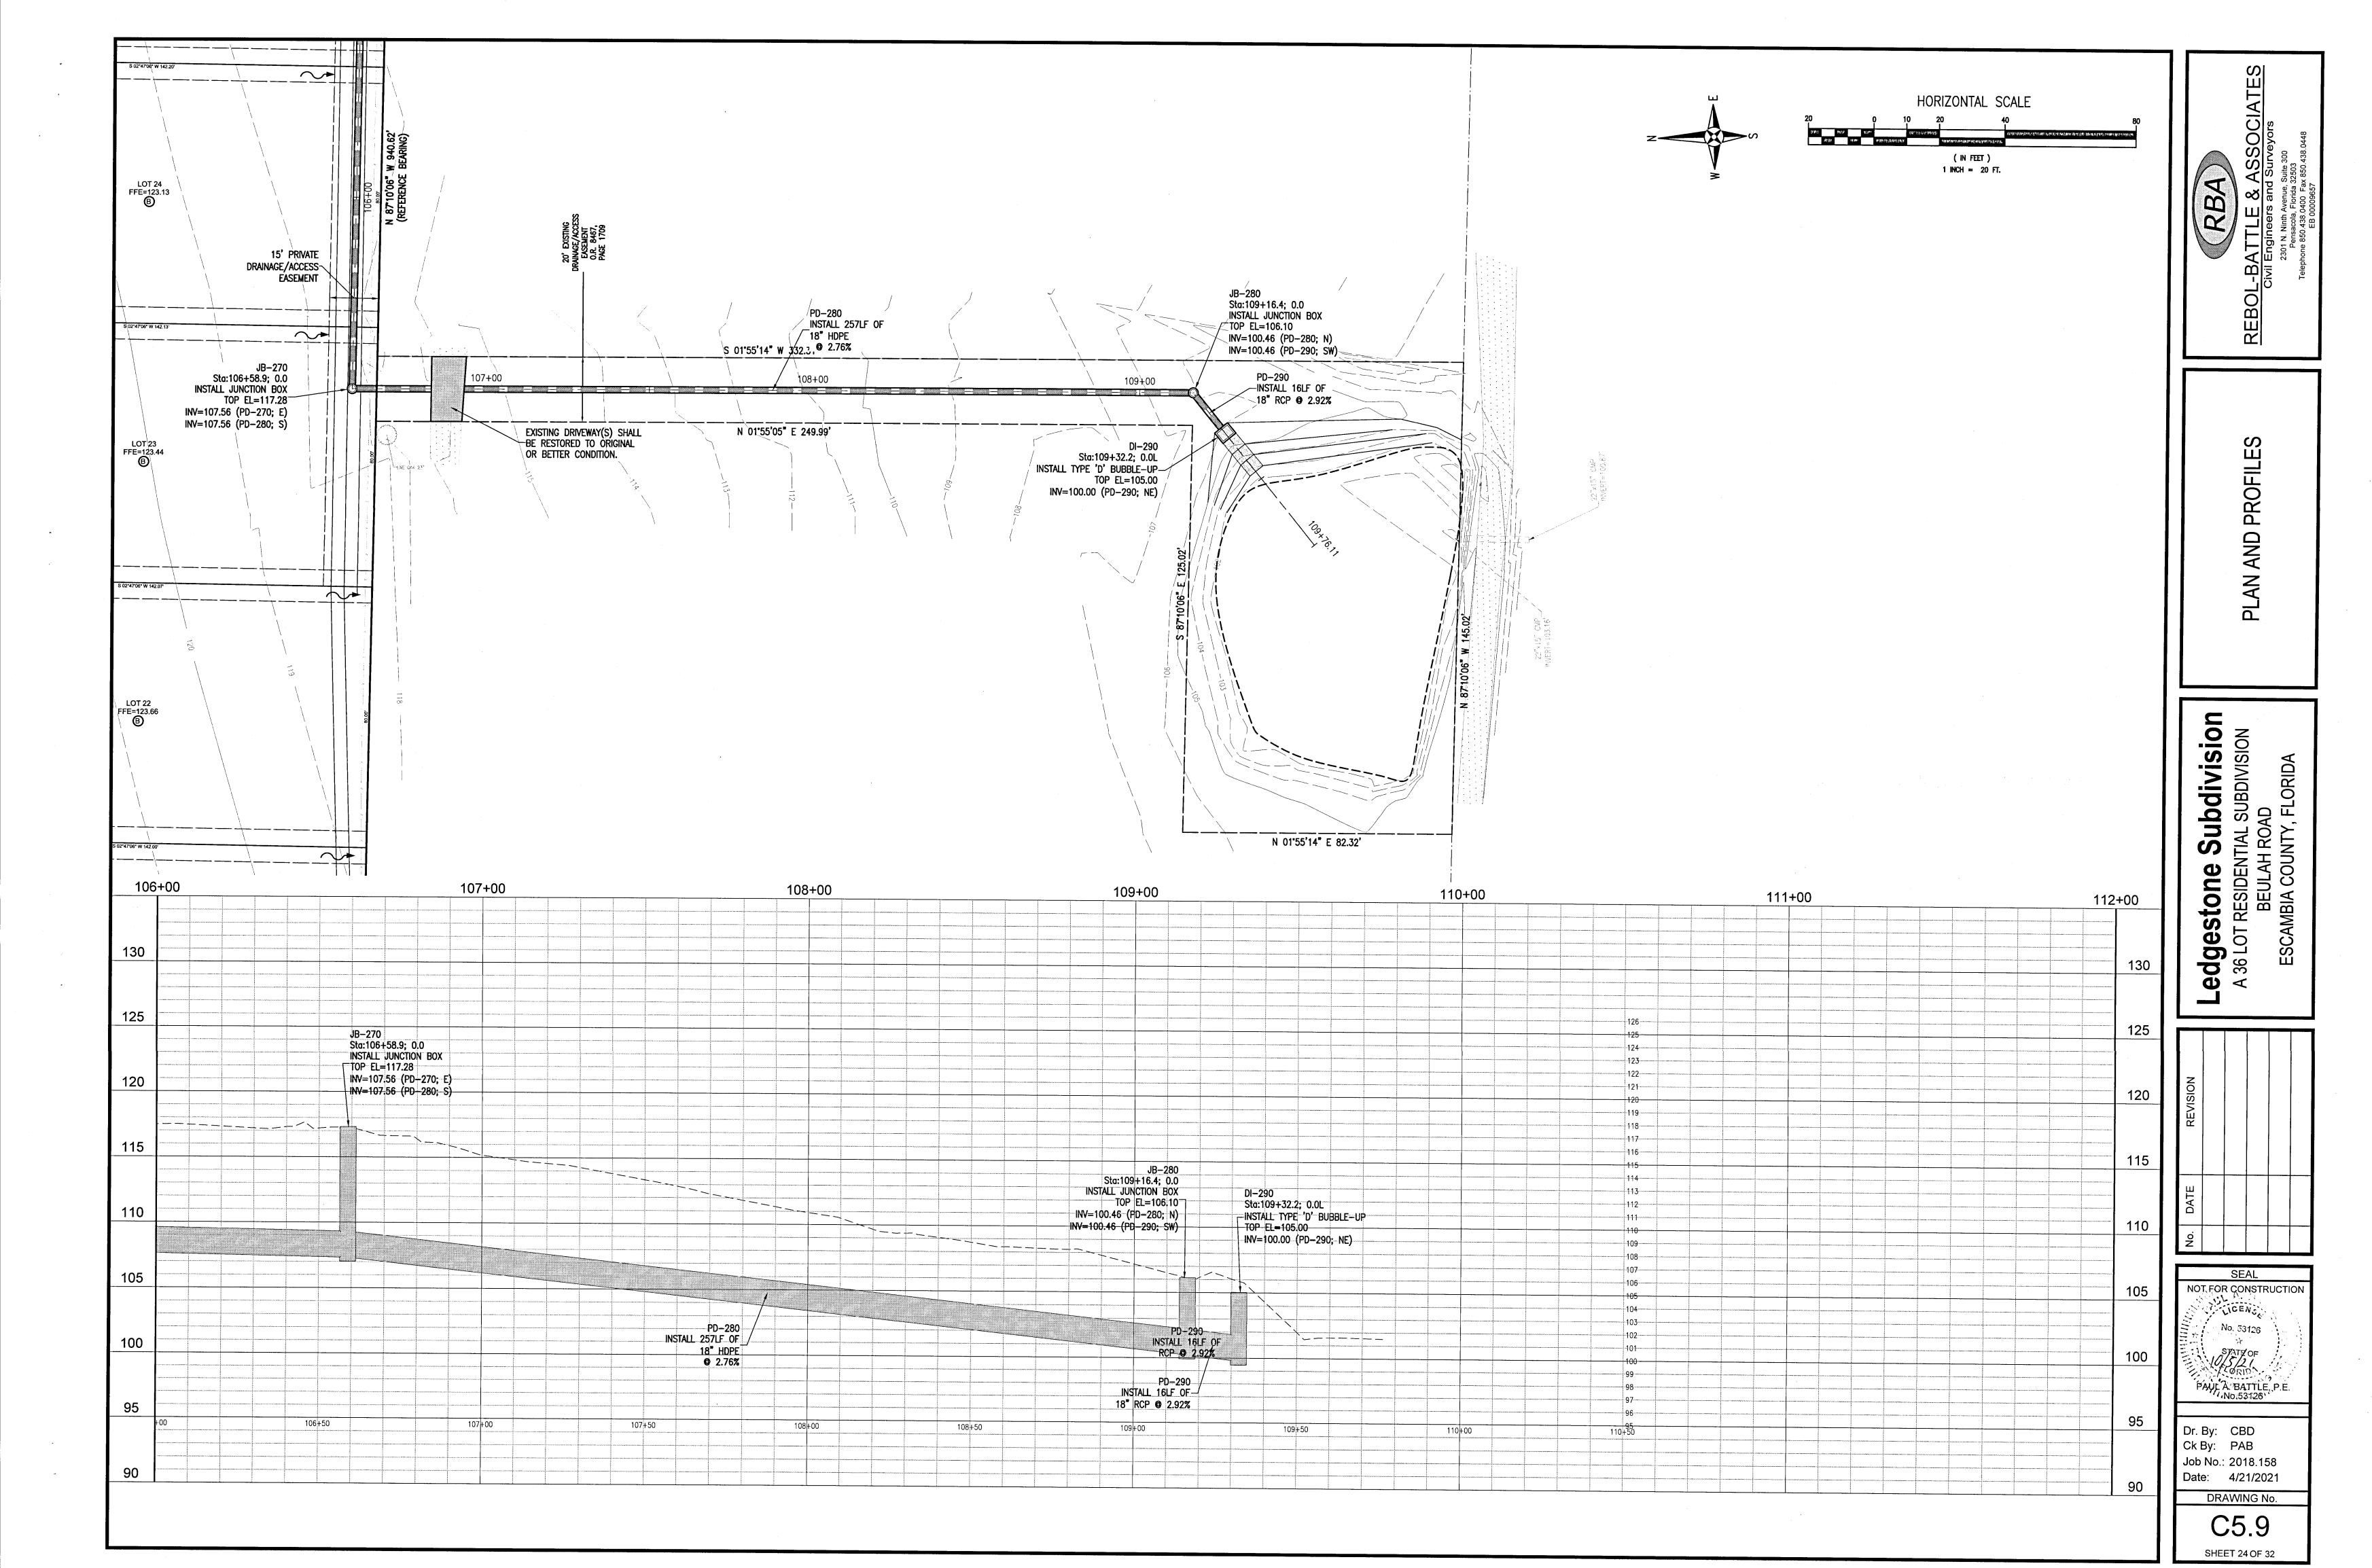
PAUL A. BATTLE, P.E.


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Job No.: 2018.158 Date: 4/21/2021

DRAWING No. C5.7





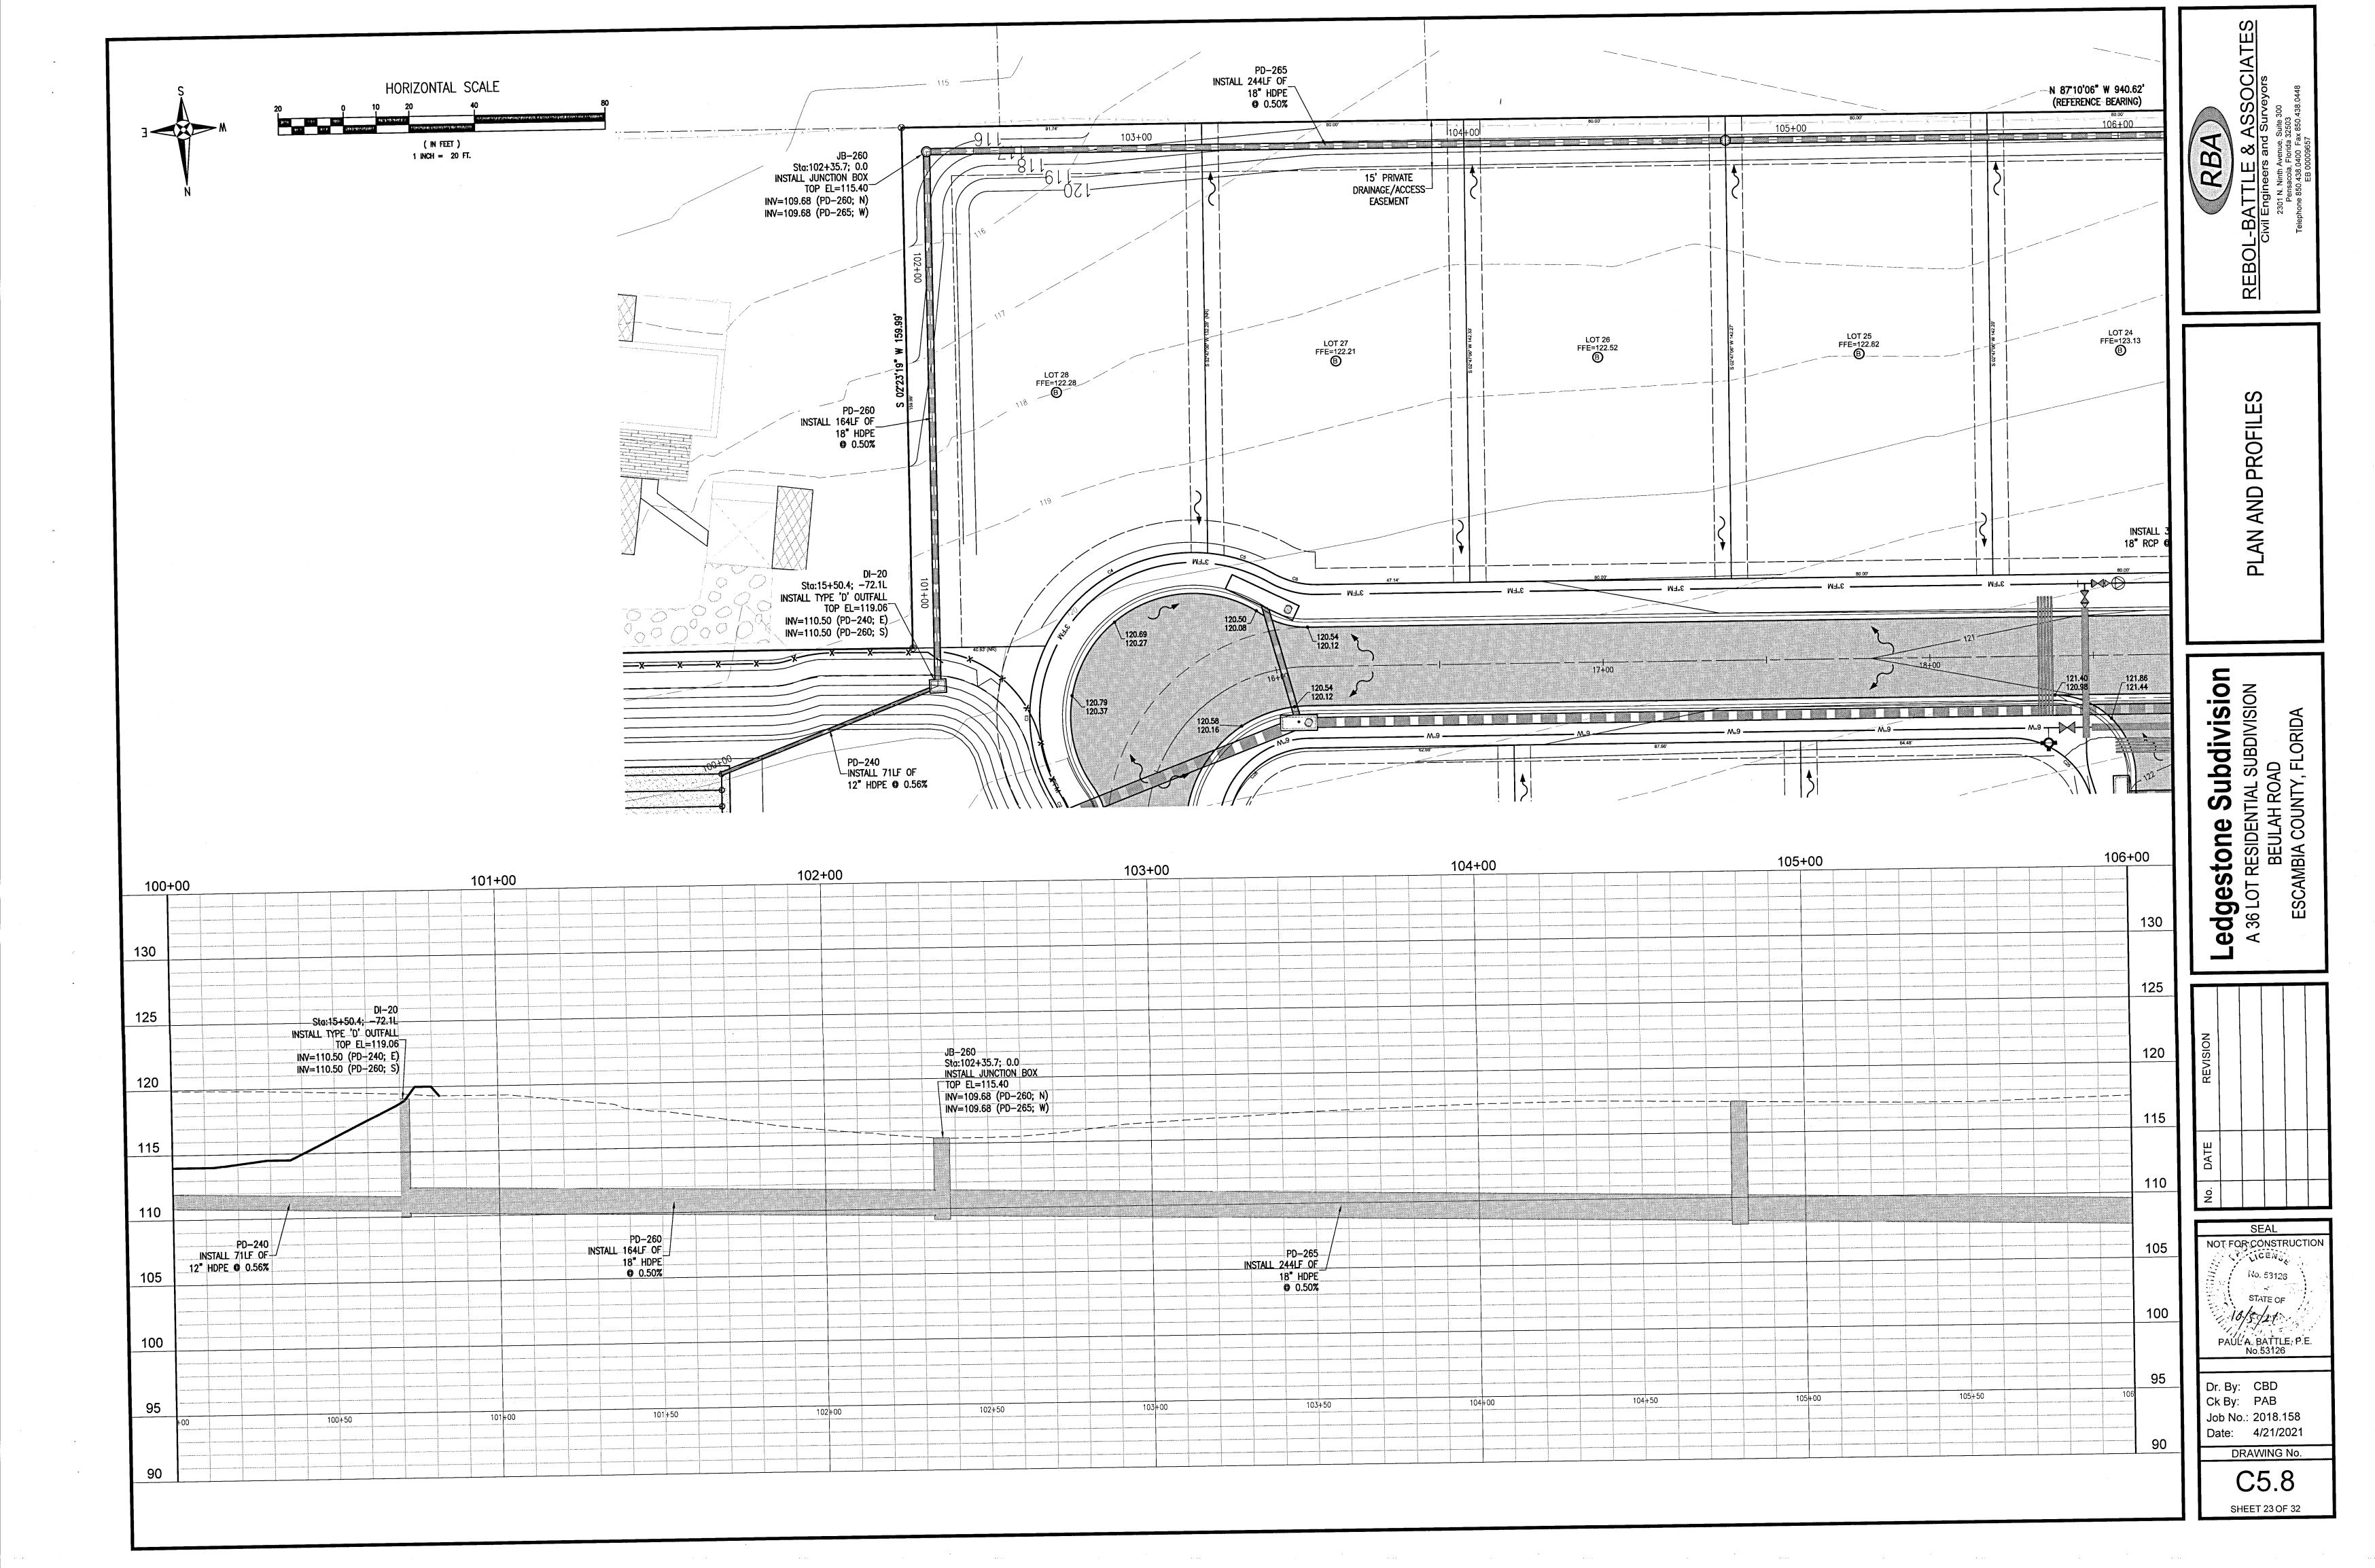

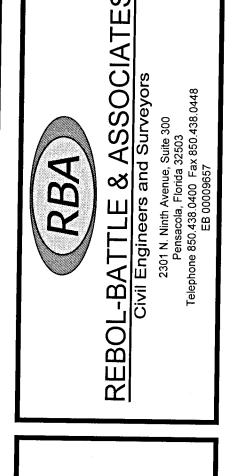PROFILES

AND

Ledgestone Subdivision
A 36 LOT RESIDENTIAL SUBDIVISION
BEULAH ROAD
ESCAMBIA COUNTY, FLORIDA

No. DATE REVISION

SEAL

NOT FOR CONSTRUCTION

No. 53126

No. 53126

PAUL A. BATTLE, P.E.

No. 53126

Dr. By: CBD Ck By: PAB Job No.: 2018.158 Date: 4/21/2021

C6.0

VISION PLAN AND PROFILES

Ledgestone Subdivision
A 36 LOT RESIDENTIAL SUBDIVISION
BEULAH ROAD
ESCAMBIA COUNTY, FLORIDA

No. DATE REVISION

SEAL

NOT FOR CONSTRUCTION

INO. 53126


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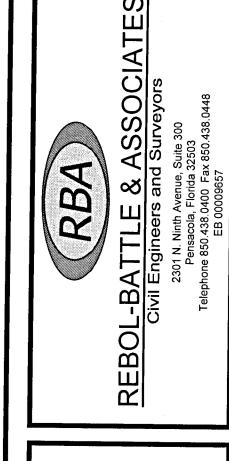
PAUL A: BATTLE, P.E.

No. 53126

Dr. By: CBD Ck By: PAB Job No.: 2018.158 Date: 4/21/2021

C6.1



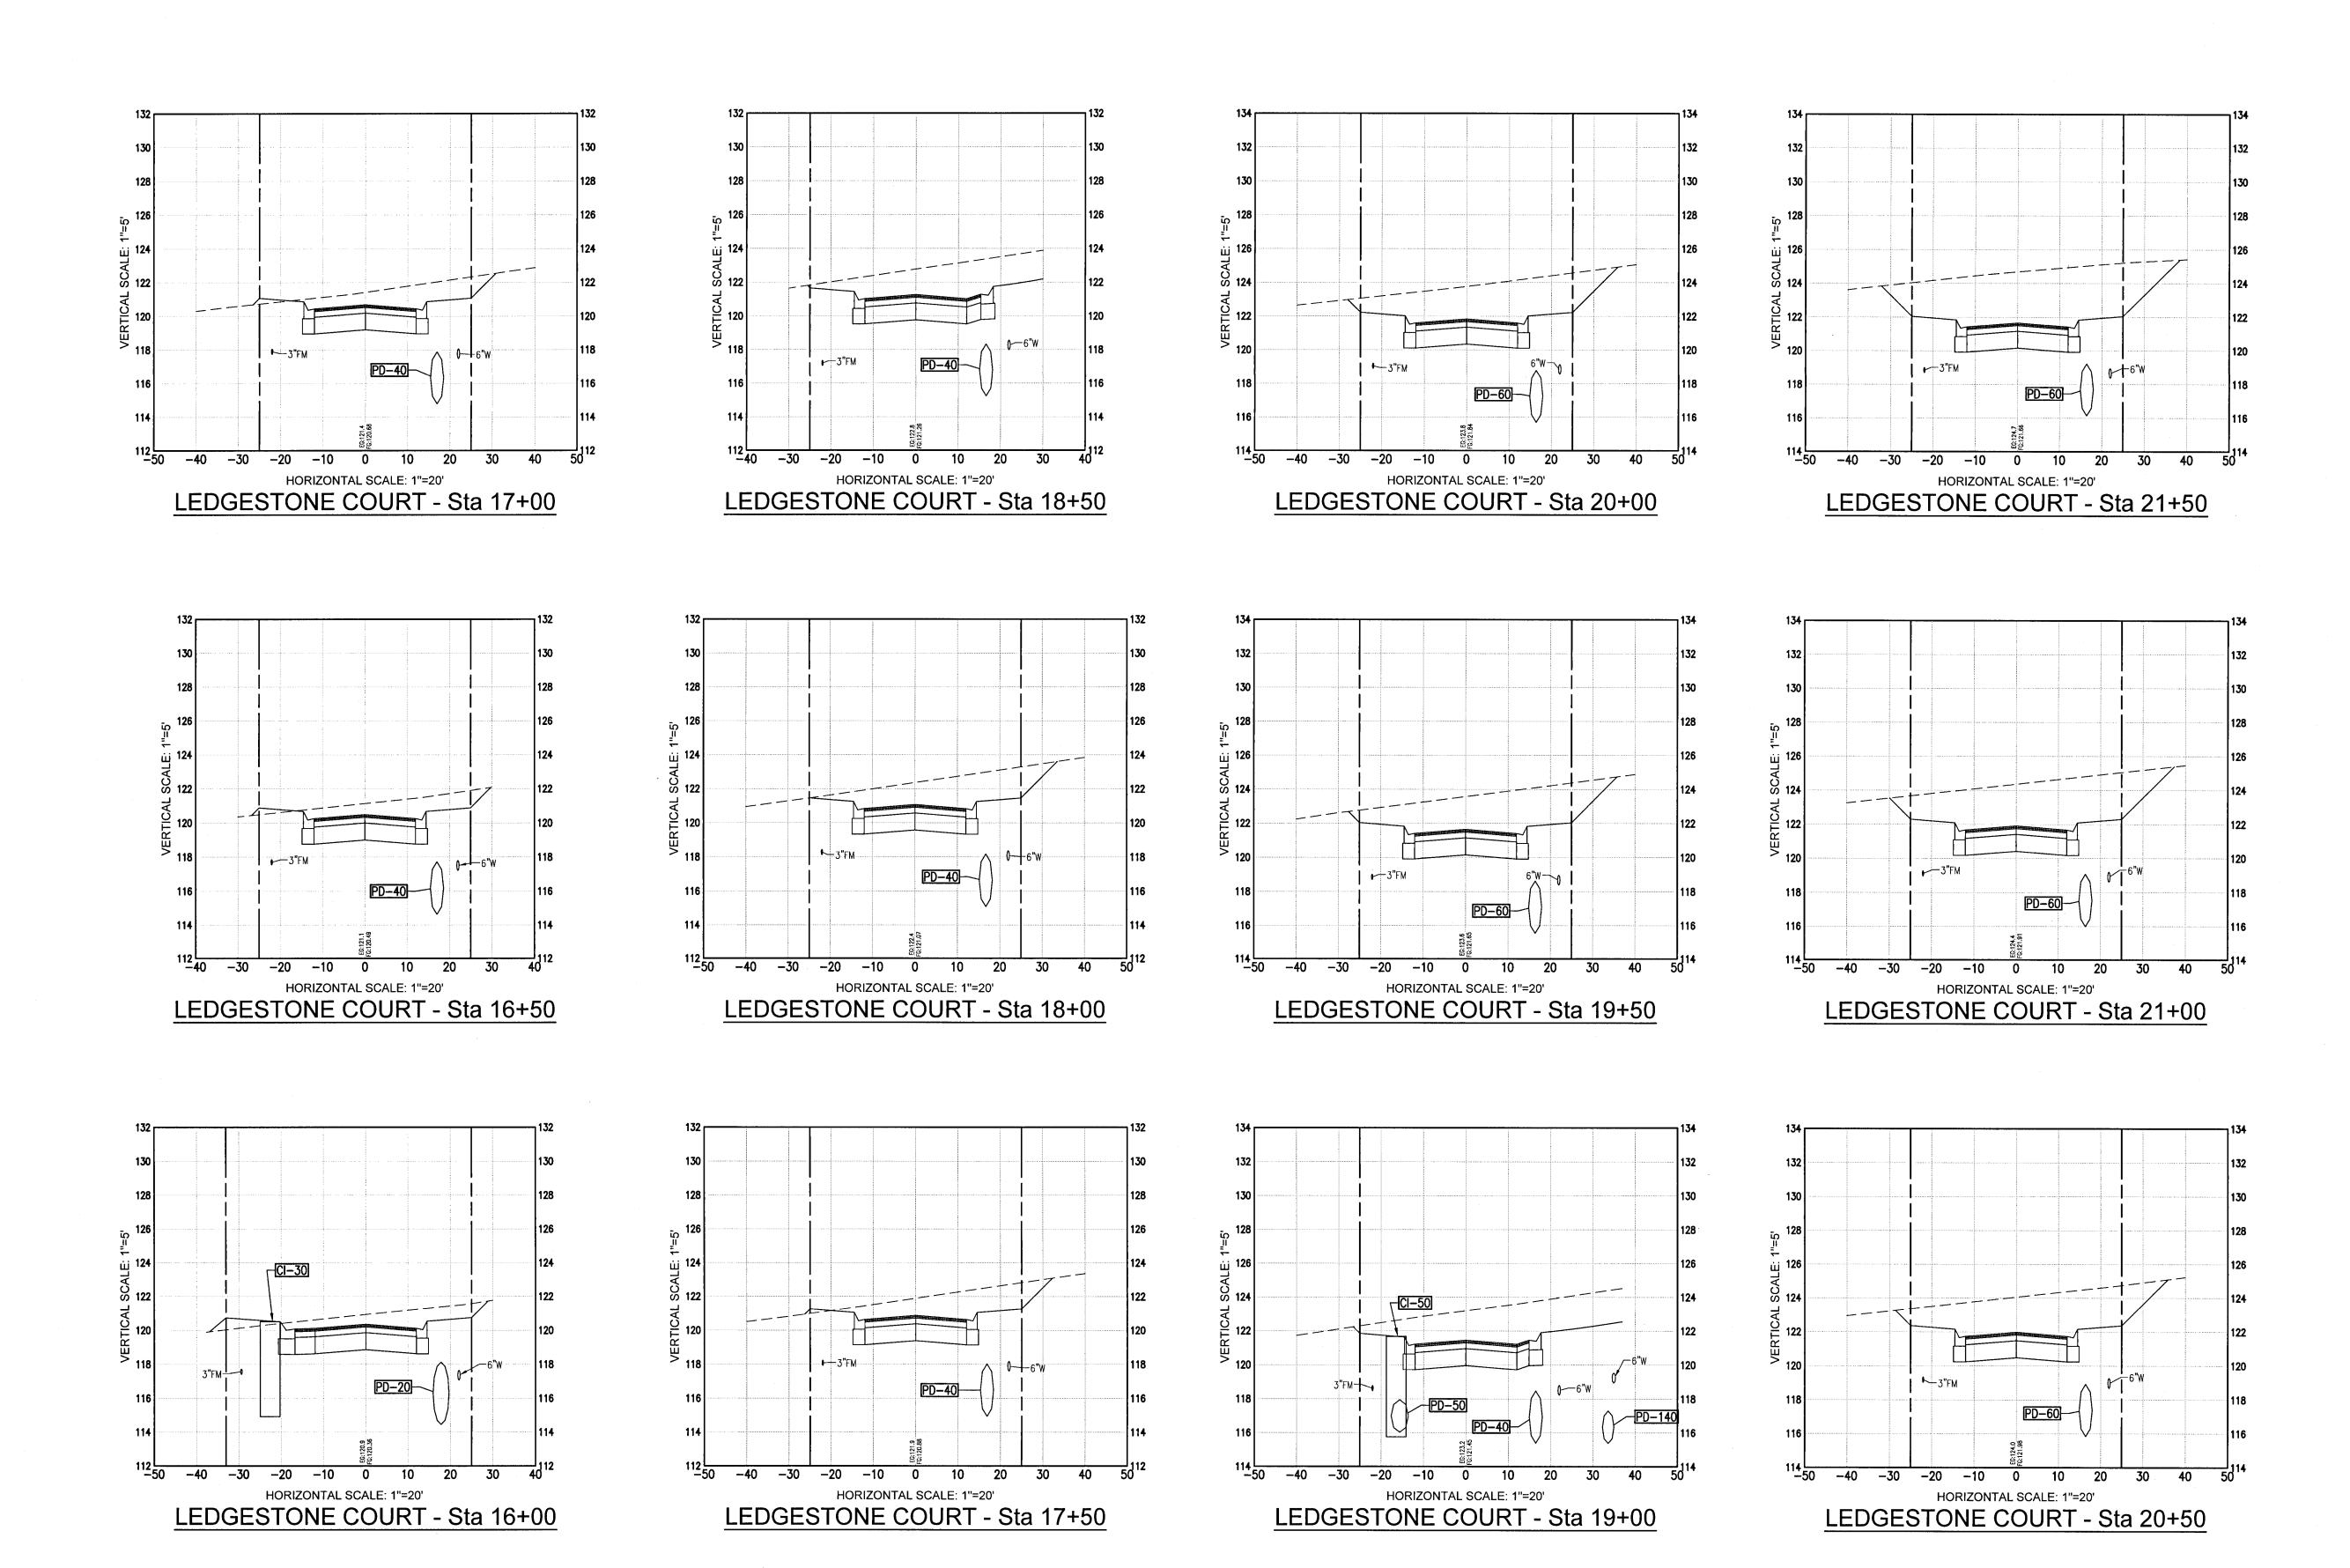

Ledgestone Subdivision
A 36 LOT RESIDENTIAL SUBDIVISION
BEULAH ROAD
ESCAMBIA COUNTY, FLORIDA

SEAL NOT FOR CONSTRUCTION CENCA No. 53126 PAUL A BATTLE, P.E. No.53126

Dr. By: CBD Ck By: PAB Job No.: 2018.158 Date: 4/21/2021

C6.2


DRAWING No. SHEET 27 OF 32

AND

NOT FOR CONSTRUCTION CICENS STATE OF PAULA. BATTLE, P.E. No.53126

Dr. By: CBD Ck By: PAB Job No.: 2018.158 Date: 4/21/2021

DRAWING No. C6.3

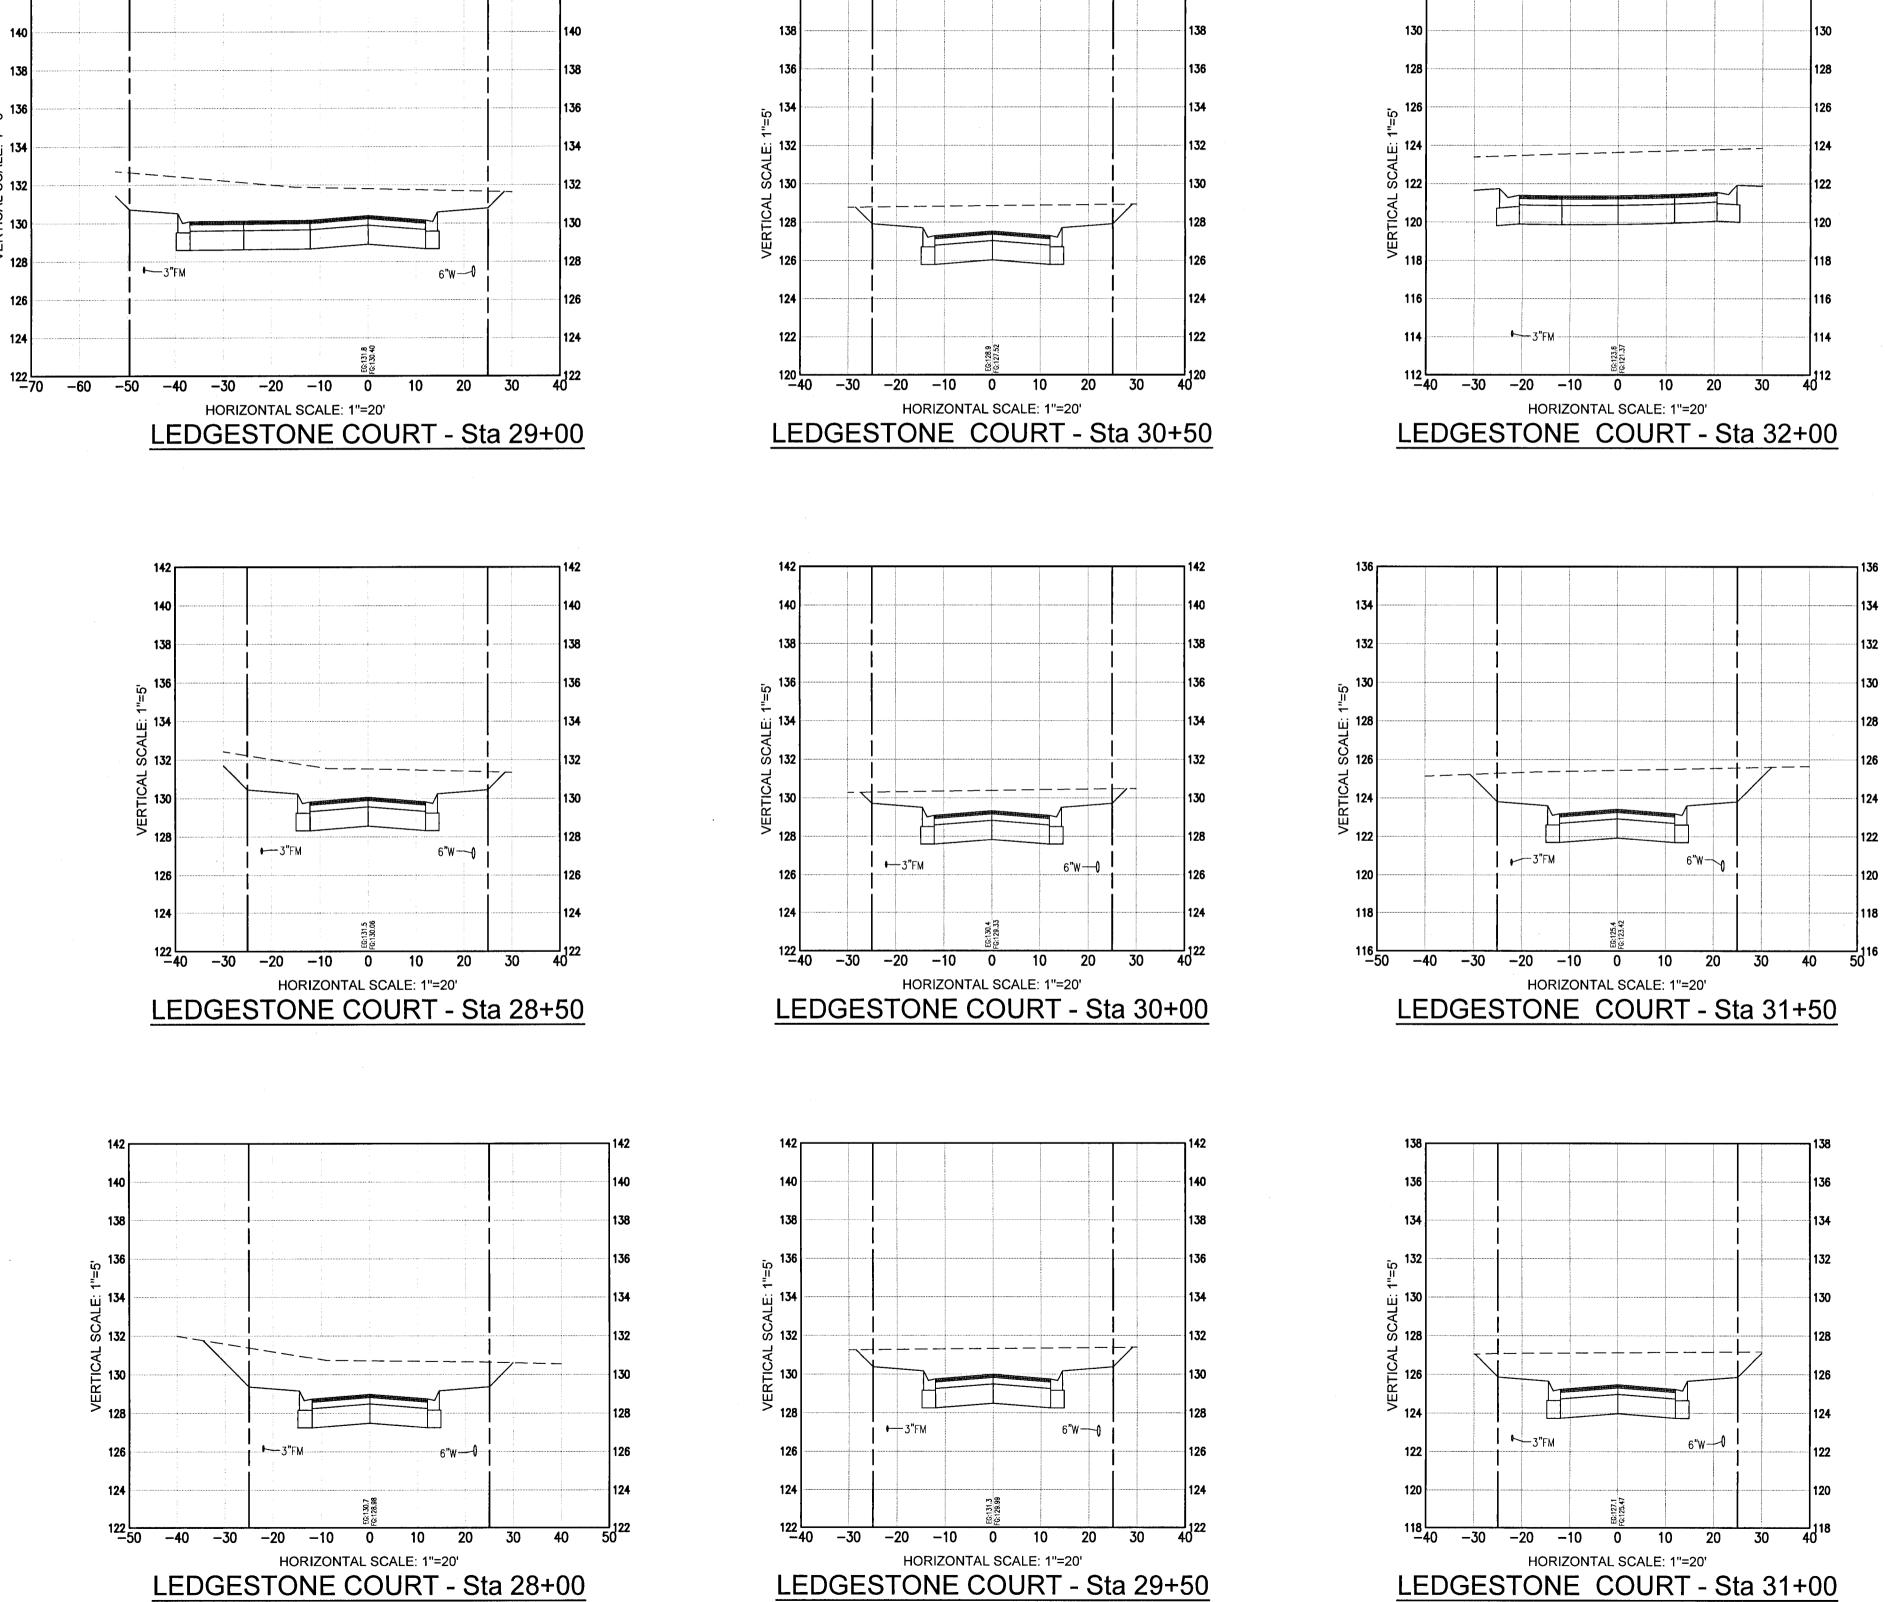

LEDGESTONE COURT - Sta 29+50

LEDGESTONE COURT - Sta 28+00