GECI & ASSOCIATES ENGINEERS, INC. FLORIDA 32534; (850) 484-5770 CONTACT: CLINT GECI, P.E. 2950 NORTH 12th AVENUE PENSACOLA, FLORIDA 32503 PHONE: (850) 432-2929

KJM LAND SURVEYING, LLC. C/O: MICHAEL WATTS AUSTIN 1616 W AVERY STREET PENSACOLA, FL 32501 PHONE: (850) 438-0202

<u>UTILITY COMPANIES:</u>
UTILITY INFORMATION SHOWN AS PER FIELD INFORMATION AND INFORMATION FURNISHED BY UTILITY COMPANIES INVOLVED.

TELEPHONE - AT & T, INC., 605 WEST GARDEN STREET, PENSACOLA, FLORIDA 32501; (850) 436-1616 ELECTRIC - GULF POWER COMPANY, 9220 PINE FOREST ROAD, PENSACOLA,

SANITARY SEWER - EMERALD COAST UTILITY AUTHORITY, ELLYSON INDUSTRIAL

WATER - PEOPLE'S WATER SERVICE COMPANY, 905 LOWNDE AVENUE, PENSACOLA, FLORIDA; (850) 455-8552

PARK, PENSACOLA, FLORIDA; (850) 476-5110

NATURAL GAS - PENSACOLA ENERGY, 16 SOUTH PALAFOX STREET, PENSACOLA, FLORIDA; (850) 474-5322

A. ECUA Engineering Manual Incorporated by Reference

The ECUA Engineering Manual, dated December 18, 2014, along with Update #1 dated September 1, 2016 (hereinafter "Manual"), located at www.ecua.fl.gov, is hereby incorporated by reference into this Project's official contract documents as if fully set forth therein. It is the Contractor's responsibility to be knowledgeable of the Manual's contents and to construct the Project in accordance with the Manual. The Contractor shall provide its employees access to the Manual at all times, via Project site or office, via digital or paper format. In the event of a conflict between the Manual and the Plans, Contractor shall consult Engineer of Record on the appropriate resolution

B. Additional Documents (to be completed by the Engineer of Record)

Does this Project have additional technical specifications or construction details that supercede the Manual listed above?

Yes

No . If yes, Contractor shall construct Project in accordance with said documents as listed and located below:

	Docume	Document Type		Location	
Document Name	Specifi- cation	Detail	Plans	Project Manual*	

*Project Manuals used only with ECUA CIP Projects

C. Engineer of Record Responsibilities

The Engineers of Record (EORs) that have affixed their seals and signatures on these plans warrant their portion of the plans have been designed in accordance with the Manual (unless otherwise directed by the ECUA Project Engineer). The EORs shall be knowledgeable of the Manual's contents and shall assume responsibility for its use on

THE CONTRACTOR SHALL NOTIFY ESCAMBIA COUNTY INSPECTOR 48 HOURS BEFORE BEGINNING OF EVERY PHASE OF CONSTRUCTION (595-3434). THE CONTRACTOR SHALL HAVE ALL EROSION CONTROL IN PLACE PRIOR TO NOTIFYING COUNTY THE PROJECT HAS STARTED.

THE ELECTRIC/PHONE/CABLE/GAS STRUCTURES INSTALLED WITHIN DRAINAGE EASEMENT SHALL BE LOCATED ALONG THE BOUNDARY OF THE EASEMENT TO MAXIMIZE CLEAR ACCESS FOR MAINTENANCE EQUIPMENT.

ALL PROPOSED UNDERGROUND UTILITIES WITHIN R/W'S OR UTILITY CONDUIT FOR ROAD CROSSINGS SHALL BE INSTALLED PRIOR TO PAVING. NO STREETS OR ROADS UNDER THE TWO (2) YEAR WARRANTY WILL BE ALLOWED TO BE OPEN-CUT, OR JACK-AND-BORED. TO ACCOMPLISH THIS REQUIREMENT, COMMON TRENCHING IS REQUIRED WHENEVER POSSIBLE, IF COMMON TRENCHING IS NOT A FEASIBLE OPTION, THE DEVELOPER SHALL INSTALL CONDUIT FOR THE UTILITY NOT PARTICIPATING IN THE COMMON TRENCHING FOR ALL ROAD CROSSINGS AND THE UTILITY COMPANY WILL BE REQUIRED TO USE THE CONDUIT. THIS SHALL REQUIRE PLANNING BETWEEN THE DEVELOPER AND THE UTILITY.

ROUGH GRADE OF RIGHT-OF-WAY MUST BE ESTABLISHED PRIOR TO COMMON TRENCH UTILITY INSTALLATION TO ENSURE UTILITIES ARE INSTALLED AT PROPER DEPTHS. ALL UNDERGROUND UTILITIES MUST MAINTAIN AT LEAST 30" OF GROUND COVER (AFTER ROUGH GRADING OF R/W)

CONTRACTOR NOTE:

CONTRACTOR SHALL BE RESPONSIBLE FOR COMPLYING WITH ALL APPLICABLE REGULATIONS GOVERNING STORMWATER DISCHARGE AND SOLELY RESPONSIBLE FOR ANY DAMAGES CAUSED BY EROSION ONTO PROPERTY OWNED BY OTHERS AND INDEMNIFIES THE OWNER AGAINST ANY CLAIMS OR REGULATORY PENALTIES DURING DEVELOPMENT.

RETENTION / DETENTION POND NOTE:

DEVELOPER/CONTRACTOR/HOME OWNERS ASSOCIATION SHALL RESHAPE PER PLAN SPECIFICATIONS, CLEAN OUT ACCUMULATED SILT. AND STABILIZE RETENTION/DETENTION POND(S) AT THE END OF CONSTRUCTION WHEN ALL DISTURBED AREAS HAVE BEEN STABILIZED AND AT THE END OF THE 2 YEAR WARRANTY PERIOD.

LEGAL DESCRIPTION:

A PORTION OF RESUBDIVISION OF LOT R, BLOCK H, NAVY POINT, BEING A SUBDIVISION OF A PORTION OF SECTION 50, TOWNSHIP 2 SOUTH, RANGE 30 WEST, ESCAMBIA COUNTY, FLORIDA, AS RECORDED IN PLAT BOOK 2, PAGE 26 OF THE PUBLIC RECORDS OF SAID COUNTY, BEING MORE PARTICULARLY DESCRIBED AS FOLLOWS:

BEGIN AT THE NORTHEAST CORNER OF LOT 1 OF SAID RESUBDIVISION OF LOT R, BLOCK H, NAVY POINT; THENCE RUN SOUTH 27 DEGREES 20 MINUTES 54 SECONDS EAST ALONG THE WESTERLY RIGHT-OF-WAY LINE OF

GIBBS ROAD (PLAT = PARK PLACE), (80' R/W) A DISTANCE OF 534.82 FEET; THENCE DEPARTING SAID WESTERLY RIGHT-OF-WAY LINE RUN SOUTH 62 DEGREES 28 MINUTES 36 SECONDS WEST, A DISTANCE OF 245.97 FEET;

THENCE RUN SOUTH 16 DEGREES 48 MINUTES 18 SECONDS EAST, A DISTANCE OF 61.13 FEET; THENCE RUN SOUTH 37 DEGREES 24 MINUTES 51 SECONDS WEST, A DISTANCE OF 54.23 FEET TO A POINT ON THE NORTHERLY RIGHT-OF-WAY LINE OF A 15 FOOT WIDE ALLEY; THENCE RUN NORTH 89 DEGREES 33 MINUTES 22 SECONDS WEST ALONG SAID NORTHERLY RIGHT-OF-WAY LINE, A

DISTANCE OF 132.79 FEET; THENCE RUN SOUTH 72 DEGREES 12 MINUTES 56 SECONDS WEST ALONG SAID NORTHERLY RIGHT-OF-WAY LINE, A

DISTANCE OF 63.22 FEET; THENCE RUN NORTH 67 DEGREES 43 MINUTES 59 SECONDS WEST ALONG SAID NORTHERLY RIGHT-OF-WAY LINE, A DISTANCE OF 30.62 FEET;

15' WIDE ALLEY, A DISTANCE OF 276.65 FEET; THENCE RUN NORTH 12 DEGREES 48 MINUTES 39 SECONDS EAST ALONG SAID EASTERLY RIGHT-OF-WAY LINE, A DISTANCE OF 30.42 FEET; THENCE RUN NORTH 47 DEGREES 56 MINUTES 38 SECONDS EAST ALONG THE SOUTHERLY RIGHT-OF-WAY LINE OF

THENCE RUN NORTH 27 DEGREES 40 MINUTES 53 SECONDS WEST ALONG THE EASTERLY RIGHT-OF-WAY LINE OF SAID

SAID 15' WIDE ALLEY, A DISTANCE OF 92.12 FEET; THENCE RUN NORTH 32 DEGREES 44 MINUTES 40 SECONDS EAST ALONG SAID SOUTHERLY RIGHT-OF-WAY LINE, A DISTANCE OF 176.76 FEET;

THENCE RUN NORTH 24 DEGREES 32 MINUTES 47 SECONDS EAST ALONG SAID SOUTHERLY RIGHT-OF-WAY LINE, A DISTANCE OF 124.61 FEET: THENCE RUN NORTH 39. DEGREES 48 MINUTES 39 SECONDS EAST ALONG SAID SOUTHERLY RIGHT-OF-WAY LINE, A

DISTANCE OF 91.40 FEET; THENCE RUN NORTH 63 DEGREES 19 MINUTES 46 SECONDS EAST ALONG SAID SOUTHERLY RIGHT-OF-WAY LINE, A DISTANCE OF 63.25 FEET TO THE POINT OF BEGINNING.

This document has been reviewed in accordance with equirements of applicable Escambia County Regulations and Ordinances and does not in any way relieve the submitting Architect, Engineer, Surveyor, or other signatory from responsibility of details as drawn.

Imperv. Surf. 39750.0 Sq ft

Stormwater Ret. 0.81 % (F)

Total Drainage Fee \$ 1,609.88

Pond Maint. Fee: MSBU

SITEWORK CONSTRUCTION PLANS

PLESS LANDING

DRAINAGE FEE

60 LOT SINGLE-FAMILY TOWNHOME SUBDIVISION

ESCAMBIA COUNTY, FLORIDA

G&A REFERENCE NO. 28807

UTILITIES.

DATUM PLAN USED IS NAVD OF 88. BOUNDARY SURVEY & LEGAL DESCRIPTION PROVIDED BY KJM LAND SURVEYING, LLC. DATED JULY 21, 2021.

ALL FINISHED PAVING GRADES SHOWN HERERON ARE TOP OF PAVEMENT GRADES, UNLESS SHOWN OTHERWISE 4. LOCATION OF EXISTING UTILITIES WERE TAKEN FROM THE RECORDS OF APPROPRIATE UTILITY COMPANIES AND HAVE NOT BEEN VERIFIED BY THE OWNER OR IT'S REPRESENTATIVE. THE CONTRACTOR SHALL DETERMINE THE EXACT LOCATION OF ALL EXISTING UTILITIES BEFORE COMMENCING WORK, AND IS FULLY RESPONSIBLE FOR ANY AND ALL DAMAGES THAT MIGHT BE OCCASIONED BY THE CONTRACTOR'S FAILURE TO EXACTLY LOCATE AND PRESERVE ANY AND ALL ABOVE GROUND AND UNDERGROUND

5. ALL SANITARY SEWER CONSTRUCTION TO CONFORM TO THE CURRENT EMERALD COAST UTILITY AUTHORITY STANDARDS. 6. ALL POTABLE WATER CONSTRUCTION TO CONFORM TO THE CURRENT PEOPLE'S WATER SERVICE COMPANY STANDARDS.

7. ALL PAVING AND STORM DRAINAGE CONSTRUCTION TO CONFORM TO THE ESCAMBIA COUNTY STANDARDS AND F.D.O.T. STANDARDS. R/W SHOULDER STABILIZATION TO CONFORM WITH FDOT STANDARD SPECIFICATIONS FOR ROAD AND BRIDGE

8. WORK PROPOSED NEXT TO THE R/W WITH EXISTING SWALES SYSTEMS MAY REQUIRE ADDITIONAL PROVISIONS TO REPAIR/RESTORE EXISTING DRAINAGE SWALES AS NEEDED TO ENSURE ADEQUATE DRAINAGE. 9. TO ASSURE THE CONTRACTOR IS ON THE SAME VERTICAL AND HORIZONTAL DATUM AS THIS SURVEY, IT IS STRONGLY

RECOMMENDED THAT VERTICAL CHECKS BE MADE BETWEEN TWO BENCHMARKS AND THAT HORIZONTAL CHECKS BE MADE BETWEEN THREE CONTROL POINTS OR PROPERTY CORNERS. 10. THE CONTRACTOR SHALL NOTIFY F.D.O.T., NWFWMD, EMERALD COAST UTILITIES AUTHORITY, AND THE COUNTY DESIGNEE AND/OR

INSPECTOR AT LEAST THREE WORKING DAYS (72 HOURS MIN.) PRIOR TO THE INITIATION OF CONSTRUCTION. 11. THE CONTRACTOR SHALL DISPOSE OF ALL SURPLUS EARTH OFF THE SITE. 12. THE CONTRACTOR SHALL HAVE A COMPACTION TEST MADE BY AN INDEPENDENT TESTING LAB AT INTERVALS NOT TO EXCEED

300 LINEAR FEET, AND THESE TESTS SHALL INDICATE THAT THE BASE CONSTRUCTION IS IN ACCORDANCE WITH SECTION 240 OF THE D.O.T. SPECIFICATIONS. COPIES OF THESE SHALL BE FURNISHED TO THE ENGINEER. 13. THE CONTRACTOR SHALL NOTIFY THE ENGINEER AT LEAST TWO WEEKS PRIOR TO THE PLACING OF THE BASE MATERIAL TO

HELP THE ENGINEER COORDINATE THE OTHER UNDERGROUND UTILITIES. 14. THE CONTRACTOR SHALL GRASS AND MULCH ALL THE RIGHT-OF-WAY AND DISTURBED AREAS UNLESS AT A SLOPE OF 5 TO 1

OR GREATER AND THESE SHALL BE SODDED AND PINNED. 15. THE CONTRACTOR SHALL PLACE AND MAINTAIN ADEQUATE BARRICADES, CONSTRUCTION SIGNS, FLASHING LIGHTS, TORCHES, RED LANTERNS AND GUARDS DURING PROGRESS OF CONSTRUCTION WORK AND UNTIL IT IS SAFE FOR BOTH PEDESTRIAN AND

16. ADEQUATE PROVISIONS SHALL BE MADE FOR FLOW OF SEWERS, DRAINS, AND WATER COURSES ENCOUNTERED DURING

17. THE CONTRACTOR IS CAUTIONED TO VISIT THE SITE AND FAMILIARIZE HIMSELF WITH THE PROJECT PRIOR TO BIDDING. 18. SHOULD THE CONTRACTOR IDENTIFY DISCREPANCIES IN PROJECT PLANS OR ON FIELD CONDITIONS THE CONTRACTOR SHALL NOTIFY THE ENGINEER IMMEDIATEL'

19. NO DERIVATIONS OR REVISIONS FROM THESE PLANS BY THE CONTRACTOR SHALL BE ALLOWED WITHOUT PRIOR APPROVAL FROM BOTH THE DESIGN ENGINEER AND ESCAMBIA COUNTY. ANY DEVIATIONS MAY RESULT IN DELAYS IN THE COUNTY ACCEPTANCE OF IMPROVEMENTS 20. CONTRACTOR SHALL MAINTAIN RECORD DRAWINGS DURING CONSTRUCTION WHICH SHOW "AS-BUILT" CONDITIONS OF ALL WORK

NCLUDING PIPING, DRAINAGE STRUCTURES, TOPO OF POND(S), OUTLET STRUCTURES, DIMENSIONS, ELEVATIONS, GRADING, ETC. RECORD DRAWINGS SHALL BE PROVIDED TO THE ENGINEER OF RECORD PRIOR TO REQUESTING FINAL INSPECTION. 21. NOTIFY SUNSHINE STATE ONE CALL 48 HOURS IN ADVANCE PRIOR TO DIGGING WITHIN R/W; 1-800-432-4770.

22. ALL ASPECTS OF THE STORMWATER/DRAINAGE COMPONENTS AND/OR TRANSPORTATION COMPONENTS SHALL BE COMPLETED PRIOR TO REQUESTING A FINAL INSPECTION. 23. ROUGH GRADE OF RIGHT-OF-WAY MUST BE ESTABLISHED PRIOR TO COMMON TRENCH UTILITY INSTALLATION TO ENSURE UTILITIES ARE INSTALLED AT PROPER DEPTHS. A MINIMUM 30" OF COVER IS REQUIRED OVER ALL UTILITIES, MEASURED FROM

PROPOSED GRADE IF ROAD IS IN FILL AND FROM TOP OF CURB IF ROAD IS IN CUT. 24. THE PROJECT ENGINEER (ENGINEER OF RECORD) SHALL PROVIDE TO ESCAMBIA COUNTY "AS-BUILT" RECORD DRAWINGS FOR VERIFICATION AND APPROVAL BY ESCAMBIA COUNTY ONE WEEK PRIOR TO REQUESTING A FINAL INSPECTION, OR PROVIDE "AS-BUILT" CERTIFICATION THAT THE PROJECT CONSTRUCTION ADHERES TO THE PERMITTED PLANS AND SPECIFICATIONS. THE "AS-BUILT" CERTIFICATION OR RECORD DRAWINGS MUST BE SIGNED, SEALED AND DATED BY A REGISTERED FLORIDA

PROFESSIONAL ENGINEER. 25. RETENTION/DETENTION AREAS SHALL BE SUBSTANTIALLY COMPLETE PRIOR TO ANY CONSTRUCTION ACTIVITIES THAT MAY INCREASE STORMWATER RUNOFF RATES. THE CONTRACTOR SHALL CONTROL STORMWATER DURING ALL PHASES OF

CONSTRUCTION AND TAKE ADEQUATE MEASURES TO PREVENT THE EXCAVATED POND FROM BLINDING DUE TO SEDIMENTS. 26. ALL DISTURBED AREAS WHICH ARE NOT PAVED SHALL BE STABILIZED WITH SEEDING, FERTILIZER AND MULCH, HYDROSEED AND/OR MULCH (UNLESS SOD IS REQUIRED). SEEDED AREAS SHALL INCLUDE A BAHIA MIX TO ENSURE CONTINUED GROWTH AFTER WINTER MONTHS. SEED IN ACCORDANCE WITH FDOT SECTION 570 AND STANDARD INDEX 105.

27. THE CONTRACTOR SHALL NOTIFY THE ENGINEER IMMEDIATELY IF ANY UNUSABLE, QUESTIONABLE MATERIAL, OR ANY THAT HAS A PUMPING ACTION OR PERCHED GROUNDWATER. THESE AREAS WILL BE EXCAVATED, REMOVED FROM THE PROJECT AND BACK

28. THE OWNER OR HIS AGENT SHALL ARRANGE/SCHEDULE WITH THE COUNTY A FINAL INSPECTION OF THE DEVELOPMENT UPON COMPLETION AND ANY INTERMEDIATE INSPECTIONS AT (850) 595-3472. AS-BUILT PLANS AND CERTIFICATION ARE REQUIRED PRIOR TO REQUEST FOR FINAL INSPECTION/APPROVAL.

29. GECI & ASSOCIATES WILL BE RESPONSIBLE FOR MONITORING CONSTRUCTION, SUBMITTING NOTICE OF CONSTRUCTION COMMENCEMENT, AND SUBMITTING AS-BUILT CERTIFICATIONS. 30. CONSTRUCTION WILL BEGIN WITHIN 6 MONTHS OF OBTAINING PERMITS AND WILL BE COMPLETED WITHIN 12 MONTHS OF

31. LOT CLEARING ACTIVITIES SHALL NOT PROCEED WITHOUT BUILDING PERMITS FOR THOSE LOTS EXCLUDING CLEARING REQUIRED FOR CONSTRUCTION OF CONVEYANCE SWALES OR DRAINAGE FEATURES DESIGNATED AS THE DEVELOPERS RESPONSIBILITY.

32. ALL NEW BUILDING ROOF DRAINS, DOWN SPOUTS, OR GUTTERS SHALL BE ROUTED TO CARRY ALL STORMWATER TO

33. ALL PERMITS FROM LOCAL, STATE AND FEDERAL AGENCIES PERTAINING TO THIS PROJECT COVER ONLY THOSE CONSTRUCTION ACTIVITIES CONTAINED WITHIN THESE PLANS. UNLESS SPECIFICALLY NOTED OTHERWISE, CONSTRUCTION ACTIVITIES WITHIN THE LOTS OF THE SUBDIVISION ARE NOT CONSIDERED PART OF THESE CONSTRUCTION PLANS. THE LOT GRADING PLAN IS TO

SERVE ONLY AS A GUIDE IN THE EVALUATION OF THE DRAINAGE PLAN FOR THE INDIVIDUAL HOMES/LOTS. 34. ELECTRIC/PHONE/CABLE/GAS STRUCTURE INSTALLED WITHIN DRAINAGE EASEMENT SHALL BE LOCATED ALONG BOUNDARY OF THE EASEMENT TO MAXIMIZE CLEAR ACCESS FOR MAINTENANCE EQUIPMENT.

35. A MINIMUM ONE-FOOT GROUND COVER IS REQUIRED FOR ALL STORMWATER PIPES AND 30" COVER FOR ALL OTHER UTILITIES. 36. SAG FILTERS IN CURB THROATS ARE NOT AN ALLOWABLE SEDIMENT CONTROL METHOD. 37. THE CONTRACTOR SHALL HAVE A GEOTECH ENGINEER DETERMINE THE NEED FOR ROADWAY UNDERDRAINS (AS SHOWN IN THE

DETAIL HEREIN) AFTER ROADBEDS HAVE BEEN CUT.

38. ALL PVC SANITARY SEWER PIPE TO BE SDR 26. 39. THE DEVELOPER/CONTRACTOR SHALL INSTALL PRIOR TO THE START OF CONSTRUCTION AND MAINTAIN DURING CONSTRUCTION ALL SEDIMENT CONTROL MEASURES AS REQUIRED TO RETAIL ALL SEDIMENTS ON THE SITE, IMPROPER SEDIMENT CONTROL MEASURES MAY RESULT IN CODE ENFORCEMENT VIOLATION.

40. DEVELOPER/CONTRACTOR/HOME OWNERS ASSOCIATION SHALL RESHAPE PER PLAN SPECIFICATIONS, CLEAN OUT ACCUMULATED SILT, AND STABILIZE RETENTION/DETENTION POND(S) AT THE END OF CONSTRUCTION WHEN ALL DISTURBED AREAS HAVE BEEN STABILIZED AND AT THE END OF THE 2 YEAR WARRANTY PERIOD.

41. THE CONTRACTOR SHALL NOTIFY FDOT 48 HOURS IN ADVANCE PRIOR TO INITIATING ANY WORK IN THE STATE RIGHT-OF-WAY. 42. ALL PROPOSED UNDERGROUND UTILITIES WITHIN RIGHTS OF WAY OR UTILITY CONDUIT FOR ROAD CROSSINGS SHALL BE INSTALLED PRIOR TO PAVING. NO STREETS OR ROADS UNDER THE TWO (2) YEAR WARRANTY WILL BE ALLOWED TO BE OPEN-CUT OR JACK-AND-BORED. TO ACCOMPLISH THIS REQUIREMENT, COMMON TRENCHING IS REQUIRED WHENEVER POSSIBLE. IF COMMON TRENCHING IS NOT A FEASIBLE OPTION, THE DEVELOPER SHALL INSTALL CONDUIT FOR THE UTILITY NOT PARTICIPATING IN THE COMMON TRENCHING FOR ALL ROAD CROSSINGS AND THE UTILITY COMPANY WILL BE REQUIRED TO USE THE CONDUIT. THIS SHALL REQUIRE PLANNING BETWEEN THE DEVELOPER AND THE UTILITY.

43. CONTRACTOR TO ENSURE FINISHED GRADES MATCH DRAINAGE FLOW ARROWS SHOWN HERON. 44. ALL SIDEWALKS, CURB RAMPS, BUS STOPS/LANDINGS AND ALL ASSOCIATED CONSTRUCTION SHALL FOLLOW THE LATEST EDITION OF DESIGN STANDARDS, AMERICANS WITH DISABILITIES ACT (ADA) GUIDELINES, PROWAG AND THE FDOT TRANSIT FACILITY

THESE PLANS ARE FOR THE CONSTRUCTION OF PAVING, STORM DRAINAGE. POTABLE WATER AND SANITARY SEWERS WITHIN THE PROPOSED RIGHT-OF-WAYS, EASEMENTS AND PARCELS TO SERVE THIS DEVELOPMENT. THESE PLANS DO NOT COVER ANY CONSTRUCTION OR CLEARING ON ANY LOTS WITHIN THIS DEVELOPMENT UNLESS SHOWN AS A FILL AREA. DURING CONSTRUCTION, IF ANY AREA WITHIN THE LOTS ARE DISTURBED, THEY SHALL BE GRASSED AND MULCHED OR SODDED. FUTURE LOT GRADING SHALL BE IN ACCORDANCE WITH ESCAMBIA COUNTY STANDARDS, BY THE LOT BUILDER. ALL

PERMITS FROM LOCAL, STATE AND FEDERAL AGENCIES PERTAINING TO THIS PROJECT COVER ONLY THOSE CONSTRUCTION ACTIVITIES CONTAINED WITHIN PLAN, WHICHEVER IS LESS. THESE PLANS. UNLESS SPECIFICALLY NOTED OTHERWISE, CONSTRUCTION ACTIVITIES WITHIN THE LOTS OF THE SUBDIVISION ARE NOT CONSIDERED PART OF THESE CONSTRUCTION PLANS. THE LOT GRADING PLAN IS TO SERVE ONLY AS A GUIDE IN THE EVALUATION OF THE DRAINAGE PLAN FOR THE INDIVIDUAL

CONTRACTOR'S EROSION AND SEDIMENT CONTROL NOTE SEDIMENT SHALL BE RETAINED ON THE SITE OF THE DEVELOPMENT. EROSION AND SEDIMENTATION CONTROLS WILL BE PROVIDED BY CONTRACTOR AT ALL TIMES AS PER ESCAMBIA COUNTY, DEP, NPDES. AND EPA. REQUIREMENTS.

THE CONTRACTOR SHALL AT ALL TIMES DURING THE CONSTRUCTION OF THIS PROJECT, PROVIDE AND MAINTAIN THE NECESSARY EARTH BERMS, PONDING AREAS AND SEDIMENTATION CONTROL WALLS OF STRAW ALONG ALL THE STREET RIGHT-OF-WAY AND EASEMENTS TO CONTROL THE RUNOFF FROM THIS PROJECT. (NO DIRECT PAYMENT FOR THIS. PAYMENT FOR THIS TO BE INCLUDED IN THE ITEM OF BASE AND PRIME.)

EROSION AND SEDIMENT CONTROL NOTE:


THE DEVELOPER/CONTRACTOR SHALL INSTALL PRIOR TO THE START OF CONSTRUCTION AND MAINTAIN DURING CONSTRUCTION ALL SEDIMENT CONTROL MEASURES AS REQUIRED TO RETAIL ALL SEDIMENTS ON THE SITE, IMPROPER SEDIMENT CONTROL MEASURES MAY RESULT IN CODE ENFORCEMENT

THE DEVELOPER SHALL REQUIRE THE CONTRACTOR AT ALL TIMES DURING . THE SURVEY ERROR OF CLOSURE MEETS THE SURVEY STANDARDS OF PRACTICE CONTROLS ALONG ALL THE STREET RIGHTS-OF-WAY, EASEMENTS AND FROM INCREASED RUNOFF DURING CONSTRUCTION OF THIS PROJECT. • THE CERTIFICATE OF AUTHORIZATION NUMBER FOR KJM LAND SURVEYING, LLC., IS 1.B. 8298. EROSION AND SEDIMENTATION CONTROLS SHALL BE ESTABLISHED TO MEET OR EXCEED ESCAMBIA COUNTY, DEP., NPDES., AND EPA. REQUIREMENTS. LOCATION AND DETAIL OF THE ABOVE TO BE INCLUDED ON THE CONSTRUCTION PLANS FOR THE PROJECT AND SHALL BE IN PLACE PRIOR TO ANY CONSTRUCTIONOR

ON SITES GREATER THAN 1 ACRE, IF GREATER THAN 1 CONTIGUOUS ACRE IS CLEARED, A GROUND COVER SUFFICIENT TO PREVENT EROSION SHOULD BE PLANTED OR OTHERWISE STABILIZED WITHIN 10 WORKING DAYS ON THAT PORTION OF THE SITE UPON WHICH FURTHER ACTIVE CONSTRUCTION WILL NOT BE UNDERTAKEN WITHIN 90 DAYS.

TO COMPLY WITH NPDES REQUIREMENTS, ALL EROSION CONTROL MEASURES SHALL BE INSPECTED AFTER EACH 1/2" RAINFALL EVENT OR AT LEAST WEEKLY. THE CONTRACTOR SHALL DOCUMENT SUCH INSPECTIONS AND EROSION CONTROL MAINTENANCE EFFORTS. INSPECTION RECORDS SHALL BE PROVIDED TO THE NPDES PERMIT APPLICANT FOR PROPER REPORTING TO FDEP/NWFWMD.

A HEALTHY GROWTH OF GRASS WITHIN DISTURBED RIGHT-OF-WAY AREA IS REQUIRED PRIOR TO COUNTY APPROVAL/ACCEPTANCE. IF TIME CONSTRAINTS EXIST DURING THE FINAL PLAT APPROVAL AND ACCEPTANCE PROCESS, A MINIMUM OF TWO STRIPS OF SOD (MINIMUM 2' WIDE) BEHIND THE BACK OF CURB WITH ALL OTHER DISTURBED AREAS SEEDED/MULCHED/FERTILIZED WILL

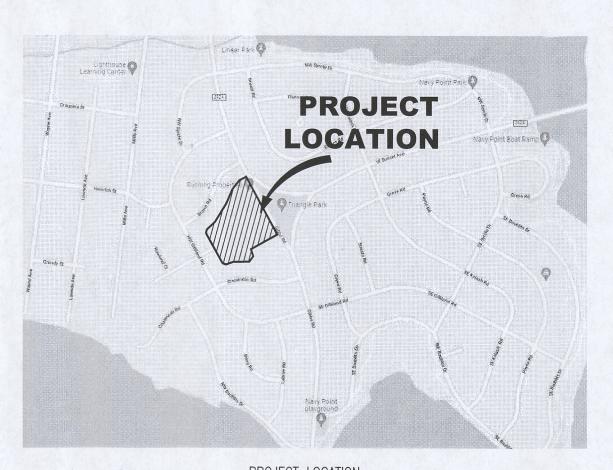

300 GIBBS ROAD PENSACOLA, FL 32507

CONSTRUCTION PLAN APPROVAL IS REQUIRED TO DOCUMENT THE DESIGN OF INFRASTRUCTURE TO ADEQUATELY SERVE THE CREATED LOTS THE APPROVAL ALLOWS THE CONSTRUCTION OF THE SUBDIVISION INFRASTRUCTURE AREAS ONLY AS SPECIFICALLY DESIGNATED TO PROCEED, BUT IT DOES NOT ALLOW DEVELOPMENT ON THE INDIVIDUAL SUBDIVISION LOTS. NEITHER PLAT OR PLAN ALLOW LAND CLEARING/ LAND DISTURBANCE ACTIVITIES AND DEVELOPMENT ON THE INDIVIDUAL SUBDIVISION LOTS AS BUILDING PERMITS FOR THE DWELLINGS WILL BE REQUIRED FOR THESE ACTIVITIES PRIOR, ON EACH LOT/PARCEL IN THE FUTURE

I HEREBY CERTIFY THAT I AM THE ENGINEER OF RECORD FOR PLESS LANDING SUBDIVISION AND ALL PROPOSED ROADWAY, DRAINAGE, AND OTHER IMPROVEMENTS UNDER MY RESPONSIBILITY ARE DESIGNED TO COMPLY WITH ALL FEDERAL, STATE, AND LOCAL DEVELOPMENT REQUIREMENTS

CLINT A. GECI, P.E., VICE PRESIDENT GECI & ASSOCIATES ENGINEERS, INC.

FLORIDA P.E. NO. 73924 SITE NOTES: a. SITE AREA: 5.20 AC

b. TOTAL LOTS: 60 c. PARCEL ID: 50-2S-30-6092-014-008, 50-2S-30-6092-004-008, 50-2S-30-6092-003-008, & 50-2S-30-6092-018-008

d. LATITUDE & LONGITUDE: 30°22'44"N, 87°17'24"W e. ZONING: COM

f. AIRPORT ZONING: AIPD-2

ı. FLU: MU-U PROJECT ADDRESS: GIBBS ROAD, PENSACOLA, FLORIDA 32507 BUILDING SETBACK REQUIREMENTS: 15' FRONT, 15' REAR, & 10' SIDE

OR 10% WHICHEVER IS LESS. BUT AT LEAST 5 MAX. BUILDING HEIGHT: 150' LOT COVERAGE: 85% MAXIMUM LOT COVERAGE AS PER ZONING REGULATIONS, OR THE LOT COVERAGE SHOWN ON THIS LOT GRADING

→ FOUND 1/2" CAPPED IRON ROD LS #1748 FOUND 1/2" CAPPED IRON ROD LS #475 ○ - FOUND ILLEGIBLE 5/8" CAPPED IRON ROD ⊗ − FOUND ILLEGIBLE 1/2" CAPPED IRON ROD △ - FOUND PLAIN 5/8" IRON ROD ○ - FOUND PLAIN 1/2" IRON ROD ○ - FOUND 1" IRON PIPE ● - SET 1/2" CAPPED IRON ROD LD #8298 ► POWER POLE WITH GUY ANCHOR OVERHEAD UTILITY LINES — WATER METER □ − WATER VALVE CO - NATURAL GAS METER □ - TELEPHONE PEDESTAL ☐ - MAILBOX

○ - FOUND 1/2" CAPPED IRON ROD LB #6832

SURVEYOR LENGEND:

- FIRE HYDRANT

THE MAP OF SURVEY AS SHOWN HEREON IS A BOUNDARY AND TOPOGRAPHIC SURVEY WITH IMPROVEMENTS FOR WHICH PURPOSE IS TO DEFINE THE RECORD BOUNDARY ON THE GROUND BY RETRACEMENT OF THE RECORD PLATTED LOTS AND BLOCK OF THE ABOVE REFERENCED SUBDIVISION, AND/OR RECOVERY. AND/OR PLACEMENT OF MONUMENTATION OF SAID BOUNDARY, AND ALSO; VERTICALLY DEPICT GROUND SURFACE ELEVATIONS BY SPOT ELEVATIONS AND/OR 1.0 FOOT CONTOUR INTERVALS RELATIVE TO MEAN SEA LEVEL AND ALSO; LOCATE HORIZONTALLY AND VERTICALLY; DIMENSIONALLY MEASURED FIXED PERTINENT SURFACE AND SUB-SURFACE FEATURE IMPROVEMENTS AND GRAPHICALLY DEPICT FIXED NON-PERTINENT SURFACE AND SUB-SURFACE FEATURE IMPROVEMENTS TO SCALE AND THEIR RELATIONSHIP TO THE BOUNDARY, PREPARED FOR THE CLIENT AS SHOWN AND IS NOT TO BE USED FOR ANY OTHER PURPOSES WITHOUT PRIOR CONSENT FROM THIS SURVEYOR.

BASIS OF DEED BEARINGS: NORTH AND THOSE RECORD BEARINGS AS SHOWN HEREON ARE REFERENCED TO THE DEED BEARING OF \$39.00'00"E ALONG THE WESTERLY R/W LINE OF GIBBS ROAD AS MONUMENTED

BASIS OF STATE PLANE FIELD BEARINGS: GRID NORTH AND THOSE BEARINGS AS SHOWN HEREON ARE REFERENCED TO THE STATE PLANE GRID BEARING OF S27'20'54"E ALONG THE WESTERLY R/W LINE OF GIBBS ROAD AS MONUMENTED. THE SURVEY DATA AS SHOWN HEREON IS BASED ON THE FLORIDA STATE PLANE COORDINATE SYSTEM (FLORIDA NORTH ZONE)- (NAD83) - (2011) - (EPOCH 2010.0000)

 THE BEARING EQUATION DIFFERENCE BETWEEN STATE PLANE GRID AND RECORD OF THE SURVEY AS SHOWN HEREON IS 11*39'06". AS BOTH CANNOT RETAIN THEIR INTEGRITY BY ROTATION OF ONE INTO THE OTHER, BOTH ARE DIFFERENTIATED FOR CLIENT'S NEEDS AND DUE DILIGENCE TO THE LATTER, FOR RECORD • VERTICAL DATA IS BASED ON RTN GPS/GNSS OBSERVATIONS THROUGH THE FPRN, CORS REFERENCE STATION NETWORKS. ELEVATIONS ARE DETERMINED USING

THE GEOID 18 MODEL AND ARE RELATIVE TO NAVD '88 WITH ACCURACIES TO 2-3 CM. ELEVATIONS DEPICTED WITHIN THIS SURVEY ARE SUB-CM INFORMATIONAL PURPOSES ONLY AND MAY NOT MEET THE ACCURACY REQUIREMENTS TO SURVEY STANDARDS • REFERENCE SOURCE: IN FIELD DATA GATHERING OF EXISTING PROJECT SITE FIELD MONUMENTATION; COPY OF PLAT OF NAVY POINT, PLAT BOOK 1 PAGE 100;

COPY OF PLAT OF RESUBDIVISION OF BLOCKS G & H NAVY POINT, PLAT BOOK 2, PAGE 7; COPY OF RESUBDIVISION OF LOT R, BLOCK H NAVY POINT, PLAT BOOK 2, PAGE 26; COPY OF SURVEYS BY THIS FIRM, JOB #08-14256 • ALL MEASUREMENTS WERE MADE IN ACCORDANCE WITH THE UNITED STATES STANDARD SURVEY FOOT.

• THE SURVEY AS SHOWN HEREON WAS PERFORMED WITH THE BENEFIT OF TITLE COMMITMENT PLANT FILE #21-18597, AS PROVIDED BY WESTCOR LAND TITLE JRANCE COMPANY, HAVING AN EFFECTIVE DATE OF FEBRUARY 12, 2021 • NO INSTRUMENTS OF RECORD REFLECTING EASEMENTS, RIGHTS-OF-WAYS, AND/OR OWNERSHIPS WERE PROVIDED TO THIS SURVEYOR; EXCEPT AS SHOWN.

• NO UNDERGROUND INSTALLATIONS OR IMPROVEMENTS HAVE BEEN LOCATED; EXCEPT AS SHOWN. UNLESS OTHERWISE NOTED RECORD AND MEASURED CALLS AGREE

CONSTRUCTION OF THIS PROJECT TO PROVIDE AND MAINTAIN THE NECESSARY • THERE MAY BE ADDITIONAL RESTRICTIONS AFFECTING THE SUBJECT PROPERTY THAT MAY BE FOUND RECORDED IN THE PUBLIC RECORDS OF ESCAMBIA COUNTY.

FENCES MAY BE EXAGGERATED FOR CLARITY PURPOSES.

DETENTION/RETENTION AREAS TO CONTROL AND PREVENT EROSION RESULTING . THIS SURVEY DOES NOT REFLECT OR DETERMINE OWNERSHIP NOR AN ENCROACHMENT OF FENCES, WALLS, ETC.

120080

. THIS SURVEY MEETS THE STANDARDS OF PRACTICE AS SET FORTH BY THE FLORIDA BOARD OF PROFESSIONAL LAND SURVEYORS & MAPPERS IN CHAPTER 5J-17.050, 5J-17.051 AND 5J-17.052, PURSUANT TO SECTION 472.027, FLORIDA STATUTES.

. THE SURVEY AS SHOWN HEREON IS CERTIFIED TO THE CLIENT AS PREPARED FOR AND ANY ENTITIES AS DECLARED TO HEREON ONLY AND IN NO WAY TRANSFERS CERTIFICATION TO THEIR SUCCESSORS OR ANY OTHER ENTITIES NOT REFERRED TO HEREIN • IT IS OF THE OPINION OF THE UNDERSIGNED SURVEYOR THAT THE PARCEL OF LAND SHOWN HEREON AS PER THE FLOOD INSURANCE RATE MAP INFORMATION IS

> THE PARCEL SHOWN FOR DEVELOPMENT IS LOCATED WITHIN THE FOLLOWING FLOOD ZONE(S) AS DETAILED BY FEMA FIRM (FLOOD INSURANCE RATE MAP) INFORMATION DESCRIBED BELOW: Flood zone(s) Map number Map Revision Date Panel number(s) Suffix number

> > 12033C0368G

COUNTY INSPECTION NOTE:

THE CONTRACTOR SHALL NOTIFY ESCAMBIA COUNTY INSPECTOR 24 HOURS BEFORE BEGINNING OF EVERY PHASE OF CONSTRUCTION (981-7100). THE CONTRACTOR SHALL HAVE ALL EROSION CONTROL IN PLACE PRIOR TO NOTIFYING COUNTY THE PROJECT HAS STARTED.

INDEX OF DRAWING

0368

SHEET	DESCRIPTION
C000	COVER SHEET
C100	OVERALL PLAN
C110	EXISTING CONDITIONS, EROSION CONTROL, & DEMOLITION PLAN
C130	LOT GRADING PLAN
C135	STORMWATER & SANITARY SEWER STRUCTURE PLAN
C200	LEROY POULSON LANE PLAN & PROFILE 1
C210	LEROY POULSON LANE PLAN & PROFILE 2
C220	RUPERT FAIRFIELD LANE & JOHN PHELPS LANE PLAN & PROFILE
C230	ONSITE STORMWATER PIPE PLAN & PROFILE
C300	UTILITY PLAN
C310	TRAFFIC PLAN
C320	STORMWATER PONDS
C400	CROSS-SECTIONS
C500	DETAILS
LS-1 LIFT STATION PLAN	
LS-2 EXISTING LIFT STATION DEMO PLAN	
LS-3	NEW LIFT STATION MODIFICATIONS
LS-4	PANEL ENCLOSURE DETAIL
LS-5	MECHANICAL DETAILS

5 - 2 w 4 v





9/29/2006

PROJECT NO. SHEET NO

SUBDIVISION GENERAL NOTES:

1. ALL DISTURBED AREAS WHICH ARE NOT PAVED SHALL BE STABILIZED WITH SEEDING, FERTILIZER AND MULCH, HYDROSEED AND/OR SOD WITH A HEALTHY GROWTH OF GRASS PRIOR TO RECEIVING COUNTY ACCEPTANCE. SEEDED AREAS SHALL INCLUDE A BAHIA MIX TO ENSURE CONTINUED GROWTH AFTER WINTER MONTHS. SEED IN ACCORDANCE WITH FDOT SECTION 570 AND STANDARD INDEX 105.

2. DISTURBED RIGHT—OF—WAY AREAS SHALL BE STABILIZED WITH A HEALTHY GROWTH OF GRASS PRIOR TO RECEIVING COUNTY APPROVAL/ACCEPTANCE. IF TIME CONSTRAINTS EXIST DURING THE FINAL PLAT APPROVAL AND ACCEPTANCE PROCESS, A MINIMUM OF TWO STRIPS OF SOD (MINIMUM 2' WIDE) BEHIND THE BACK OF CURB WITH ALL OTHER DISTRUBED AREAS SEEDED/MULCHED/FERTILIZED WILL BE ACCEPTABLE.

3. DISTURBED LOT AREAS SHALL BE COMPLETELY STABILIZED WITH SOD.

4. THE HOMEBUILDER SHALL COMPLY WITH STATE PERMITTING REQUIREMENTS FOR LARGE & SMALL CONSTRUCTION SITES, SPECIFICALY THE NDEPS PERMIT WHICH REQUIRES A DETAILED STORMWATER

THE HOMEBUILDER SHALL COMPLY WITH STATE PERMITTING REQUIREMENTS FOR ASSETTING & SMALL CONSTRUCTION SITES, SPECIFICALY THE NDEPS PERMIT WHICH REQUIRES A DETAILED STORMWATER POLLUTION PREVENTION PLAN (SWPPP) BEING AVAILABLE ONSITE FOR REVIEW DURING ALL PHASES OF CONSTRUCTION.
 LOT CLEARING ACTIVITIES SHALL NOT PROCEED WITHOUT BUILDING PERMITS FOR THOSE LOTS EXCLUDING CLEARING REQUIRED FOR CONSTRUCTION OF CONVEYANCE SWALES OR DRAINAGE FEATURES DESIGNATED AS THE DEVELOPER'S RESPONSIBILITY.
 ON INDIVIDUAL SUBDIVISION LOTS, ALL LAND CLEARING & TREE REMOVAL SHALL ONLY BE ALLOWED AFTER COUNTY ISSUANCE OF A BUILDING PERMIT FOR THE DWELLING OR A SEPARATE LAND DISTURBING OR TREE REMOVAL PERMIT, PER ESCAMBIA COUNTY LDC. LOTS SHOULD REMAIN IN THEIR NATURAL STATE UNTIL FURTHER PERMITTING ALLOWS FOR DEVELOPMENT, SITE DISTURBANCE &/OR TREE REMOVAL.

UNTIL FURTHER PERMITTING ALLOWS FOR DEVELOPMENT, SITE DISTURBANCE &/OR TREE REMOVAL.

7. NO HERITAGE TREES EXIST ON—SITE.

8. CONSTRUCTION OF THE SUBDIVISION INFRASTRUCTURE, INCLUDING LAND CLEARING & REMOVAL OF PROTECTED TREES ONSITE WITHIN R/W OR POND PARCELS/AREAS WILL BE ALLOWED AT THE TIME OF CONSTRUCTION PLAN APPROVAL.

UTILITY NARRATIVE:

POTABLE WATER IS PROVIDED BY NEW 6" WATER MAINS LOCATED IN THE RIGHTS-OF-WAY AND SIZED FOR FIRE PROTECTION. THE WATER CONNECTION(S) IS TO PEOPLE'S WATER SYSTEM LOCATED AT THE WEST SIDE OF GIBBS RD (EXISTING 8" MAIN) AS WELL AS AT THE WEST SIDE OF NW GILLILAND RD (EXISTING 6" MAIN). SANITARY SEWER IS PROVIDED BY NEW 8" GRAVITY MAINS LOCATED IN THE RIGHTS-OF-WAY. THE GRAVITY SEWER CONNECTION IS TO AN EXISTING ECUA MANHOLE LOCATED IN THE INTERSECTION OF NW GILLILAND RD & JARDINE ROAD. ECUA IS TO ACCEPT SANITARY SEWER MAINS FOR OWNERSHIP, OPERATION & MAINTENANCE UPON COMPLETION OF CONSTRUCTION. THE NEW STORMWATER SYSTEM INCLUDES STORM PIPE & INLETS LOCATED IN THE RIGHTS-OF-WAY WHICH DRAIN TO THE NEW STORMWATER POND. IT IS PROPOSED THAT ESCAMBIA COUNTY ACCEPT THIS STORMWATER SYSTEM FOR OWNERSHIP, OPERATION, & MAINTENANCE AFTER THE 2-YR WARRANTY PERIOD. SERVICE LINES LOCATED ON EACH LOT SHALL BE HOMEOWNERS RESPONSIBILITY.

TO THE SEAM RAY SHOULDER SPECIFICATIONS A COMMON AREA HOMEOWNER'S ASSOCIATION 0.16 B COMMON AREA HOMEOWNER'S ASSOCIATION 0.09 C CORY STORMAGE WAY D DRAINAGE WAY A COMMON AREA HOMEOWNER'S ASSOCIATION 0.09 C CORY STORMAGE POINT 0.035 C DRY STORMAGE POINT 0.035 D D RAINAGE WAY PUBLIC 0.09 E WET STORMAGE POINT 0.006 D RAINAGE WAY D USE BROWN FIG. 0.66 D RAINAGE WAY PUBLIC 0.09 C OMMON AREA D D RAINAGE WAY PUBLIC 0.09 C OMMON AREA D D RAINAGE WAY PUBLIC 0.09 C OMMON AREA D D RAINAGE WAY PUBLIC 0.09 C OMMON AREA D D RAINAGE WAY PUBLIC 0.09 C OMMON AREA D D RAINAGE WAY PUBLIC 0.09 C OMMON AREA D D RAINAGE WAY PUBLIC 0.09 C OMMON AREA D D RAINAGE WAY PUBLIC 0.09 C OMMON AREA D PUBLIC 0.09	FI 4)
SITE NOTES: 15 DRAINAGE EASEWENT (PUBLIC) TYP. SITE AREKE 5.20 AC 5. STE AREKE 5.20 AC 6. STE AREKE 5.20 AC 6. PARCEL ID: 50-25-30-6092-014-008, 50-25-30-6092-004-008, 50-25-30-6092-014-008, 50-25-30-6092-014-008, 50-25-30-6092-014-008, 50-25-30-6092-018-008 6. LATION & LONG ID: 50-25-30-6092-018-008 6. LATION & ADDRESS: GIBBS ROAD, FENSACOLA, FLORIDA 32507 F. RULL MU-U 6. RULL MU-U	ON OF LOT
Company Comp	
35' SIGHT TRANGLE 9-25-30-6091-050-057 109-09 CILLIAN REMARK SET 'K,M' NAL & DISK ELEVATION = 12-697 90-27-30-6091-050-057 109-09 CILLIAN REMARK SET 'K,M' NAL & DISK ELEVATION = 12-697 90-27-30-6091-050-057 109-09 CILLIAN REMARK FULL STORMWATER POND 0.66 AC PARCEL "E' (PUBLIC) WET STORMWATER POND 0.66 AC 10-00 10-	N G I NEBORATION NET CAG DRAWN: KRD CHECKED: CAG DRAWN: KRD CHECKED: R CONSTRUCTION
SS - 25-30-0931 - 200-2005 PERSOOD, 13-507 PP - 281-33 SPF - 277-40-537 SP	KJM'
12' GRAVEL POND ACCESS ROAD — W/ CONCRETE DRIVEWAY SPF—NGT-43'59"W 30.62' 99-21-30-6009-733-035 10 100 KINCLIAMB ROAD PERSONA, R. 32507 PROF PONT	FLORIDAGE PLANS FLORIDAGER DE
F-132.79' P-177.77' SPF-NS9'33'22"W 73.75' (N) (N) (E) SPF-S37'24'51"W SPF-S37'24'S1"W	SITEWORK CONSTRUCTION PLANS FOR PLESS LANDING OVERALL PLAN OVERALL PLAN SANITARY SEWER, PAVING & STORM DR
TYPICAL SIGHT TRIANGLE DETAIL N.T.S.	PROJECT NO. SHEET NO.

NOTES:

1. CONTRACTOR SHALL REFER TO BOUNDARY & TOPO SURVEY PROVIDED BY KIM LAND SURVEYING, LLC., DATED SEPTEMBER 17TH, 2021 FOR ALL EXISTING LOCATION OF EXISTING UTILITIES WERE TAKEN FROM THE RECORDS OF APPROPRIATE UTILITY COMPANIES AND HAVE NOT BEEN VERIFIED BY THE OWNER OR IT'S REPRESENTATIVE. THE CONTRACTOR SHALL DETERMINE THE EXACT LOCATION OF ALL EXISTING UTILITIES BEFORE COMMENCING WORK, AND IS FULLY RESPONSIBLE FOR ANY AND ALL DAMAGES THAT MIGHT BE OCCASIONED BY THE CONTRACTOR'S FAILURE TO EXACTLY LOCATE AND PRESERVE ANY AND ALL ABOVE GROUND AND UNDERGROUND UTILITIES. ALL AREAS REQUIRED FOR CONSTRUCTION OF ROADS, PONDS, LAY DOWN AREAS, STOCKPILE AREAS, UTILITIES, AND INFRASTRUCTURE REQUIRED TO CONSTRUCT THE DEVELOPMENT TO BE CLEARED & GRUBBED.

4. ALL EXISTING IMPROVEMENTS LOCATED ONSITE INCLUDING BUT NOT LIMITED TO BUILDINGS, PAVEMENT, FENCES, AND UTILITIES TO BE DEMOLISHED & 5. ALL EXISTING STRUCTURES WILL REQUIRE SEPARATE DEMO PERMITS FROM BUILDING INSPECTIONS AT TIME OF DEMOLITION.
6. NO HERITAGE TREES EXIST ON PROJECT SITE.

ALL PROPOSED STORMWATER STRUCTURES TO BE INSTALLED WITH SILT SAVERS (SEE DETAIL C500)

SCALE: 1" = 50'

SURVEYOR LENGEND: → FOUND 1/2" CAPPED IRON ROD LS #1748 ● - FOUND 1/2" CAPPED IRON ROD LS #475 S - FOUND ILLEGIBLE 5/8" CAPPED IRON ROD ⊗ - FOUND ILLEGIBLE 1/2" CAPPED IRON ROD

 ○ - FOUND PLAIN 1/2" IRON ROD → SET 1/2" CAPPED IRON ROD LD #8298

POWER POLE WITH GUY ANCHOR

— — OVERHEAD UTILITY LINES — WATER METER WATER VALVE CCI - NATURAL GAS METER

T - TELEPHONE PEDESTAL ☐ — MAILBOX G - FIRE HYDRANT

SURVEYOR ABBREVIATIONS: PSM - PROFESSIONAL SURVEYOR AND MAPPER

LS - LICENSED SURVEYOR LB - LICENSED BUSINESS R/W - RIGHT-OF-WAY A/C - AIR CONDITIONER

PC - POINT OF CURVATURE D - DEED P – PLAT

F — FIELD NFIP NATIONAL FLOOD INSURANCE PROGRAM N/A - NOT APPLICABLE


ORB - OFFICIAL RECORDS BOOK PG - PAGE RCP - REINFORCED CONCRETE PIPE

RTN - REAL TIME NETWORK GNSS - GLOBAL NAVIGATION SATELLITE SYSTEM GPS - GLOBAL POSITIONING SYSTEM

FPRN - FLORIDA PERMANENT REFERENCE NETWORK CORS - CONTINUOUSLY OPERATING REFERENCE STATION NAVD - NORTH AMERICAN VERTICAL DATUM

CM - CENTIMETER

			CURVE TA	\BLE		
CURVE	SOURCE	RADIUS	DELTA	LENGTH	CHORD	CHORD BEARING
C-1	PLAT FIELD	393.33' 393.33'	36°18′ 36°00′18″	249.12' 247.17'	N/A 243.12'	N/A S41'49'15"W
C-2	PLAT FIELD	405.85' 405.85'	38 ' 42' 38'39'05"	274.6' 273.78'	N/A 268.62'	N/A N42*56'54"E
C-3	PLAT FIELD	585.7' 585.70'	N/A 01°32'25"	16.25' 15.75'	N/A 15.74'	N/A S26'36'02"E

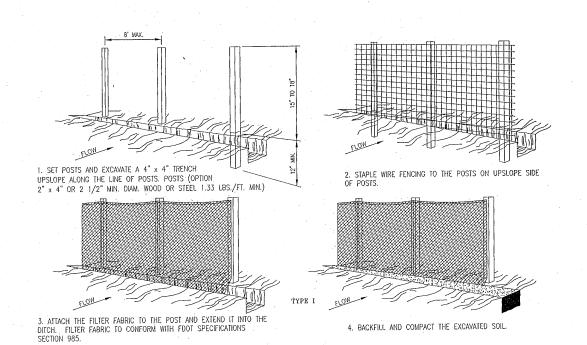

+D-N28'39'46"E | D-N51°07'46"E 89.60' 61.85 P-91.14' P-61.95' SPF-N39°48'39"E SPF-N63'19'46"E 91.40' 63.25' LOT 115 (NOT INCLUDED) POINT OF COMMENCEMENT LOT 114 (NOT INCLUDED) LOT 113 P-66.0' SPF-N63:19'46"E (NOT INCLUDED) POINT OF BEGINNING 66.2Q' LOT 112 (NOT INCLUDED) NO NEW UTILITIES TO BE 568 SY OF EXISTING DIRT PATHWAY TO BE \(\square\) LOT 111 LOCATED WITHIN EXISTING RELOCATED INTO EXISTING COUNTY PARCEL ALLEYWAY (NOT INCLUDED) SEE DETAIL C500, 5 TOTAL BLOCK 8 / D-S39°00'00"E 535.27' LOT 110 F-534.82' (NOT INCLUDED) LESS & EXCEPT, P-104.6' LOT 109 SPF-N47°56'38"E -P-50.65 (NOT INCLUDED) 92.12' SPF-N62°15'25"E 50.64 - SAWCUT & REMOVE APPROX. 1,814 SY OF CONCRETE EXISTING 2" PE GAS MAIN, (NOT INCLUDED) LOT "K" (NOT INCLUDED) 14,580 SF EXISTING BUILDING & ASSOCIATED IMPROVEMENTS SPF-N12°48'39"E ¬ TO BE DEMOLISHED & HAULED OFF SITE 30.42 INSTALL 1,236 LF OF TYPE-1 SILT FENCE SEE DETAIL ON THIS SHEET EL: 15.02 AB-3 -EL: 15.64 LOT "Q" (NOT INCLUDED) SAWCUT & REMOVE APPROX. 712 SY OF CONCRETE SAWCUT & REMOVE 30 SY OF CONCRETE SIDEWALK -- REMOVE 227 LF OF CHAINLINK FENCE EL: 14.03 EXISTING STOP SIGN TO BE PRESERVED this & EXCEPT BENCHMARK . NEW PARCEL "A" LOT "P" SET 'KJM' NAIL & DISK $(5.20 \text{ ACRES } \pm)$ (NOT INCLUDED) EXITING FIRE HYDRANT ELEVATION=12.69' SAWCUT & REMOVE 28 SY OF CONCRETE SIDEWALK (PRIOR TO INSTALLATION OF CONSTRUCTION ENTRANCE) (PARCEL 1) / EL: 15.20 14.72 REMOVE 105 LF OF WOODEN FENCE - PROPOSED STOCKPILE AREA W/ 567 LF OF TYPE-1 SILT FENCE EXISTING DEAD END SIGN TO BE REMOVED (NOT INCLUDED) - REMOVE 135 LF OF CHAINLINK FENCE SAWCUT & REMOVE 26 SY OF CONCRETE SIDEWALK P-281.93' // EXISTING OVERHEAD UTILITY LINE SPF-N27'40'53"W_ SAWCUT & REMOVE APPROX. 21 SY OF CONCRETE CURB 276.65 = EXISTING UTILITY POLE TO BE REMOVED -POINT OF BEGINNING LOT "N" CURB INLET-(LESS AND EXCEPT (PARCEL 3) (NOT INCLUDED) FROM PARCEL 1)

GRAPICEL 5) & W. INVERT ELEV.=6.97' E. INVERT ELEV.=6.99' CURB INLET-N. INVERT ELEV.=7.84' S. INVERT ELEV.=7.91' P-100.1' CS-POCS 10SPF-N67°26'51"E / W. INVERT ELEV.=7.62 101.03' SAWCUT & REMOVE APPROX. 4 SY OF CONCRETE CURB SPF-N67°43'59"W -ORB 6302, PG 63 5 LESS & EXCEPT (FROM PARCEL 1) 30.62' (PARCEL 5) NEW PARCEL "B" (PARCEL 4) LOT "L" LOT "M" (1.18 ACRES ±) (NOT INCLUDED) (NOT INCLUDED) D-S50'48'55"W 77.10' D-N50'48'55"E 87.26' LOT 656 D-S39'57'54"E LESS & EXCEPT ORB 6302, PG 63 (NOT INCLUDED) LESS & EXCEPT (ORB 6302, PG 61) ¹ INSTALL 950 LF OF TYPE-1 SILT FENCE (PARCEL 4) D-N50'48'55"E LOT 657 SEE DETAIL ON THIS SHEET (NOT INCLUDED)/ BLOCK 30 231 SY OF EXISTING DIRT PATHWAY TO BE POINT OF BEGINNING RELOCATED INTO EXISTING COUNTY PARCEL (PARCEL 4) F-132.79' LOT 658 P-177.77 (NOT INCLUDED) SPF-N89°33'22"W-178.71^{*} (N) (E) SPF-S37*24'51"W -LOT 659 54.23 (NOT INCLUDED) LOT 660 (NOT INCLUDED) LOT 661 (NOT INCLUDED) EXISTING 2" PE GAS MAIN LOT 662 (NOT INCLUDED)

TO THE ESCAMBIA COUNTY STANDARDS AND F.D.O.T. STANDARDS. R/W SHOULDER STABILIZATION TO CONFORM WITH FDOT STANDARD SPECIFICATIONS FOR ROAD AND BRIDGE CONSTRUCTION. ALL POTABLE WATER AND SANITARY SEWER WORK SHALL BE CONSTRUCTED IN ACCORDANCE WITH THE LATEST EDITION OF PEOPLE'S WATER SERVICE COMPANY STANDARD SPECIFICATIONS.

ALL PAVING AND STORM DRAINAGE CONSTRUCTION TO CONFORM

ALL SANITARY SEWER WORK SHALL BE CONSTRUCTED IN ACCORDANCE WITH THE LATEST EDITION OF ECUA STANDARD SPECIFICATIONS.

(LESS & EXCEPT FROM PARCEL 1), (PARCEL 4), (PARCEL 5) & (NEW PARCEL "B")
NORTHEAST CORNER OF LOT 1, RESUBDIVISION OF LOT
R, BLOCK H, NAVY POINT SUBDIVISION (PARCEL 2) & (NEW PARCEL "A")

- SAWCUT & REMOVE 37 SY OF CONCRETE SIDEWALK - SILT SAVERS TO BE INSTALLED ON -ALL NEW INLET STRUCTURES (TYP.)


— INSTALL NEW CONSTRUCTION ENTRANCE (SEE DETAIL ON C500) -CURB INLET TOP ELEV. = 14.2' N. INVERT ELEV.=10.14' S. INVERT ELEV.=10:30'

> *BENCHMARK SET PINK 'KJM' CAPPED IRON ROD ELEVATION=14.64'


-DROP INLET N. INVERT ELEV.=10.99' S. INVERT ELEV.=11.09"


TOP ELEV.=13.75'

PROJECT N

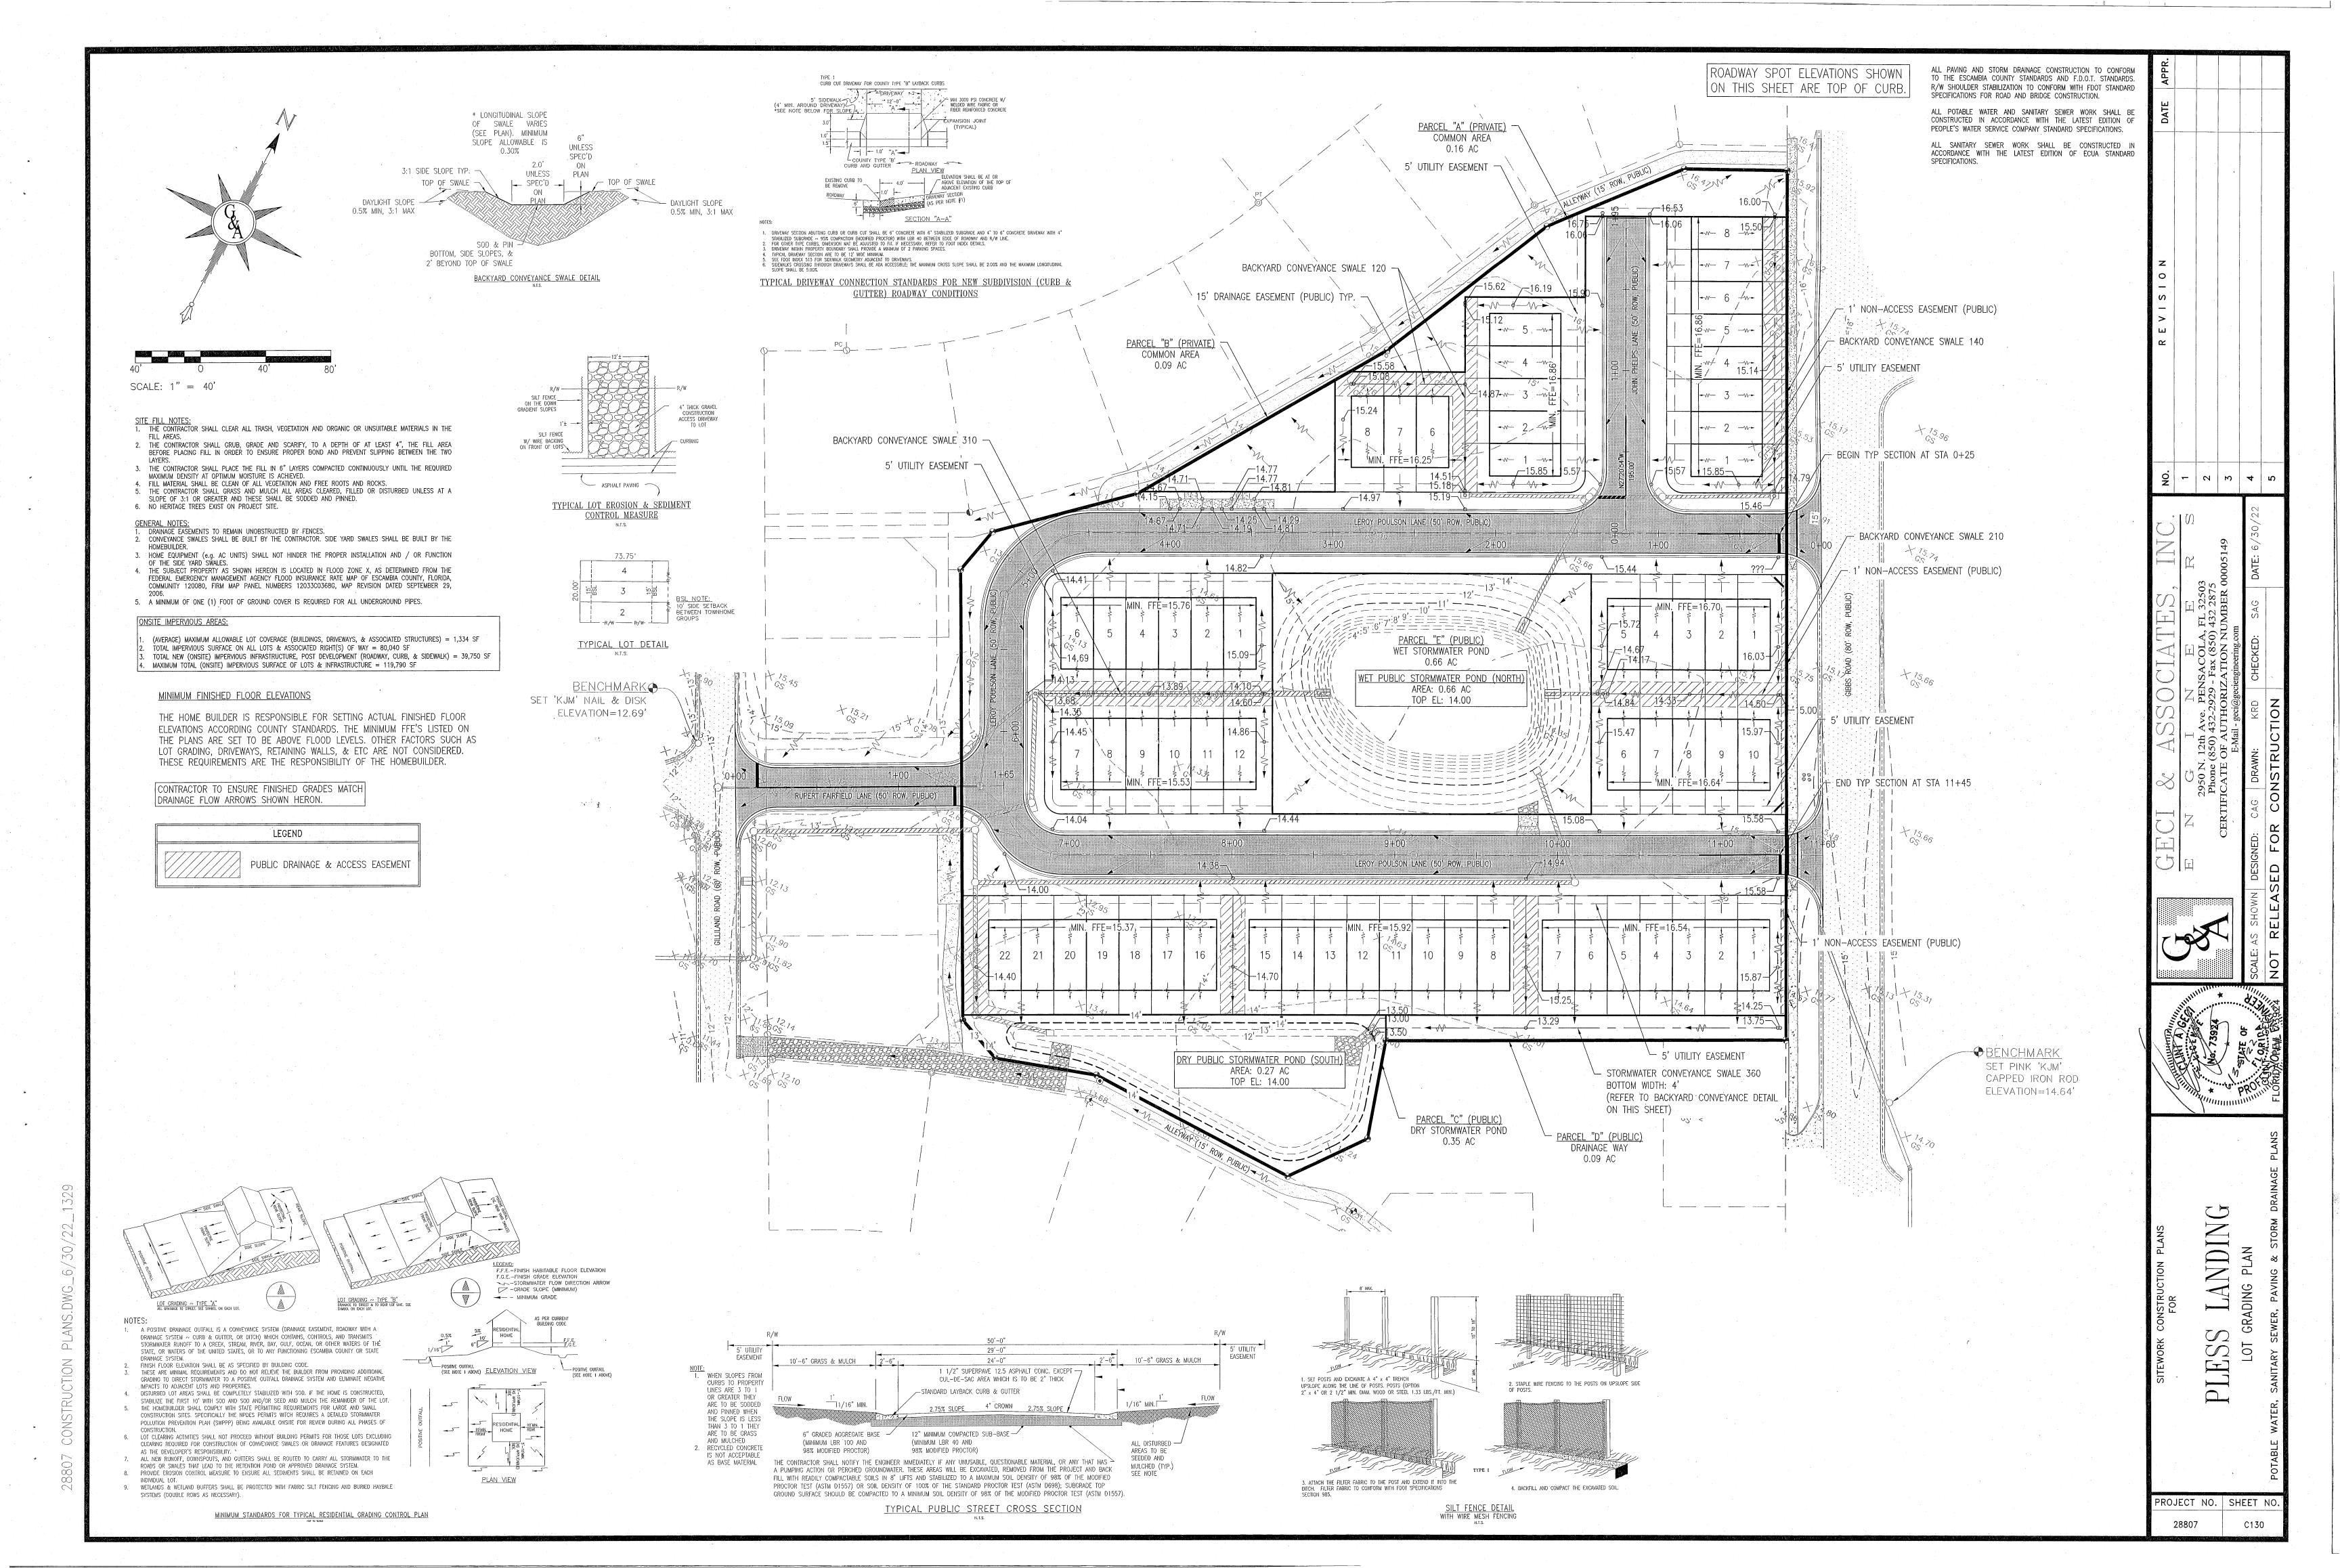

STORM STRUC	STORM STRUCTURE TABLE					
STRUCTURE NAME	STRUCTURE DETAILS					
ST DISCHARGE STRUCTURE 10	TOP EL. = 12.76 W INV OUT = 8.74					
ST DISCHARGE STRUCTURE 20	TOP EL. = 13.31 SE INV OUT = 9.05					
ST INLET 110	TOP EL. = 15.48 NE INV IN = 10.12 SW INV IN = 11.87 S INV OUT = 10.02					
ST INLET 120	TOP EL. = 15.18 NE INV OUT = 12.01					
ST INLET 130	TOP EL. = 15.53 NE INV IN = 12.05 SW INV OUT = 10.20					
ST INLET 140	TOP EL. = 15.46 SW INV OUT = 12.29					
ST INLET 210	TOP EL. = 14.84 SW INV OUT = 9.38					
ST INLET 310	TOP EL. = 14.35 SE INV IN = 6.40 SW INV IN = 6.90 NE INV OUT = 5.90					
ST INLET 320	TOP EL. = 13.99 NW INV OUT = 6.60					
ST INLET 322	TOP EL. = 13.85 NE INV OUT = 6.80					
ST INLET 330	TOP EL. = 13.97 NE INV OUT = 7.00					
ST MES 100	TOP EL. = 15.01 N INV IN = 8.15					
ST MES 200	TOP EL. = 15.00 NE INV IN = 8.15					
ST MES 300	TOP EL. = 9.49 SW INV IN = 5.20					
ST MH 02	TOP EL. = 11.86 NW INV IN = 7.84 SW INV OUT = 7.74					
ST MH 04	TOP EL. = 12.92 NE INV IN = 8.06 SE INV OUT = 7.96					
ST MH 06	TOP EL. = 13.85 SE INV IN = 8.37 SW INV OUT = 8.27					
ST MH 08	TOP EL. = 14.13 SE INV IN = 8.52 NE INV IN = 8.52					
ST MH 09	TOP EL. = 14.18 E INV IN = 8.70					
ST MH 12	TOP EL. = 15.04 NW INV IN = 8.98 SW INV OUT = 8.88					

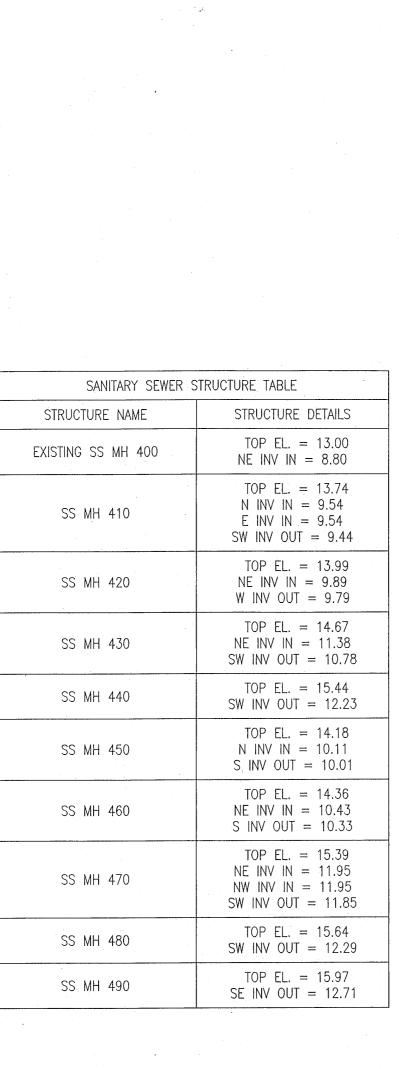

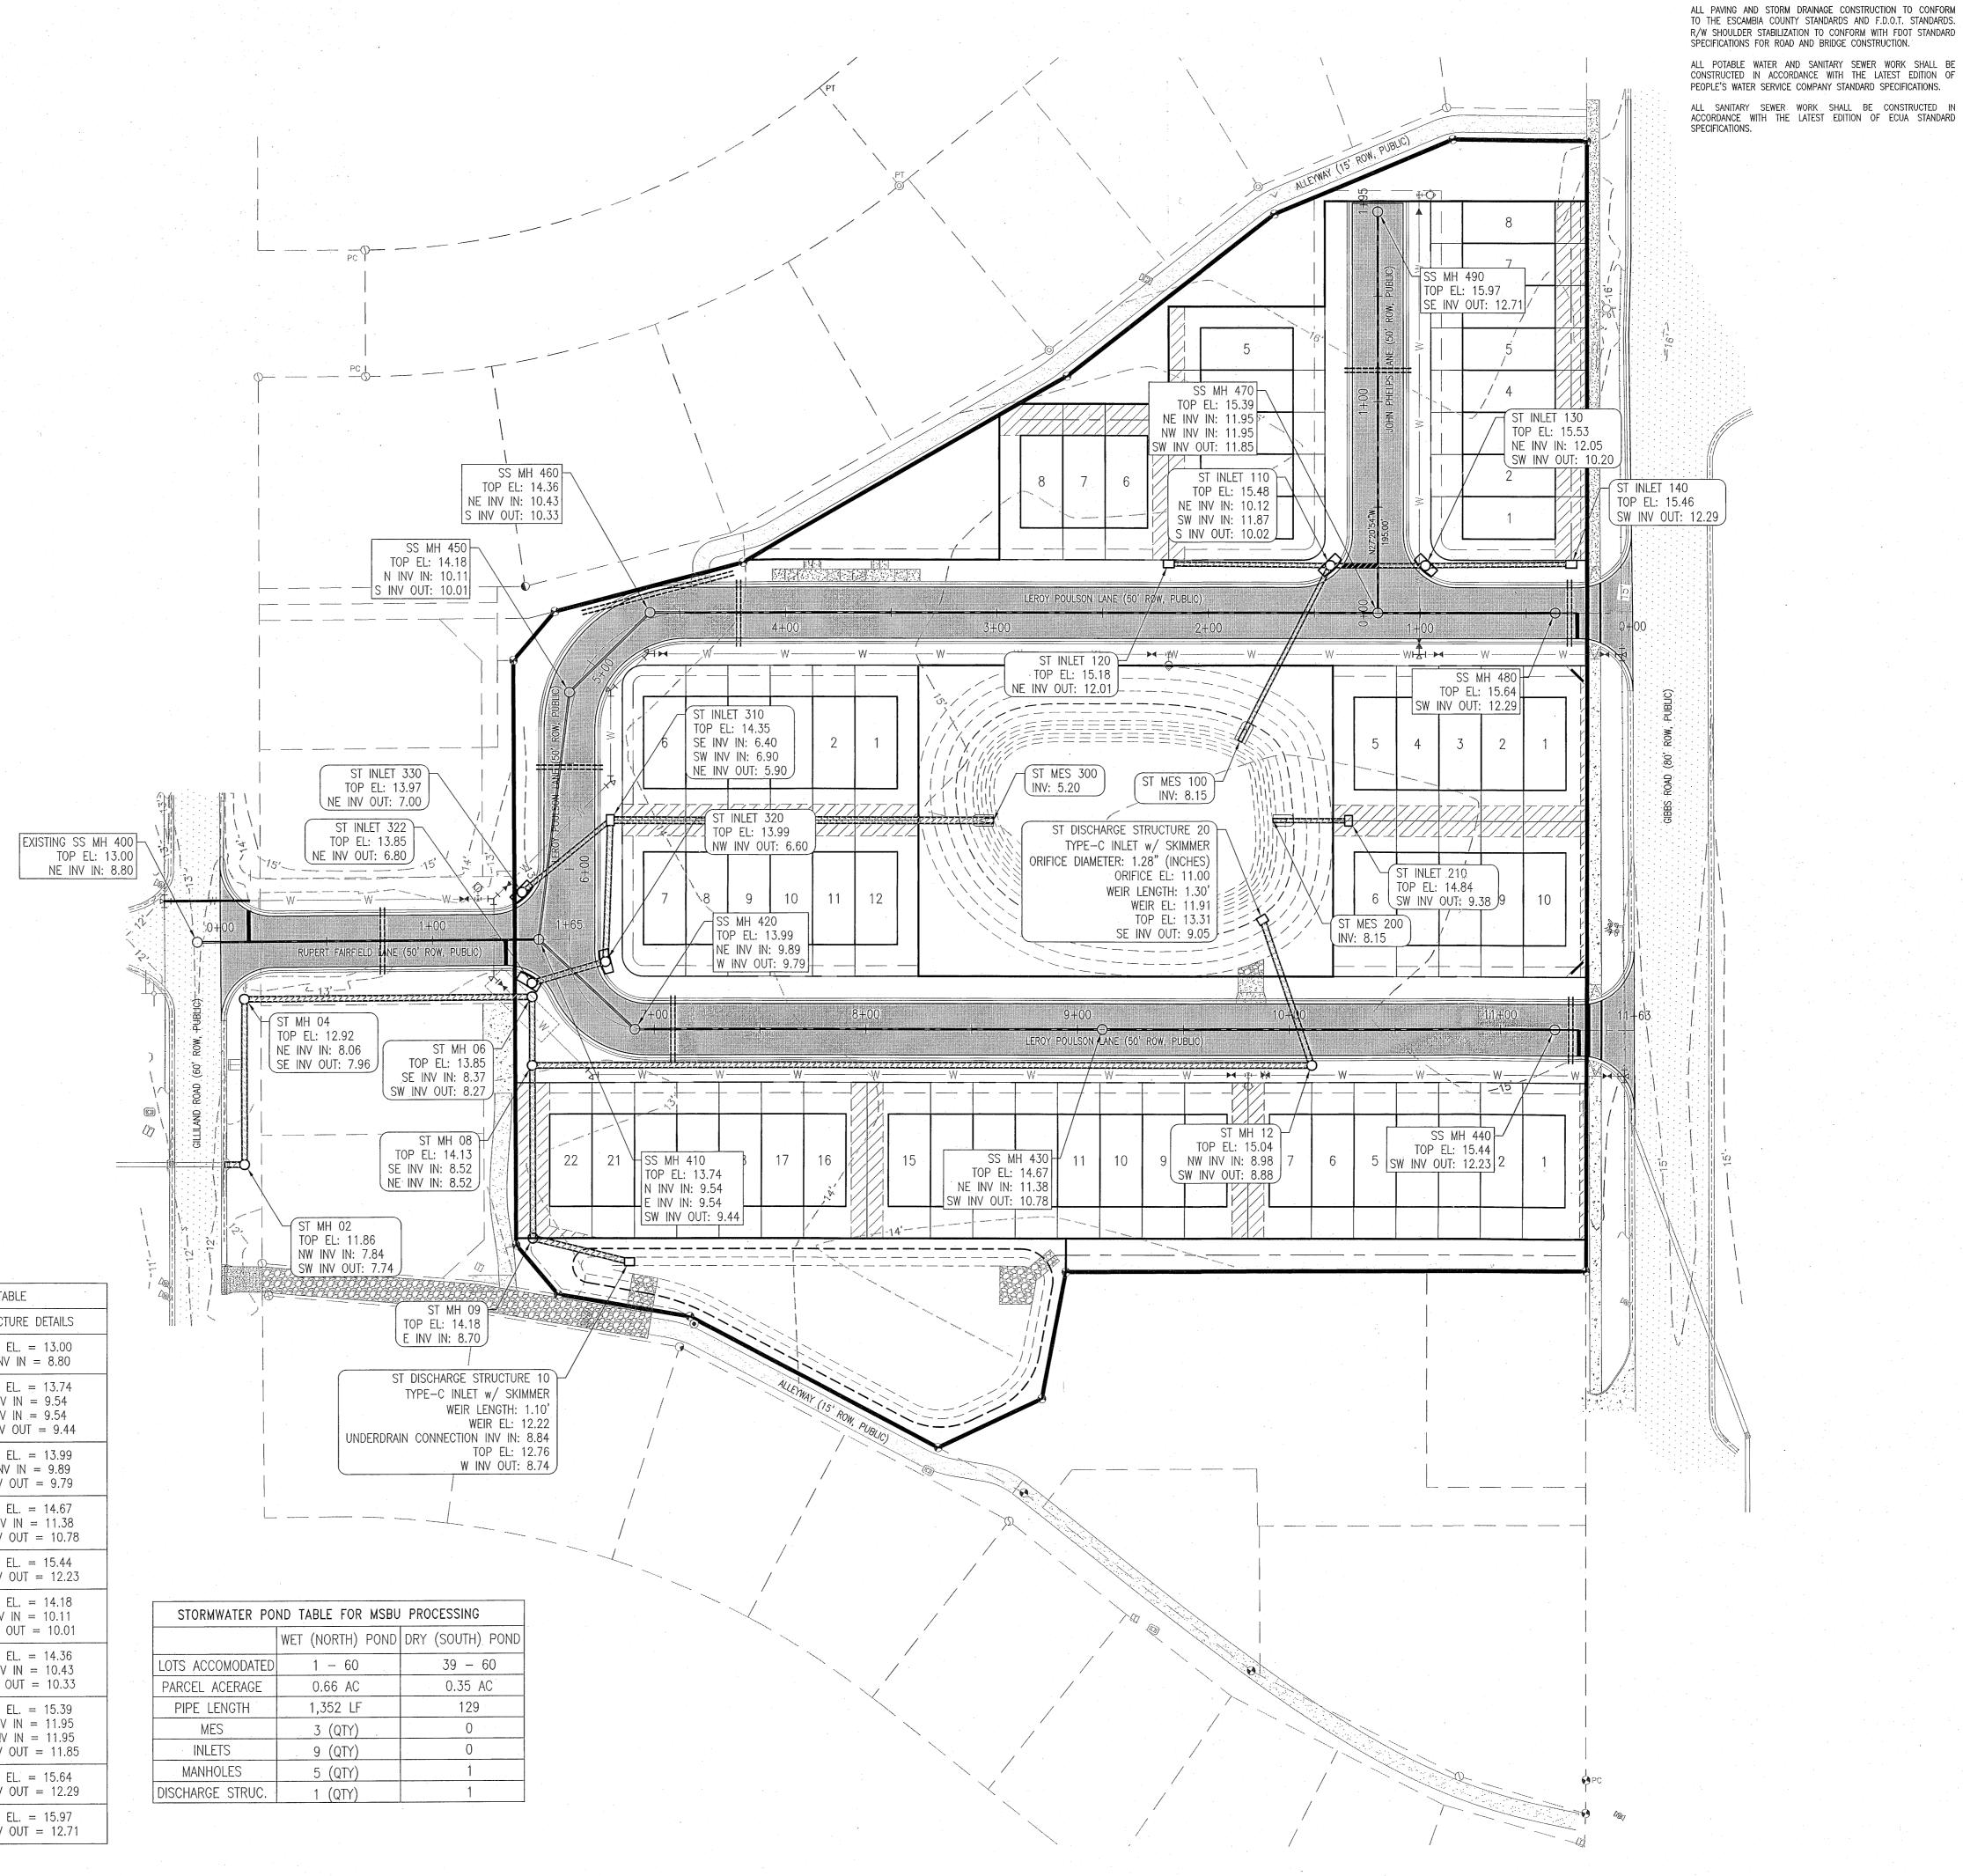



LANDING SEWER STRUCTU

PROJECT NO. SHEET NO

C135

ALL POTABLE WATER AND SANITARY SEWER WORK SHALL BE CONSTRUCTED IN ACCORDANCE WITH THE LATEST EDITION OF PEOPLE'S WATER SERVICE COMPANY STANDARD SPECIFICATIONS. ALL SANITARY SEWER WORK SHALL BE CONSTRUCTED IN ACCORDANCE WITH THE LATEST EDITION OF ECUA STANDARD SPECIFICATIONS.

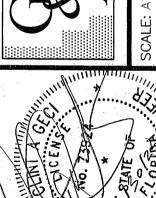


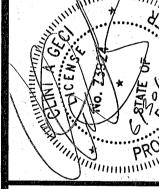


LANDING
LANE PLAN & PROFIL PLESS

OY POULSON 1

PROJECT NO. SHEET NO.

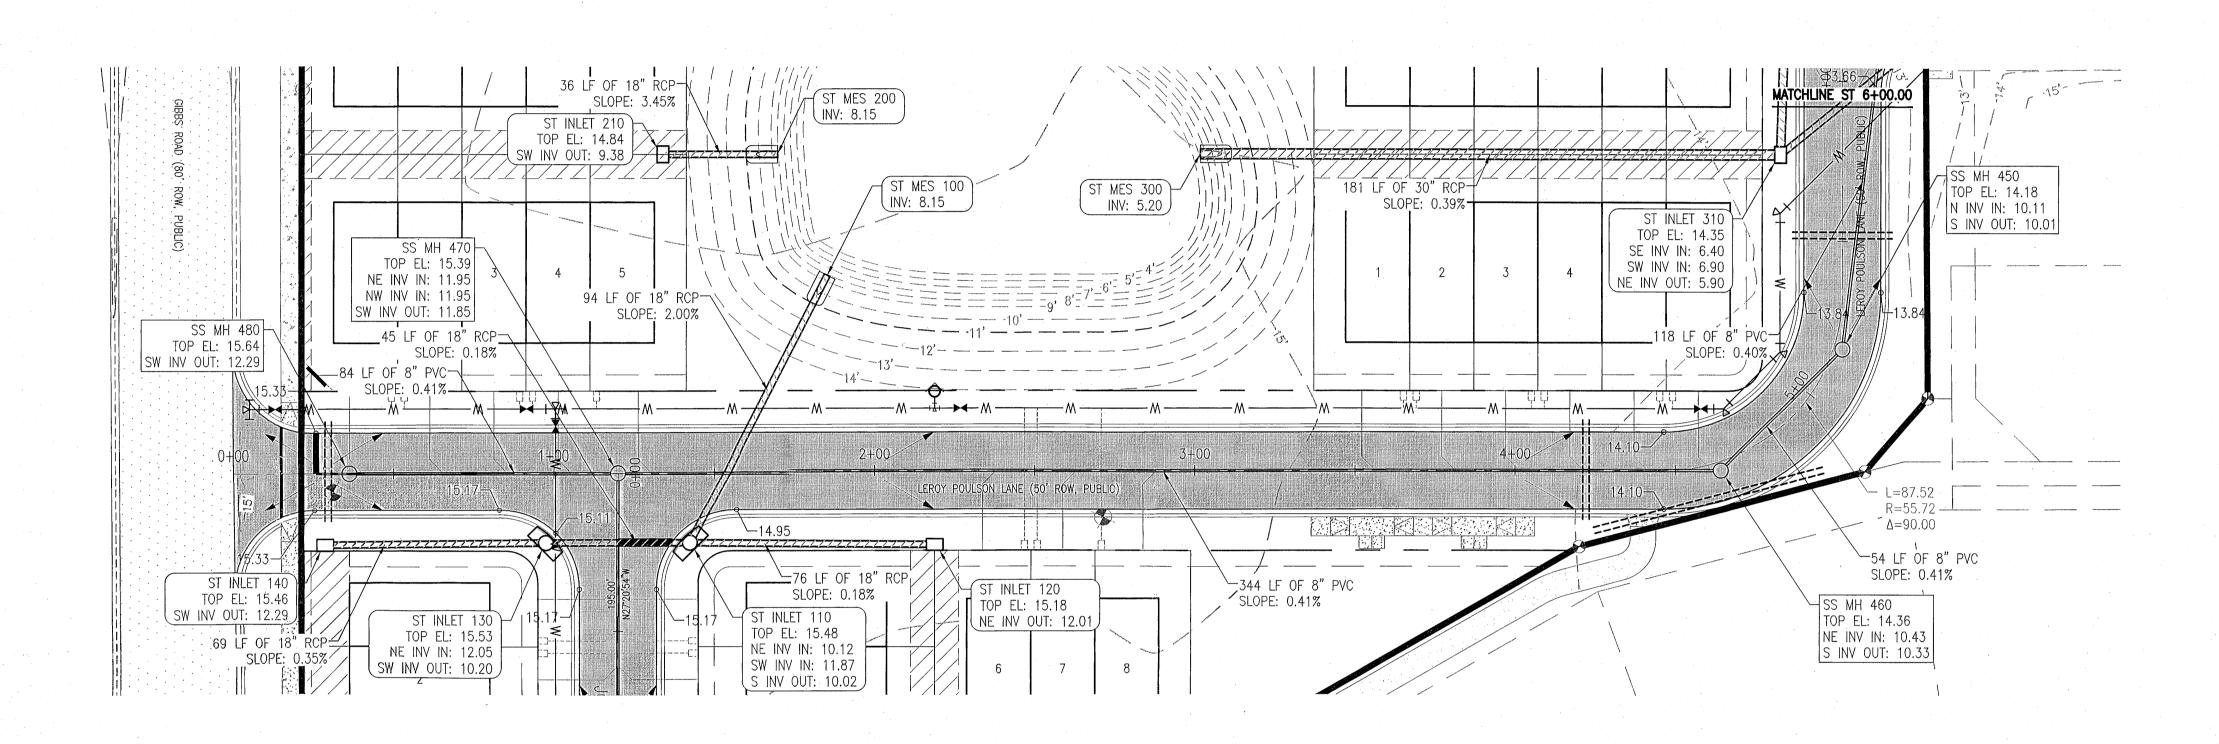

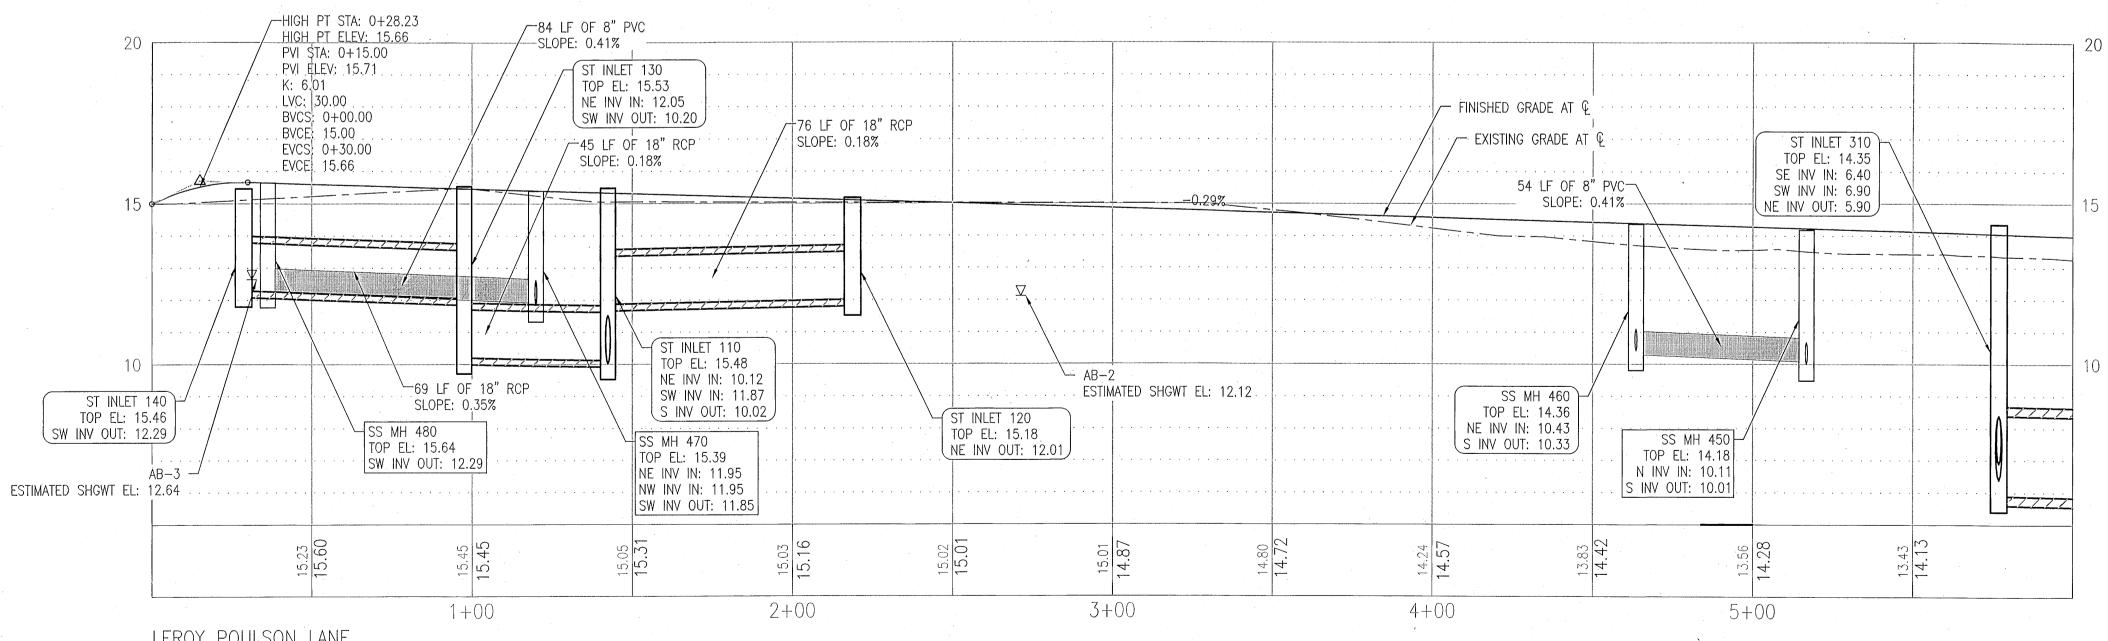

STA 0+00 - STA 6+00 VERT. EXAG. = 10

LEROY POULSON LANE

8+00

9+00

10+00

11+00

TOP EL: 13.74 N INV IN: 9.54 E INV IN: 9.54

<u>LEROY POULSON LANE</u> STA 6+00 - STA 11+71

VERT. EXAG. = 10

7+00

SW INV OUT: 9.44


ALL PAVING AND STORM DRAINAGE CONSTRUCTION TO CONFORM TO THE ESCAMBIA COUNTY STANDARDS AND F.D.O.T. STANDARDS. R/W SHOULDER STABILIZATION TO CONFORM WITH FDOT STANDARD SPECIFICATIONS FOR ROAD AND BRIDGE CONSTRUCTION.

ALL POTABLE WATER AND SANITARY SEWER WORK SHALL BE CONSTRUCTED IN ACCORDANCE WITH THE LATEST EDITION OF PEOPLE'S WATER SERVICE COMPANY STANDARD SPECIFICATIONS. ALL SANITARY SEWER WORK SHALL BE CONSTRUCTED IN ACCORDANCE WITH THE LATEST EDITION OF ECUA STANDARD SPECIFICATIONS.


S LANDING LANE PLAN & PROFIL POULSON 1 PLESCA LEROY POULSON

C210


PROJECT NO. | SHEET NO 28807

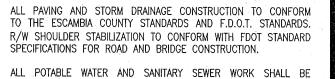


CONSTRUCTED IN ACCORDANCE WITH THE LATEST EDITION OF PEOPLE'S WATER SERVICE COMPANY STANDARD SPECIFICATIONS. ALL SANITARY SEWER WORK SHALL BE CONSTRUCTED IN ACCORDANCE WITH THE LATEST EDITION OF ECUA STANDARD

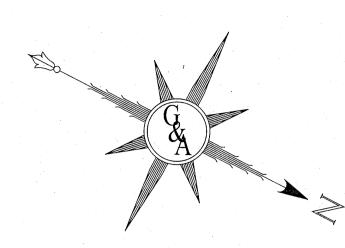





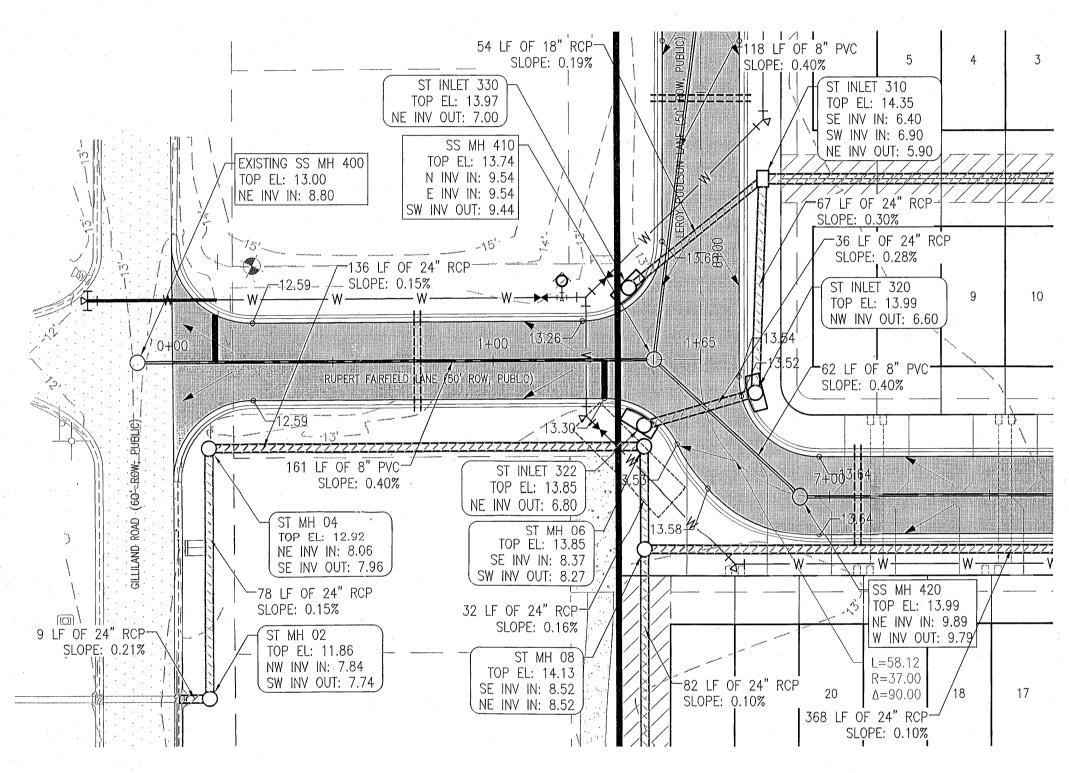

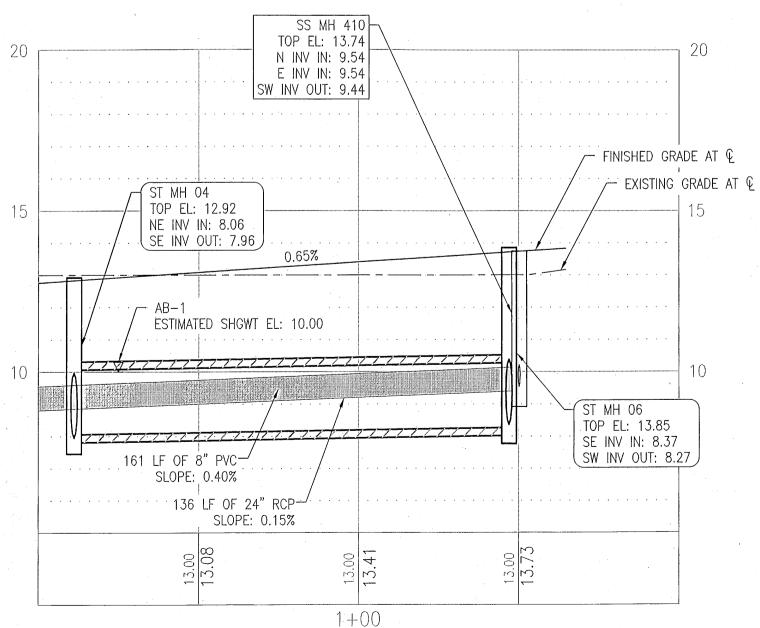

RUPERT FAIRFIELD LANE STA 0+00 - STA 2+00VERT. EXAG. = 10

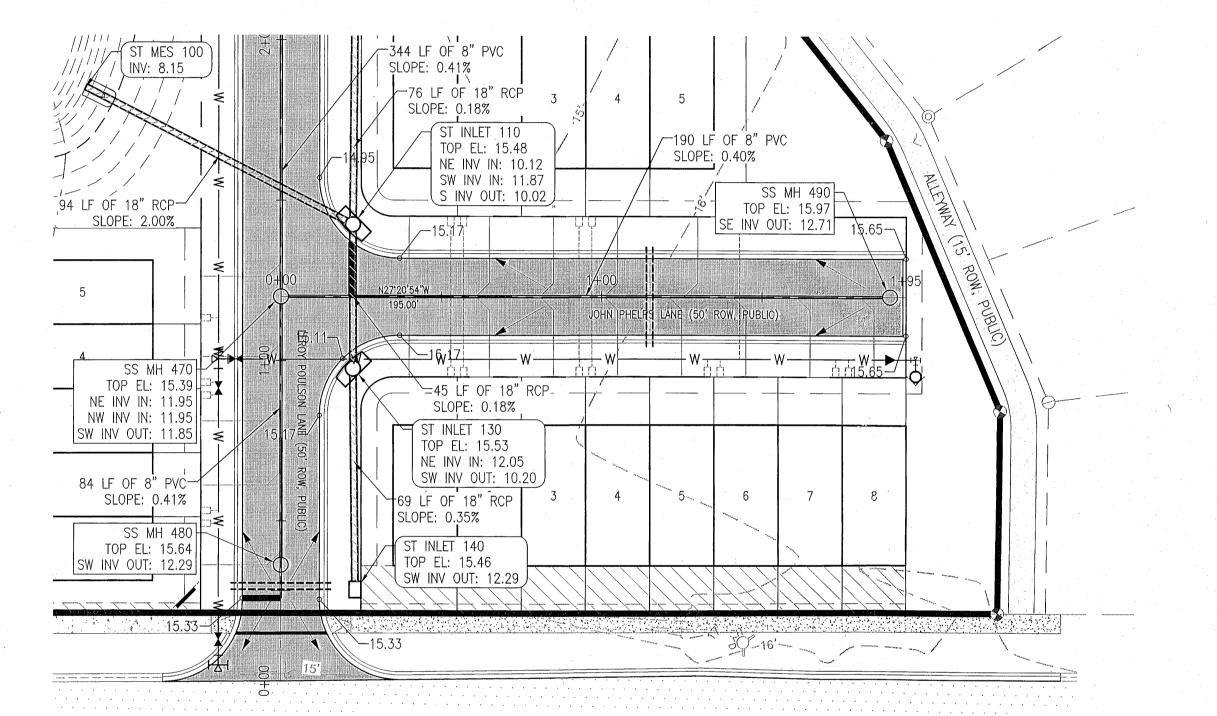

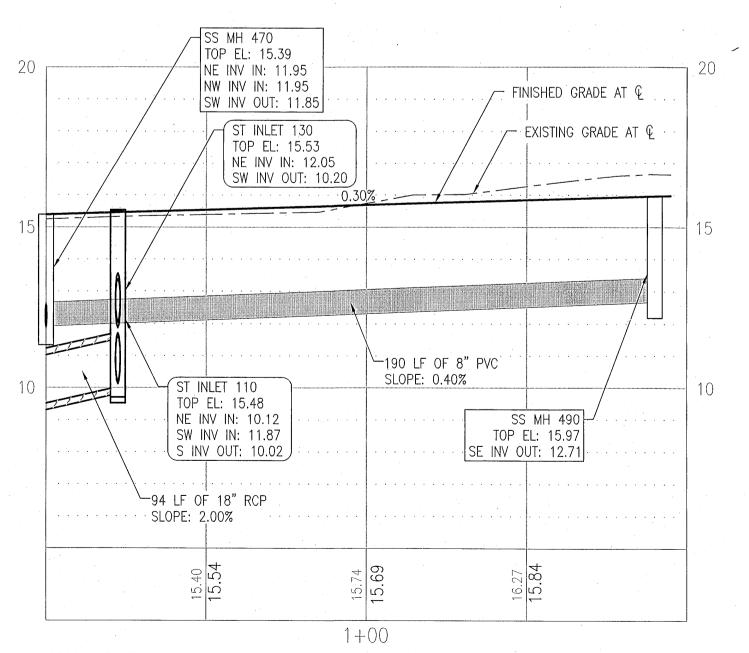


<u>JOHN PHELPS LANE</u> STA 0+00 - STA 2+00 VERT. EXAG. = 10


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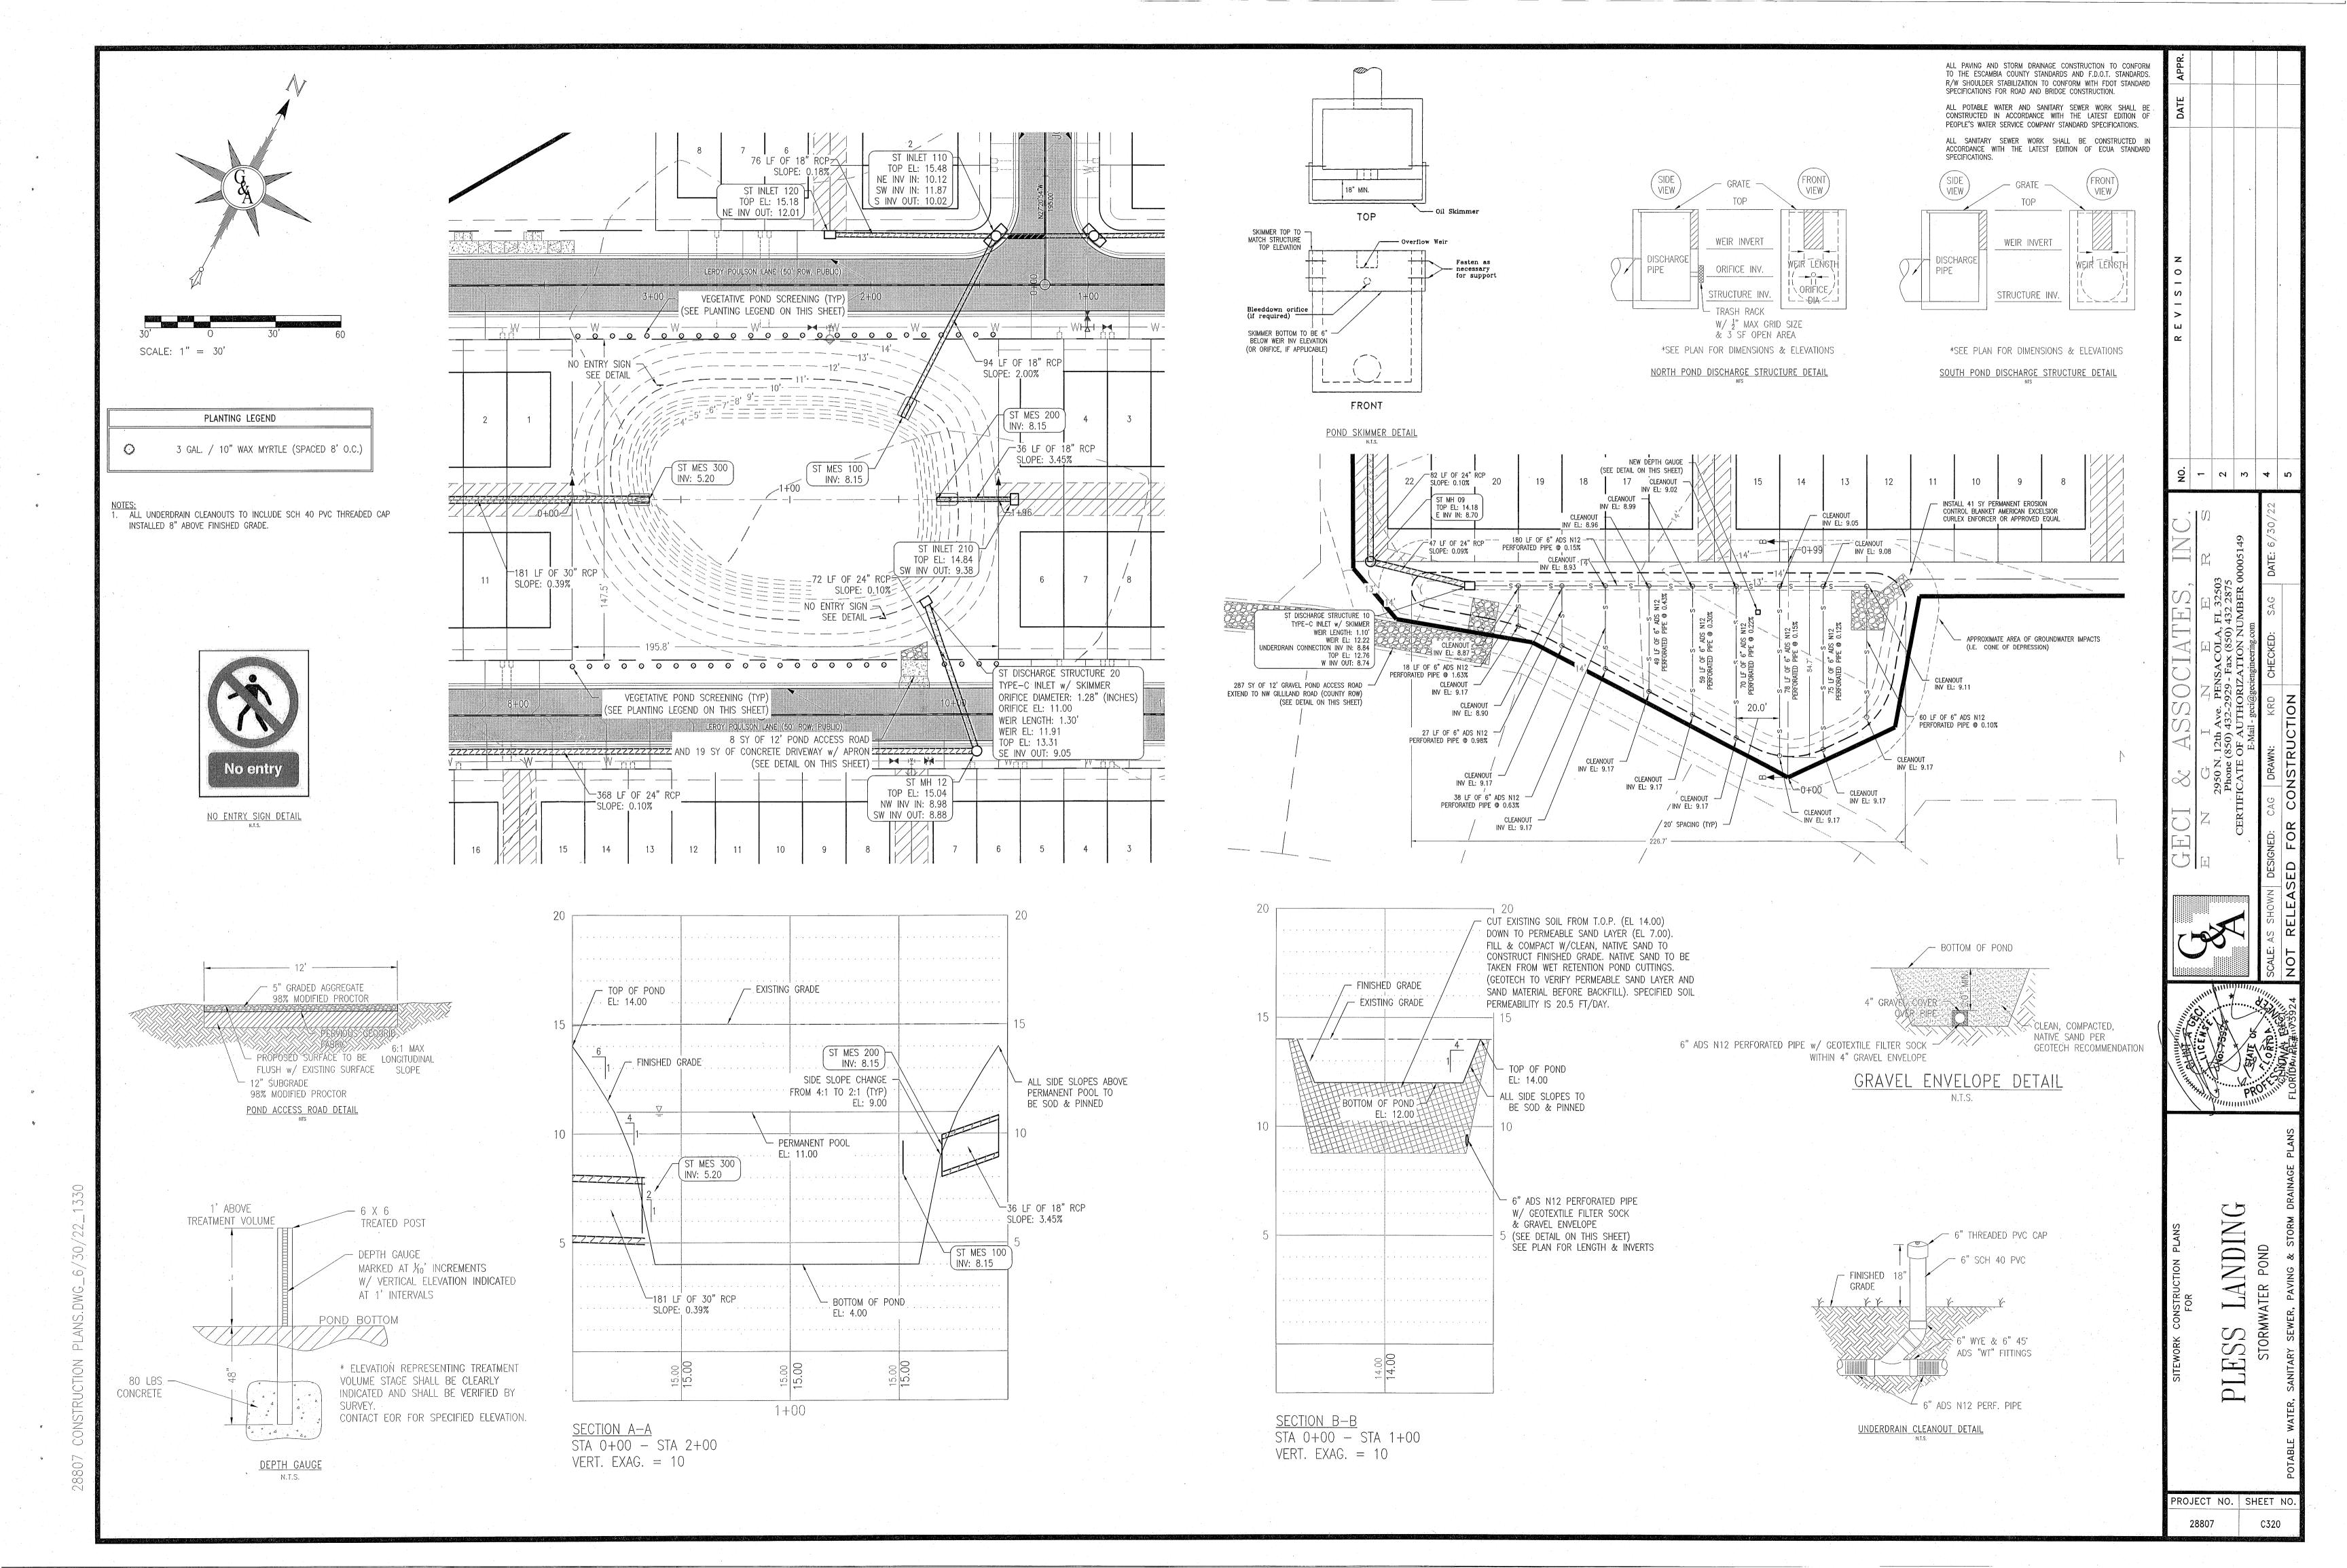
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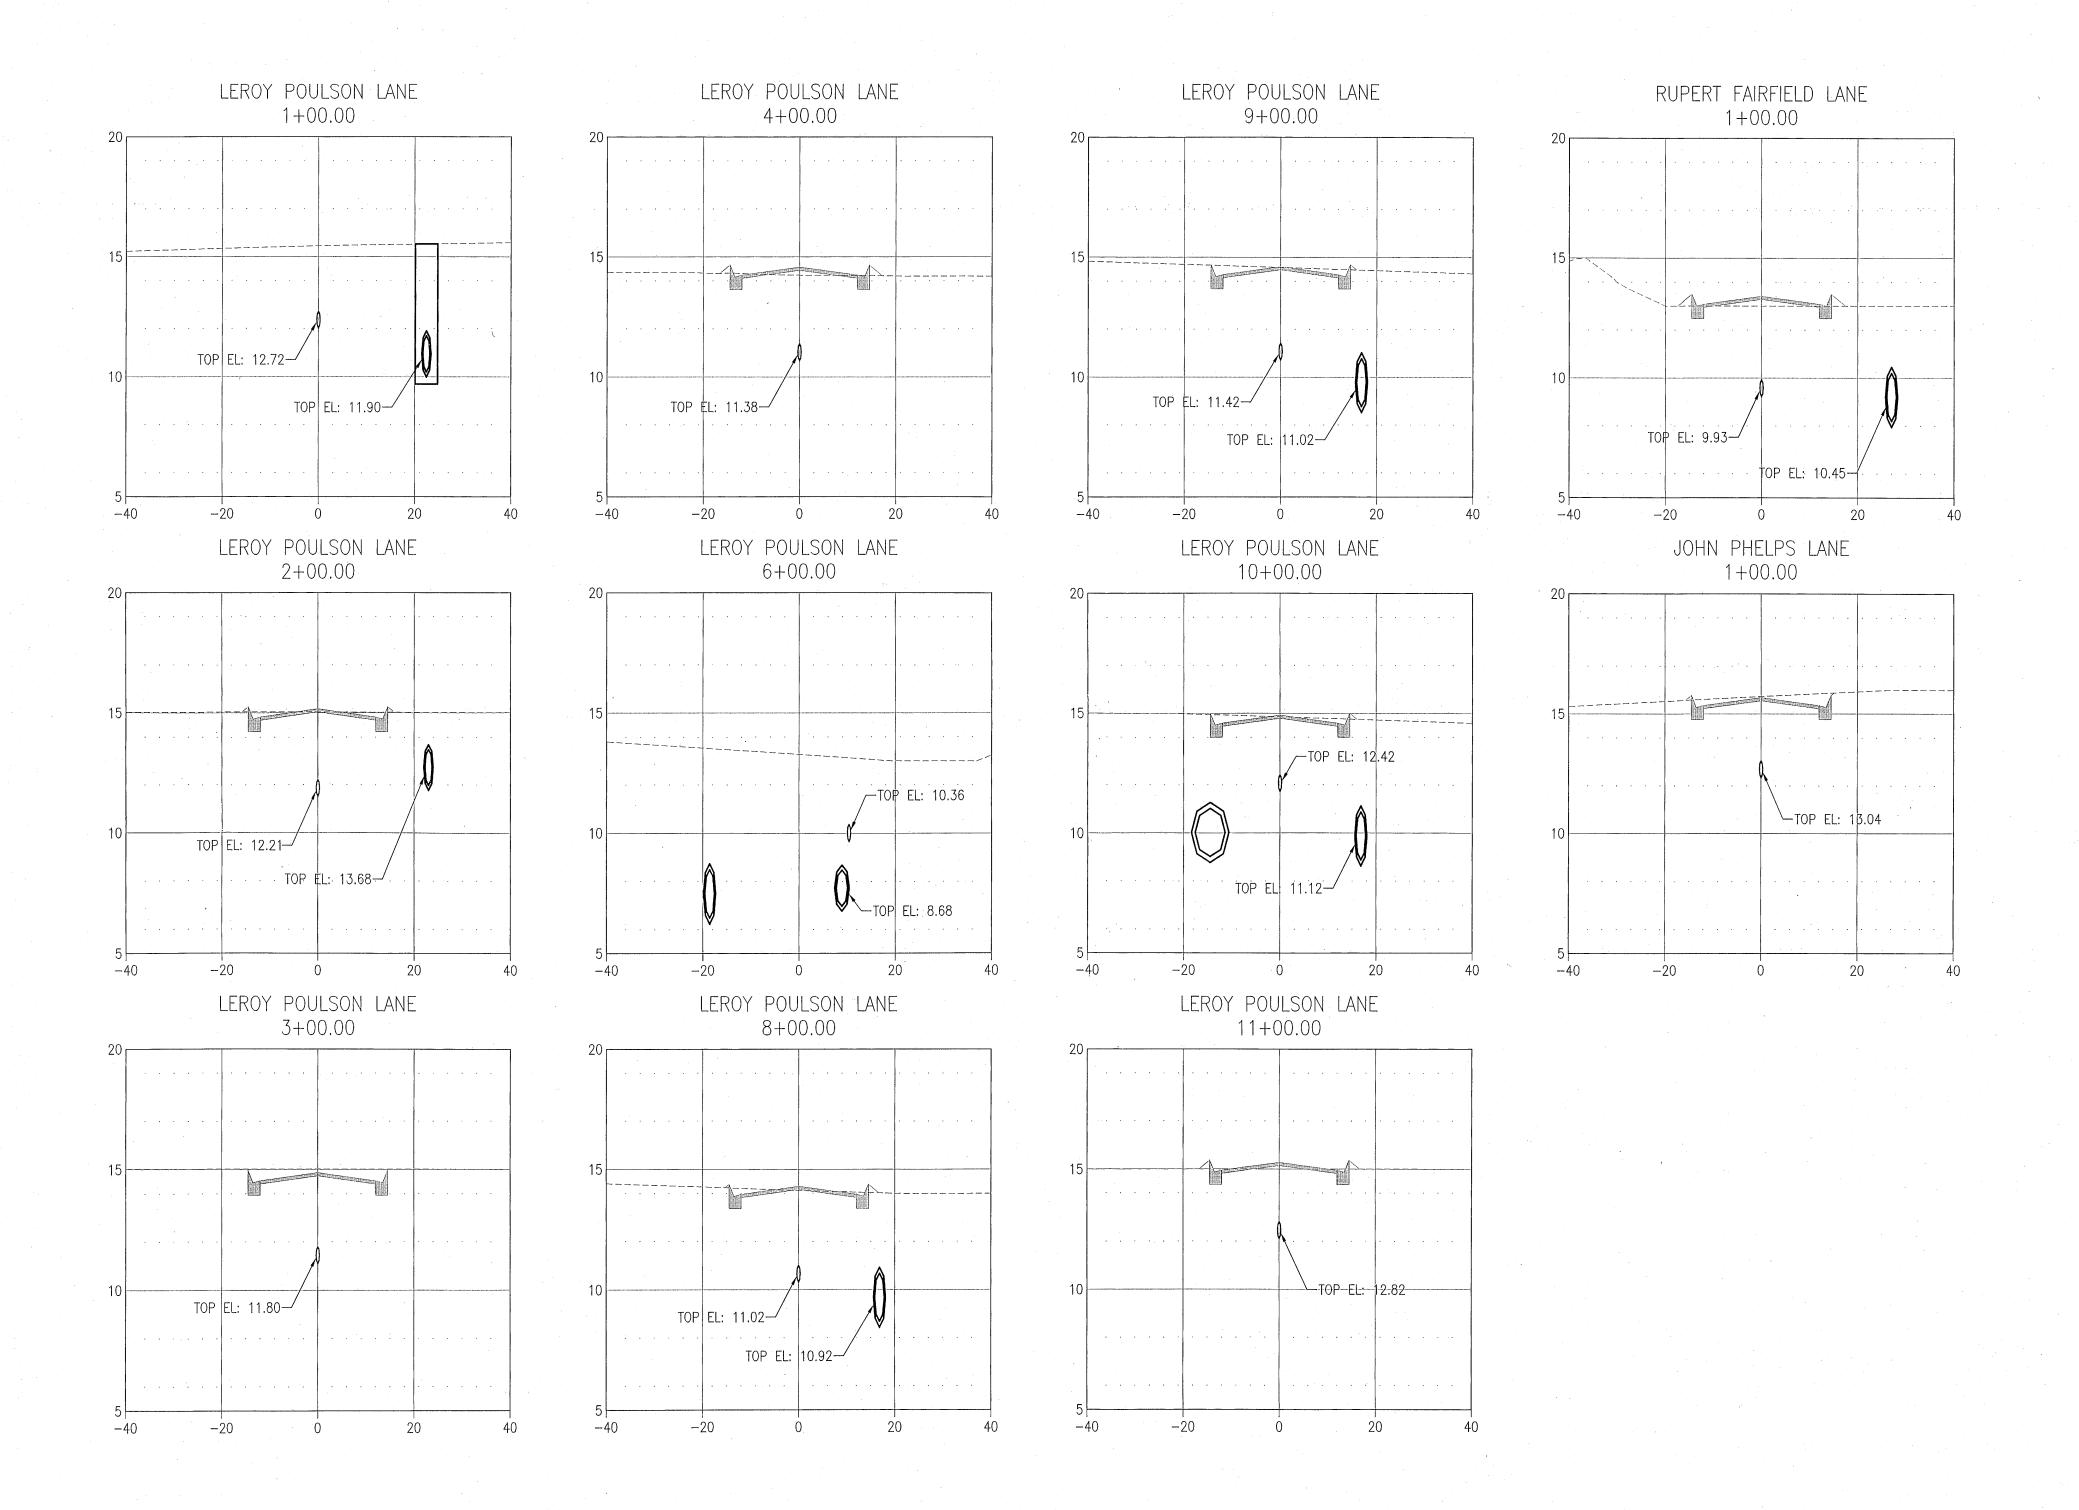



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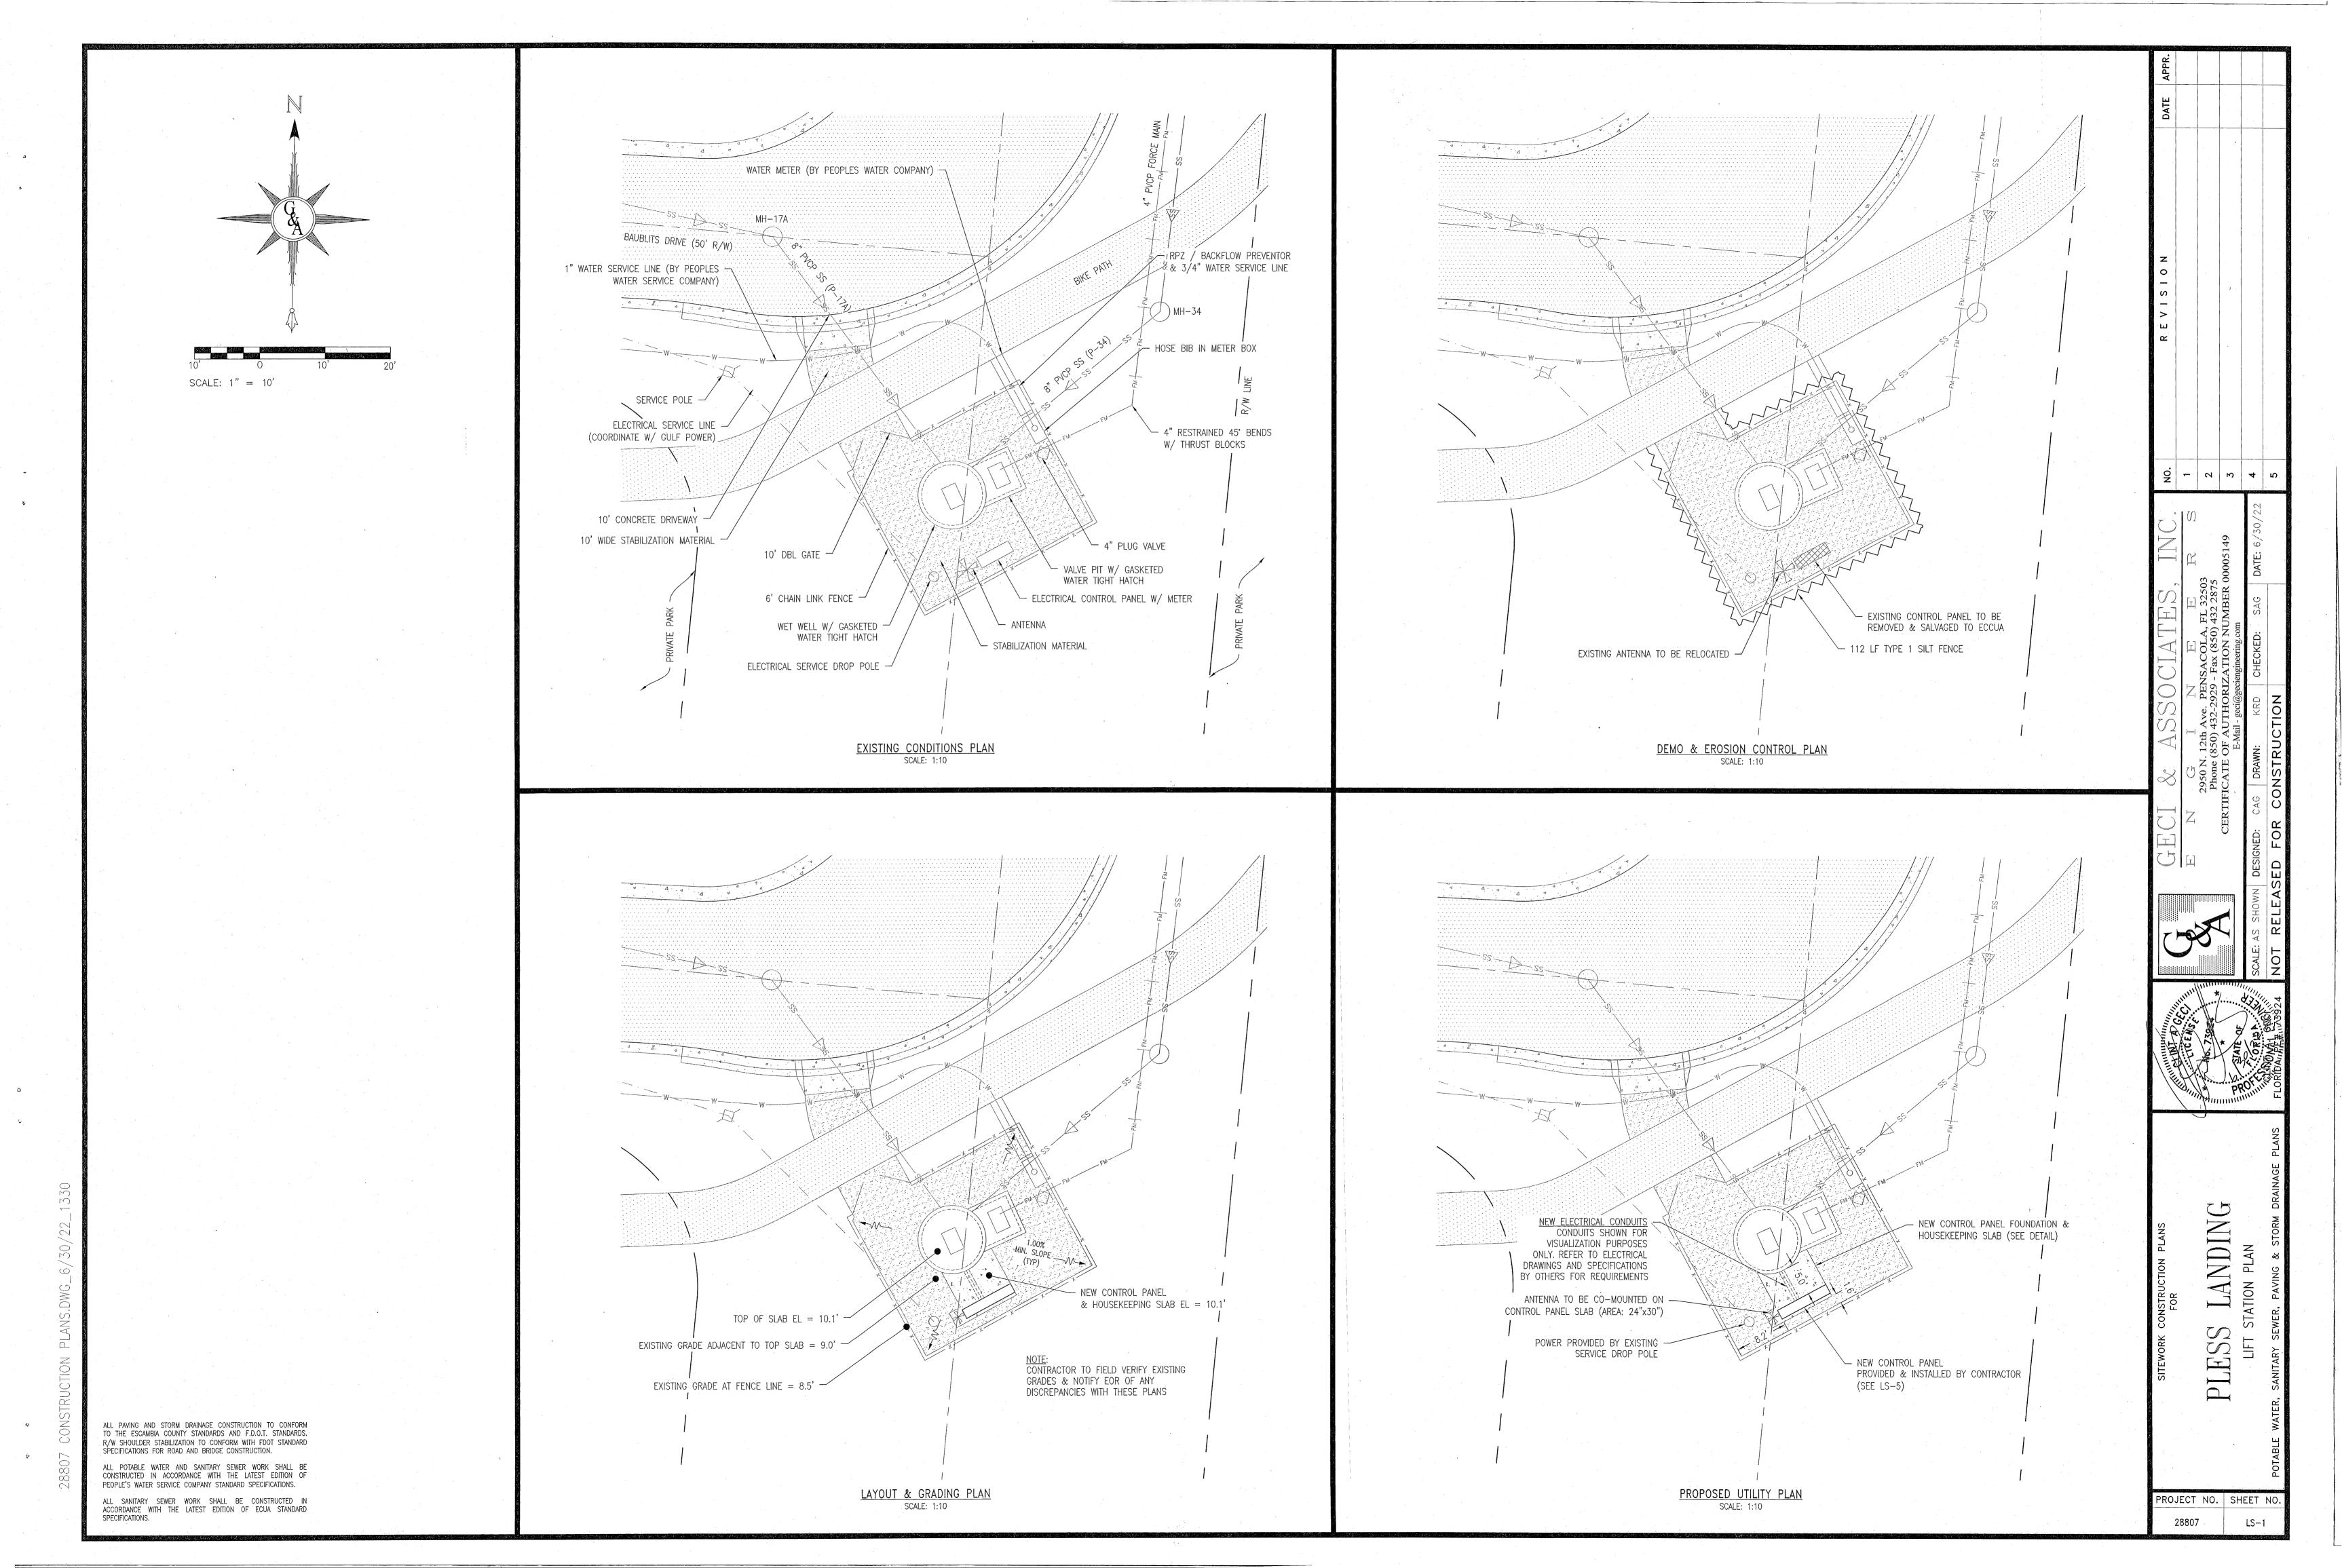


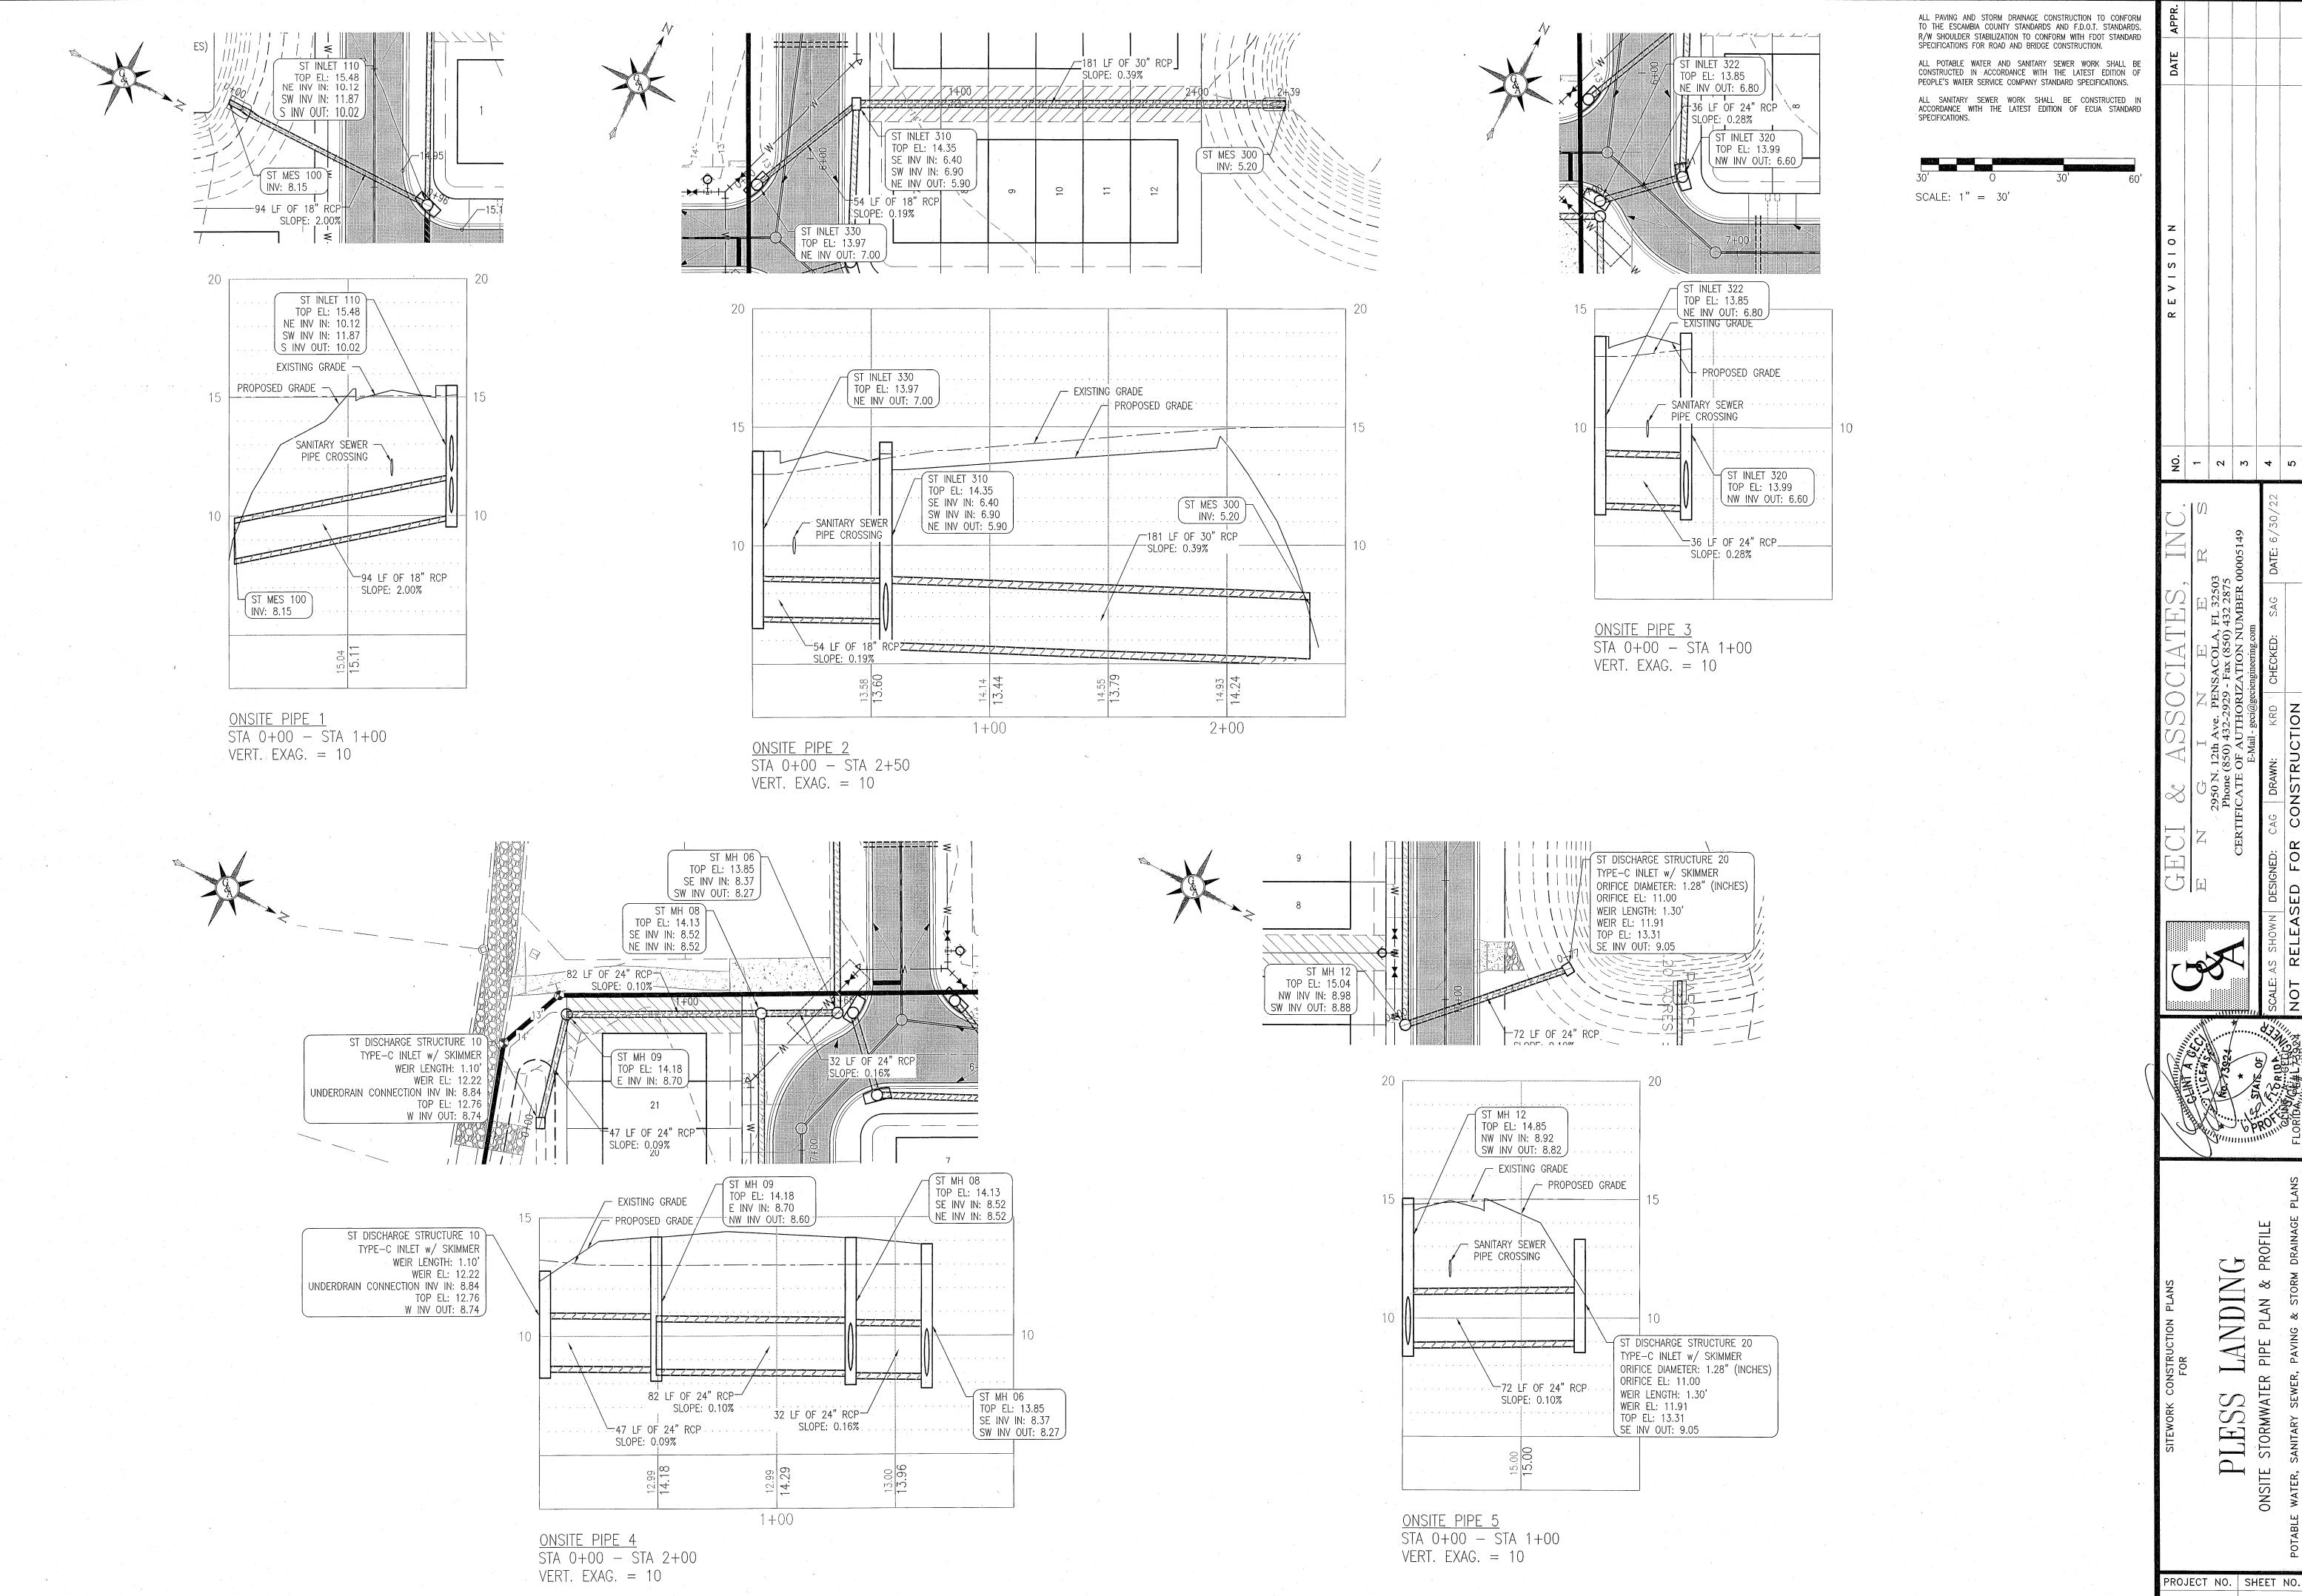

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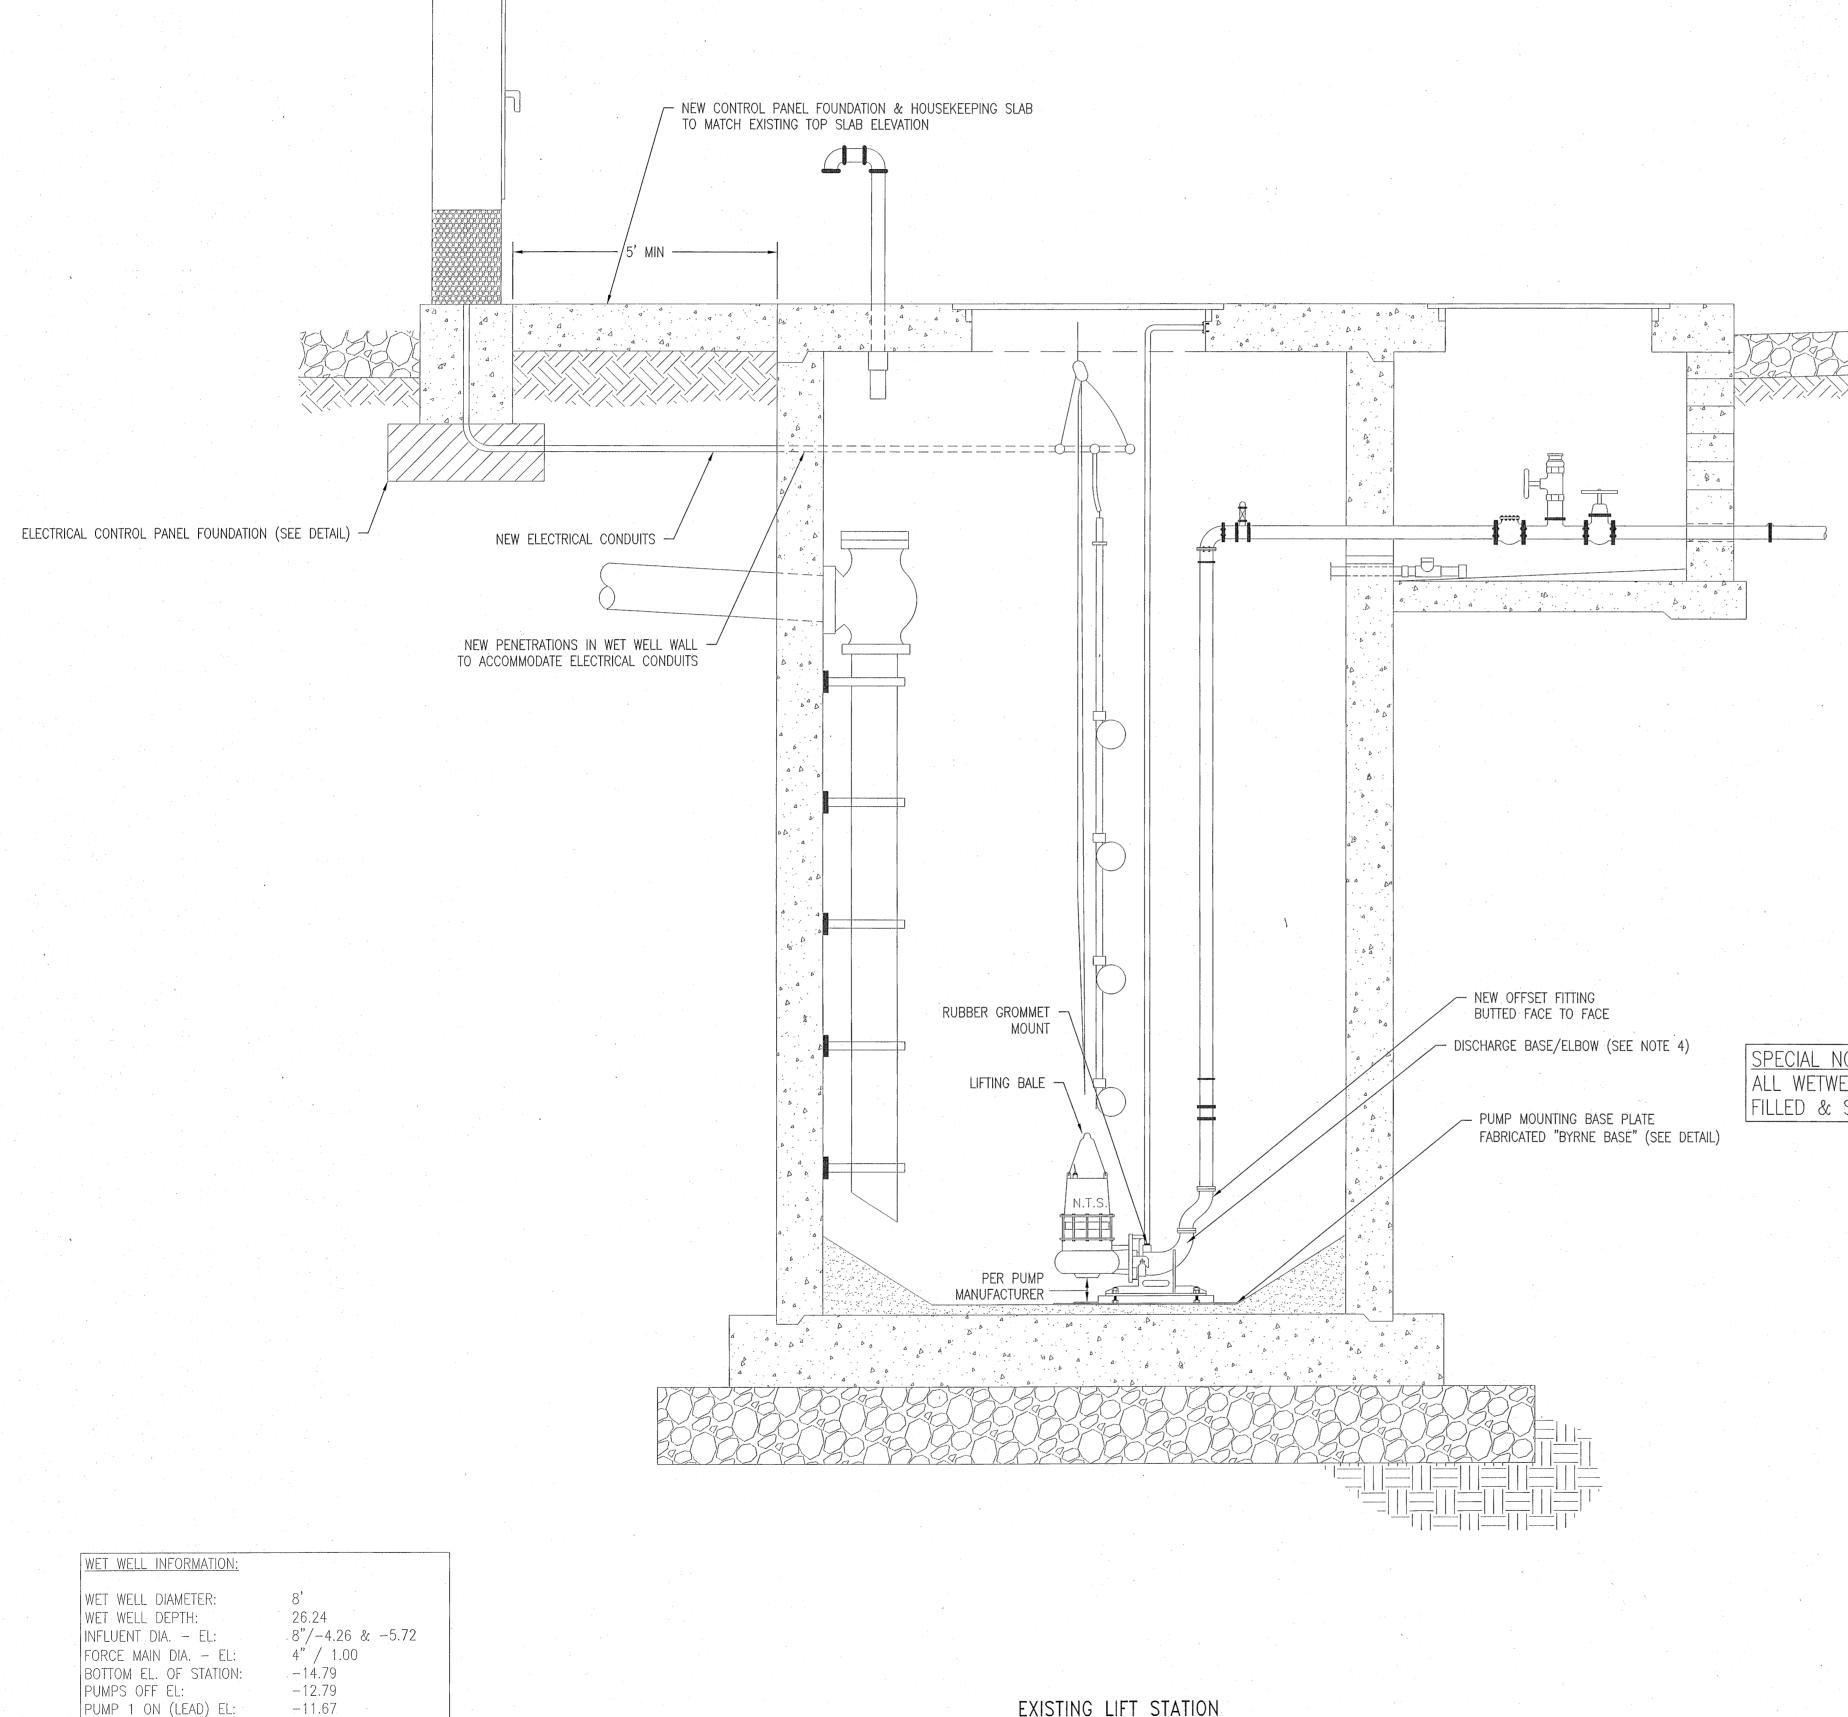
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PUMP 2 ON (LAG) EL:

HIGH LEVEL ALARM EL:

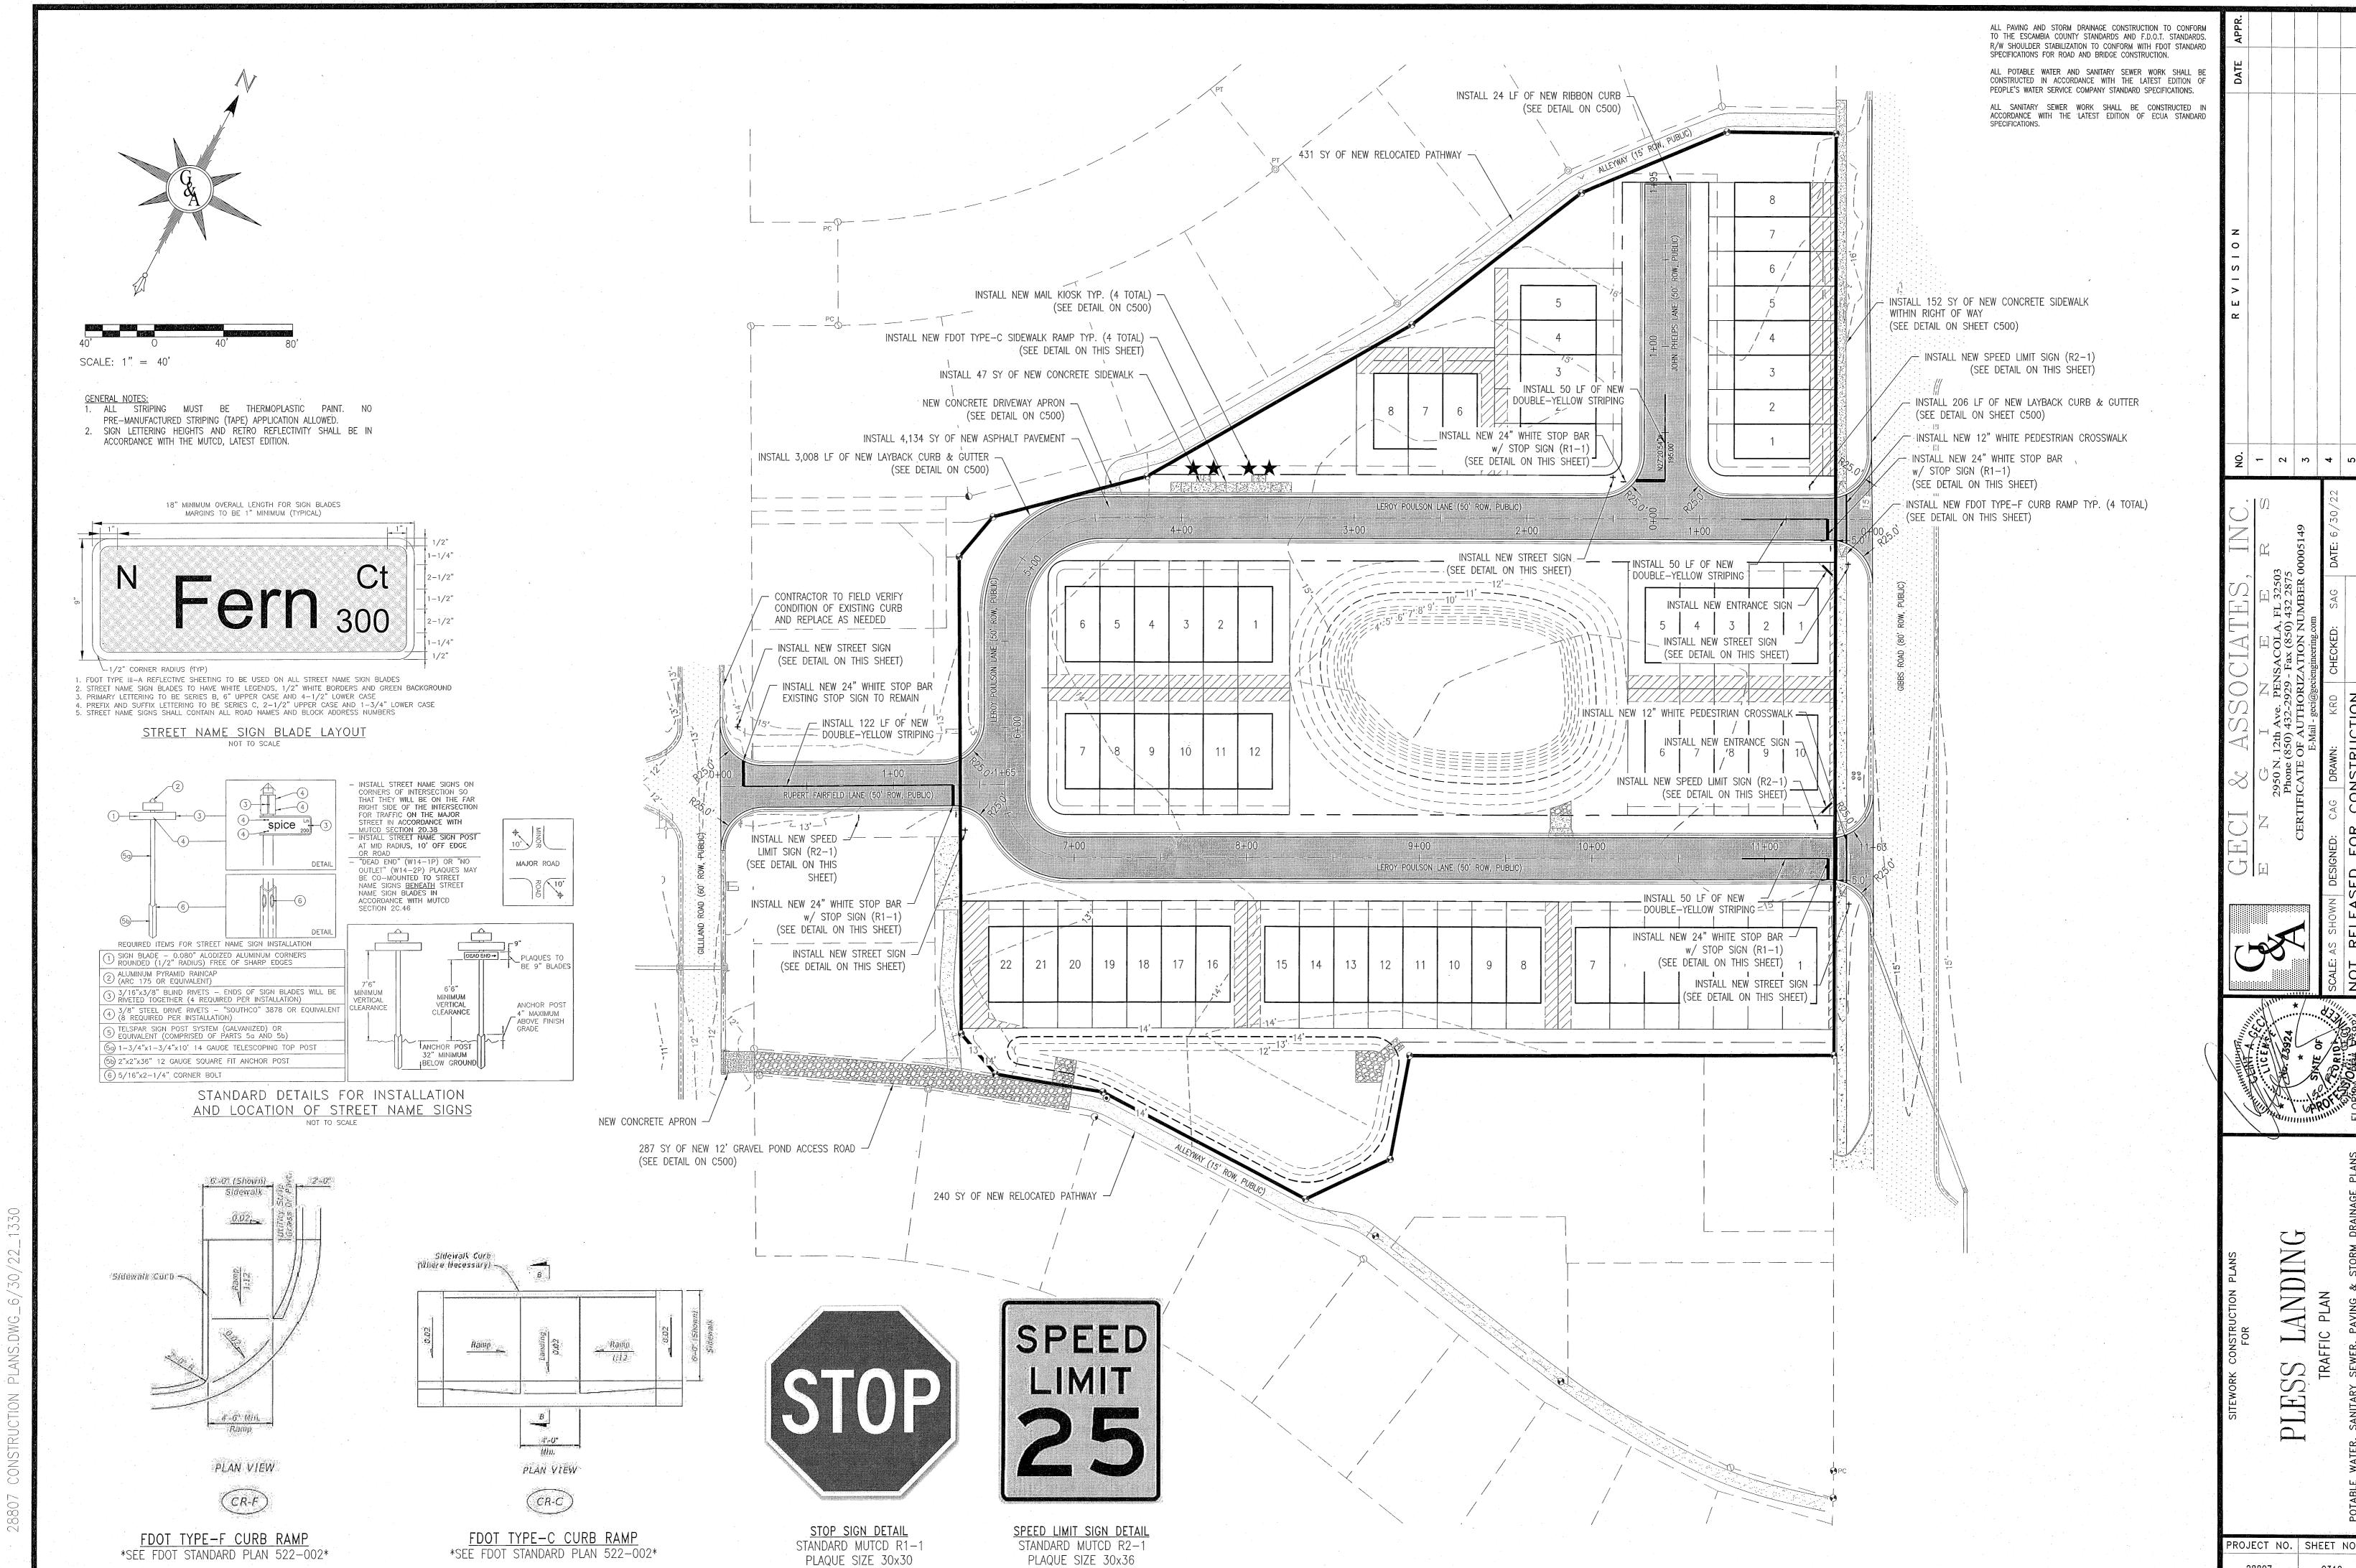TOP EL. OF STATION:

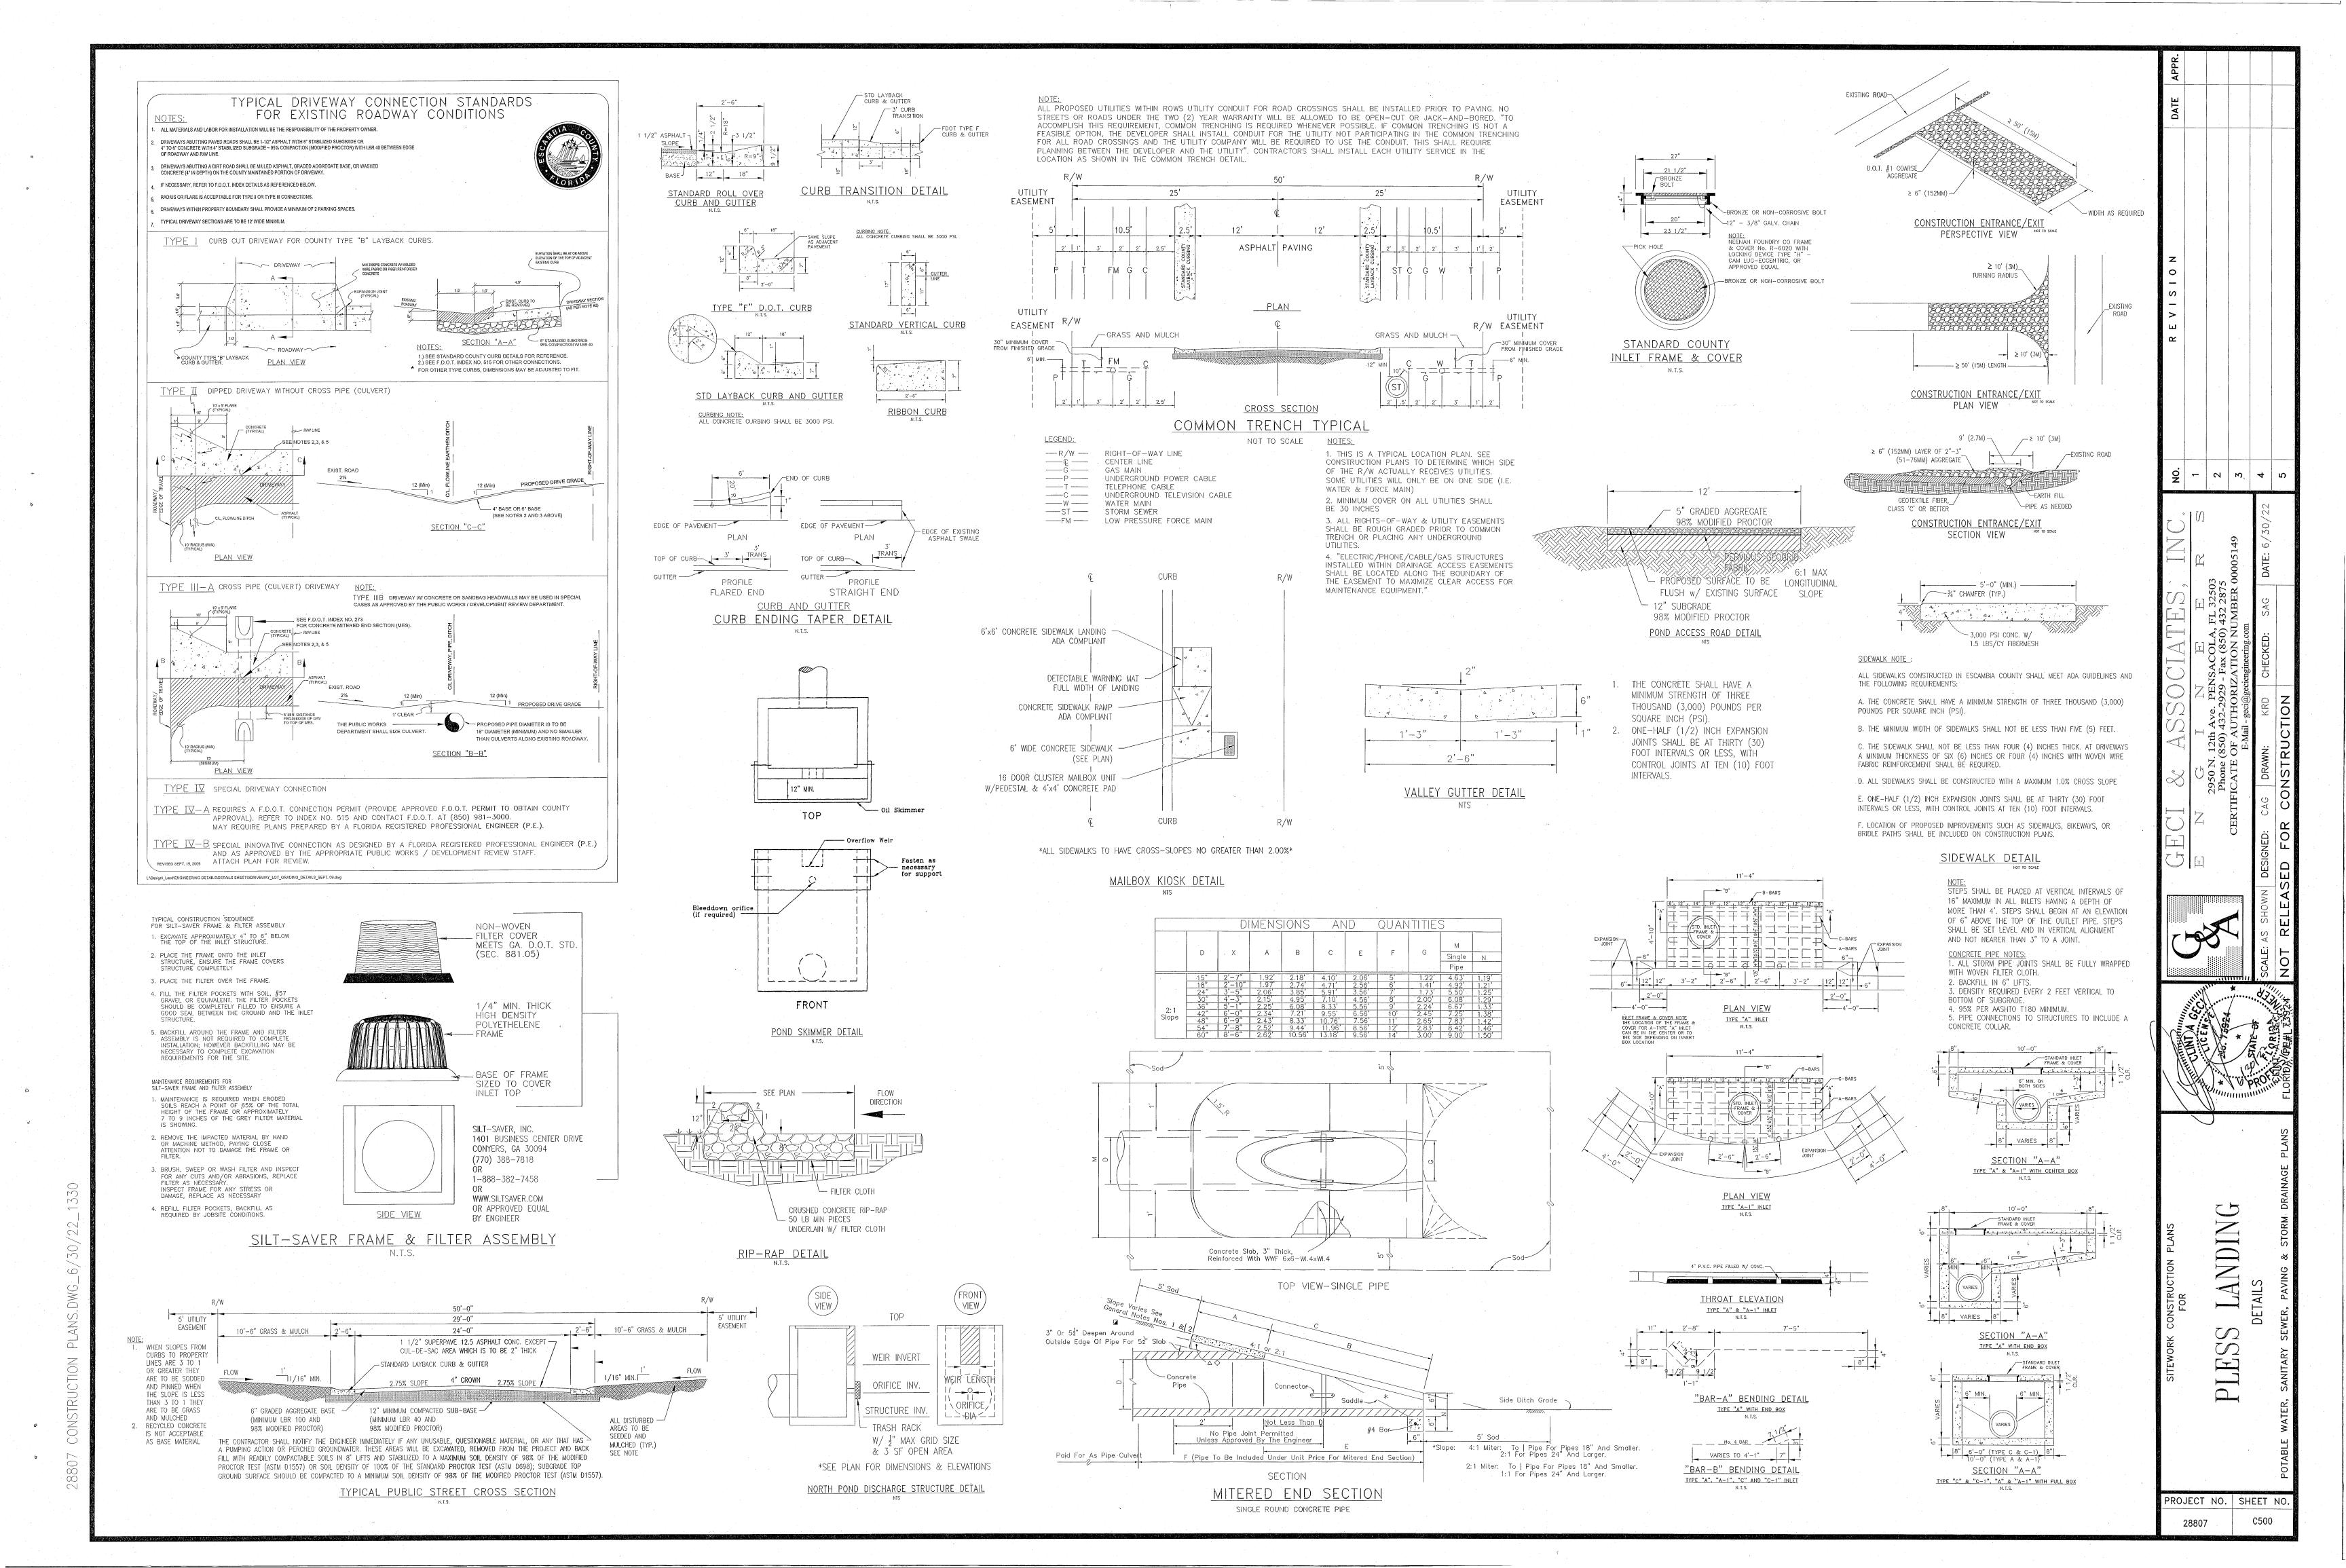

Lift Station Pump Selection Worksheet

This document shall be prepared by the Engineer of Record (EOR) and used to evaluate the three best pump options from ECUA's list of approved manufacturers for the project listed below. The pumps listed are not necessarily 'equal' with respect to overall performance, price, etc; however, they have been reviewed and approved by ECUA. These three pumps shall be listed on the plans in order to allow Bidders to price and use any of them on this project.

Project Name: Pless Landing

EOR/Company: Clint Geoi, Geoi & Associates

ECUA Project Manager: Robyn Egan Design pump rate (gpm): 200 and TDH (feet): 92.9 - 207.2

Pump Property	Pump 'A'	Pump 'B'	Pump 'C'
Manufacturer/Model #	KSB KRT F 80-252/184XEG2-S		
Supplier Company Name	Pump & Process		
Sales Rep Name	Butch Branton		
Vortex or Non-clog*	Vortex	A State of the sta	
RPM*	1800		
Impeller diameter (in.)*	9.8		
Duty point flow, head (gpm,ft)*	198 @ 89.8'		
Shutoff Head (ft)	96.8		
Shutoff head — Duty point head	89.8		
Duty point efficiency (%)*	44.5%		
Duty Point Motor Size (HP)*	10.1		
NOL motor size (HP)*	25		
NOL Motor FLA Rating (Amps)	33		
Voltage required (V)	460		
Max. Impellor Size (in.)	10 7/16 ¹¹		
Max. Motor Size (HP)	25	 	
Budget estimate for 3 pumps	TBD	and the second s	
Delivery time (weeks)	TBD	<u></u>	

*Attach copy of system curve plotted on manufacturer's pump curve. Spreadsheet curves not allowed.

Approval of these pumps for use on this project:

Engineer of Record (EOR) Clint A Geci

ECUA Project Engineer ECUA Lift Station Staff

Revised Sep. 1, 2016

SPECIAL NOTE: ALL WETWELL PENETRATIONS TO BE GROUT FILLED & SEALED TO ECUA SPECIFICATIONS.

GENERAL LIFT STATION NOTES

- 1. THE LOCATION OF INFLUENT LINES, WATER SUPPLY, ETC. ARE DRAWN OUT OF ORIENTATION ON SECTIONAL VIEW FOR CLARITY. SEE PLAN VIEW FOR PROPER ORIENTATION.
- 2. ALL PENETRATIONS IN WET WELL WALL FOR PIPING, ELECTRICAL, ETC. SHALL BE SEALED & SLEEVED.
- 3. PIPING WITHIN THE WET WELL SHALL BE FLANGED SCHEDULE 10 316 STAINLESS STEEL. INTERMEDIATE JOINTS SHALL BE WELDED. FITTINGS WITHIN THE WET WELL SHALL BE J16 STAINLESS STEEL. ALL NUTS, BOLTS & ACCESSORIES WITHIN THE WET WELL SHALL BE J16 STAINLESS STEEL.
- 4. INTERIOR SURFACES, INCLUDING THE PUMP IMPELLER, VOLUTE, AND BACKPLATE SHALL BE COATED WITH BELZONA 1321 CERAMIC S-METAL. (UNLESS OTHERWISE SPECIFIED BY OWNER)
- 5. CONTRACTOR SHALL PROVIDE 2-3/4" CONDUITS (ONE FOR POWER AND ONE FOR SIGNAL) FOR FLOW METER (IF REQUIRED). CONTRACTOR SHALL TERMINATE WIRES IN OWNER PROVIDED ELECTRICAL CONTROL CABINET.
- 6. UNDERGROUND ELECTRICAL CONDUIT SHALL BE RIGID PER ELECTRICAL CODE. CONTRACTOR SHALL ACHIEVE THIS VIA THE USE OF METAL CONDUIT, OR PVC ENCASED IN
- CONCRETE, OR ALTERNATE METHOD AT THE ECUA'S APPROVAL TO MEET CODE. 7. FOR ALL SYSTEMS REQUIRING BRACES: PROVIDE MINIMUM OF THREE (3) 316 STAINLESS STEEL BRACES, EVENLY SPACED. ADD ADDITIONAL BRACES IF BRACE SPACING
- EXCEEDS 10'.
- 8. CONTRACTOR SHALL PROVIDE DESIGN PERFORMED BY FLORIDA LICENSED P.E. AND SHALL INCLUDE DESIGN IN DELEGATED ENGINEERING DOCUMENTS.

PROJECT NO. SHEET NO

PLESS LANDING
PANEL ENCLOSURE DETAILS

PROJECT NO. SHEET NO

