SITE CONSTRUCTION PLANS FOR

LEXLEE ESTATES

A 56 LOT RESIDENTIAL SUBDIVISION 6000 BLOCK BLUE ANGEL PARKWAY ESCAMBIA COUNTY, FLORIDA

RBA PROJECT NO.: 2020.140

SITE INFORMATION				
OWNER:	B & D HOLDINGS, LLC P.O. BOX 4817 PENSACOLA, FL 32507			
DEVELOPER:	B & D HOLDINGS, LLC P.O. BOX 4817 PENSACOLA, FL 32507			
PROPERTY REFERENCE NO:	38-1S-31-3403-000-000			
PROPERTY ADDRESS:	6000 BLOCK BLUE ANGEL PARKWAY			
PROPERTY AREA:	4.41 ACRES			
PROJECT AREA:	4.41 ACRES			
PROPERTY ZONING:	HDMU			
FUTURE LAND USE:	MU-U			
PROPOSED ACTIVITY:	SUBDIVISION			
REQUIRED BUILDING SETBACKS	FRONT: 20' REAR: 15' SIDES: 10'			


FEMA FLOOD INSURANCE RATE MAP INFORMATION						
THE PARCEL SHOWN FOR DEVELOPMENT IS LOCATED WITHIN THE FOLLOWING FLOOD ZONE(S) AS DETAILED BY FEMA FIRM (FLOOD INSURANCE RATE MAP) INFORMATION DESCRIBED BELOW:						
FLOOD ZONE(S) COMMUNITY No. MAP No. PANEL No. SUFFIX MAP REVISION DATE						
Х	120080	12033C	355	G	SEPT 29, 2006	

FLOOD ZONE:


THE SUBJECT PROPERTY AS SHOWN HEREON IS LOCATED IN ZONE 'X', AREAS DETERMINED TO BE OUTSIDE THE 0.2% ANNUAL CHANCE FLOODPLAIN BASED ON THE FEDERAL EMERGENCY MANAGEMENT AGENCY FLOOD INSURANCE RATE MAP FOR ESCAMBIA COUNTY, FLORIDA, COMMUNITY PANEL NUMBER 12033C0355G, EFFECTIVE DATE OF SEPTEMBER 29, 2006.

CONT	CONTACTS				
GULF POWER 5120 DOGWOOD DRIVE MILTON, FLORIDA 32570	CONTACT: CHAD SWAILS PHONE: 850.429.2446 FAX: 850.429.2432				
COX CABLE 3405 McLEMORE DR. PENSACOLA, FLORIDA 32514	CONTACT: TROY YOUNG PHONE: 850.857.4510 FAX: 850.475.0621				
ECUA 9255 STURDEVANT ST. PENSACOLA, FLORIDA 32514	CONTACT: TOMMY TAYLOR PHONE: 850.969.6516				
ENERGY SERVICES GAS 1625 ATWOOD DRIVE PENSACOLA, FLORIDA 32504	CONTACT: DIANE MOORE PHONE: 850.474.5319 FAX: 850.474.5331				
AT&T, INC. 605 W. GARDEN STREET PENSACOLA, FLORIDA 32501	CONTACT: JONATHAN BLANKINCHIP PHONE: 850.436.1489				
ESCAMBIA COUNTY PUBLIC WORKS 3363 WEST PARK PLACE PENSACOLA, FLORIDA 32501	CONTACT: MRS. JOHNNY PETTIGREW PHONE: 850.595.3404				
MCI	PHONE: 800.624.9675				
SUNSHINE UTILITIES	PHONE: 800.432.4770				

November 15, 2021

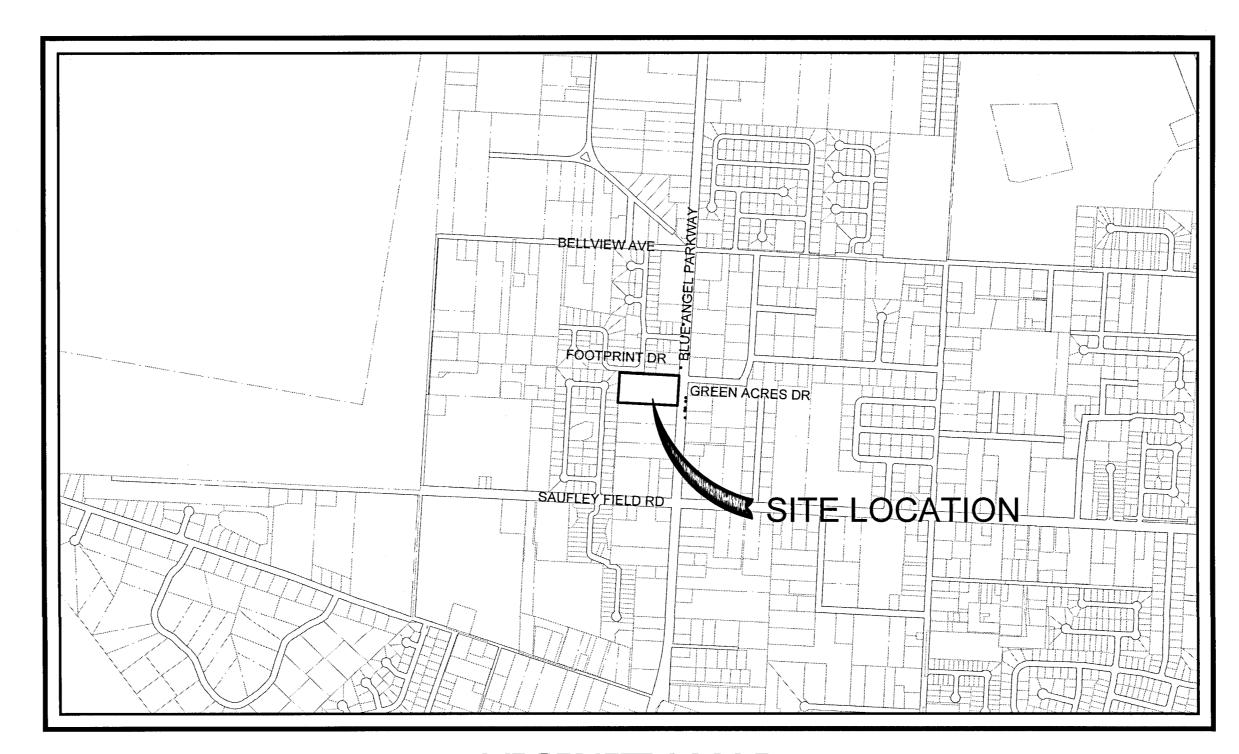

VICINITY MAP SCALE: 1" = 1000'

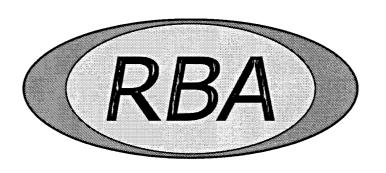

REBOL-BATTLE & ASSOCIATES

Civil Engineers and Surveyors

2301 N. Ninth Avenue, Suite 300 Pensacola, Florida 32503 Telephone 850.438.0400 Fax 850.438.0448 EB 00009657 LB7916

ECUA ENGINEERING MANUAL REFERENCE NOTE

DOCUMENT NAME	DOCUMENT TYPE		LOCATION	
	SPECIFICATION	DETAIL	PLANS	PROJECT MANUAL*
CUT-IN MANHOLE		Х	Х	

*PROJECT MANUALS USED ONLY WITH ECUA CIP PROJECTS

INDEX OF DRAWINGS

0	EXISTING SITE, DEMOLITION AND EROSION CONTROL PLA

EROSION CONTROL DETAILS

NPDES-STORMWATER POLLUTION PREVENTION PLAN

SITE LAYOUT AND DIMENSION PLAN

SITE DETAILS

GRADING AND DRAINAGE PLAN

GRADING AND DRAINAGE DETAILS

NEIGHBORHOOD GRADING AND DRAINAGE PLAN

UTILITY PLAN

PLAN & PROFILE C5.0~C5.4

CROSS SECTIONS C6.0~C6.2 C7.0~C7.7 FDOT 660 PLANS


requirements of applicable Escambia County Regulations and Ordinances and does not in any way relieve the submitting Architect, Engineer, Surveyor, or other signatory from responsibility of details as drawn.

DESCRIPTION: (AS PREPARED BY REBOL-BATTLE AND ASSOCIATES):

BEGIN AT THE SOUTHEAST CORNER OF BAREFOOT ESTATES, AS RECORDED IN PLAT BOOK 16 AT PAGE 62 OF THE PUBLIC RECORDS 100' PUBLIC RIGHT-OF-WAY); THENCE PROCEED NORTH 86'59'42" WEST ALONG THE SOUTH LINE OF AFOREMENTIONED BAREFOOT RIGHT-OF-WAY LINE OF BLUE ANGEL PARKWAY; THENCE PROCEED NORTH 03°35'54" EAST ALONG SAID WEST RIGHT-OF-WAY LINE FOR A DISTANCE OF 310.71 FEET TO THE POINT OF BEGINNING. LYING IN AND BEING A PORTION OF SECTION 38, TOWNSHIP 1 SOUTH, RANGE 31 WEST, ESCAMBIA COUNTY, FLORIDA AND CONTAINING 4.41 ACRES MORE OR LESS.



THE CONTRACTOR IS RESPONSIBLE FOR OBTAINING "RELEASED FOR CONSTRUCTION" DRAWINGS FROM REBOL-BATTLE & ASSOCIATES BEFORE BEGINNING CONSTRUCTION. REBOL-BATTLE & ASSOCIATES WILL NOT BE RESPONSIBLE FOR ANY CONSTRUCTION BASED ON PLANS THAT HAVE NOT BEEN RELEASED FOR CONSTRUCTION.

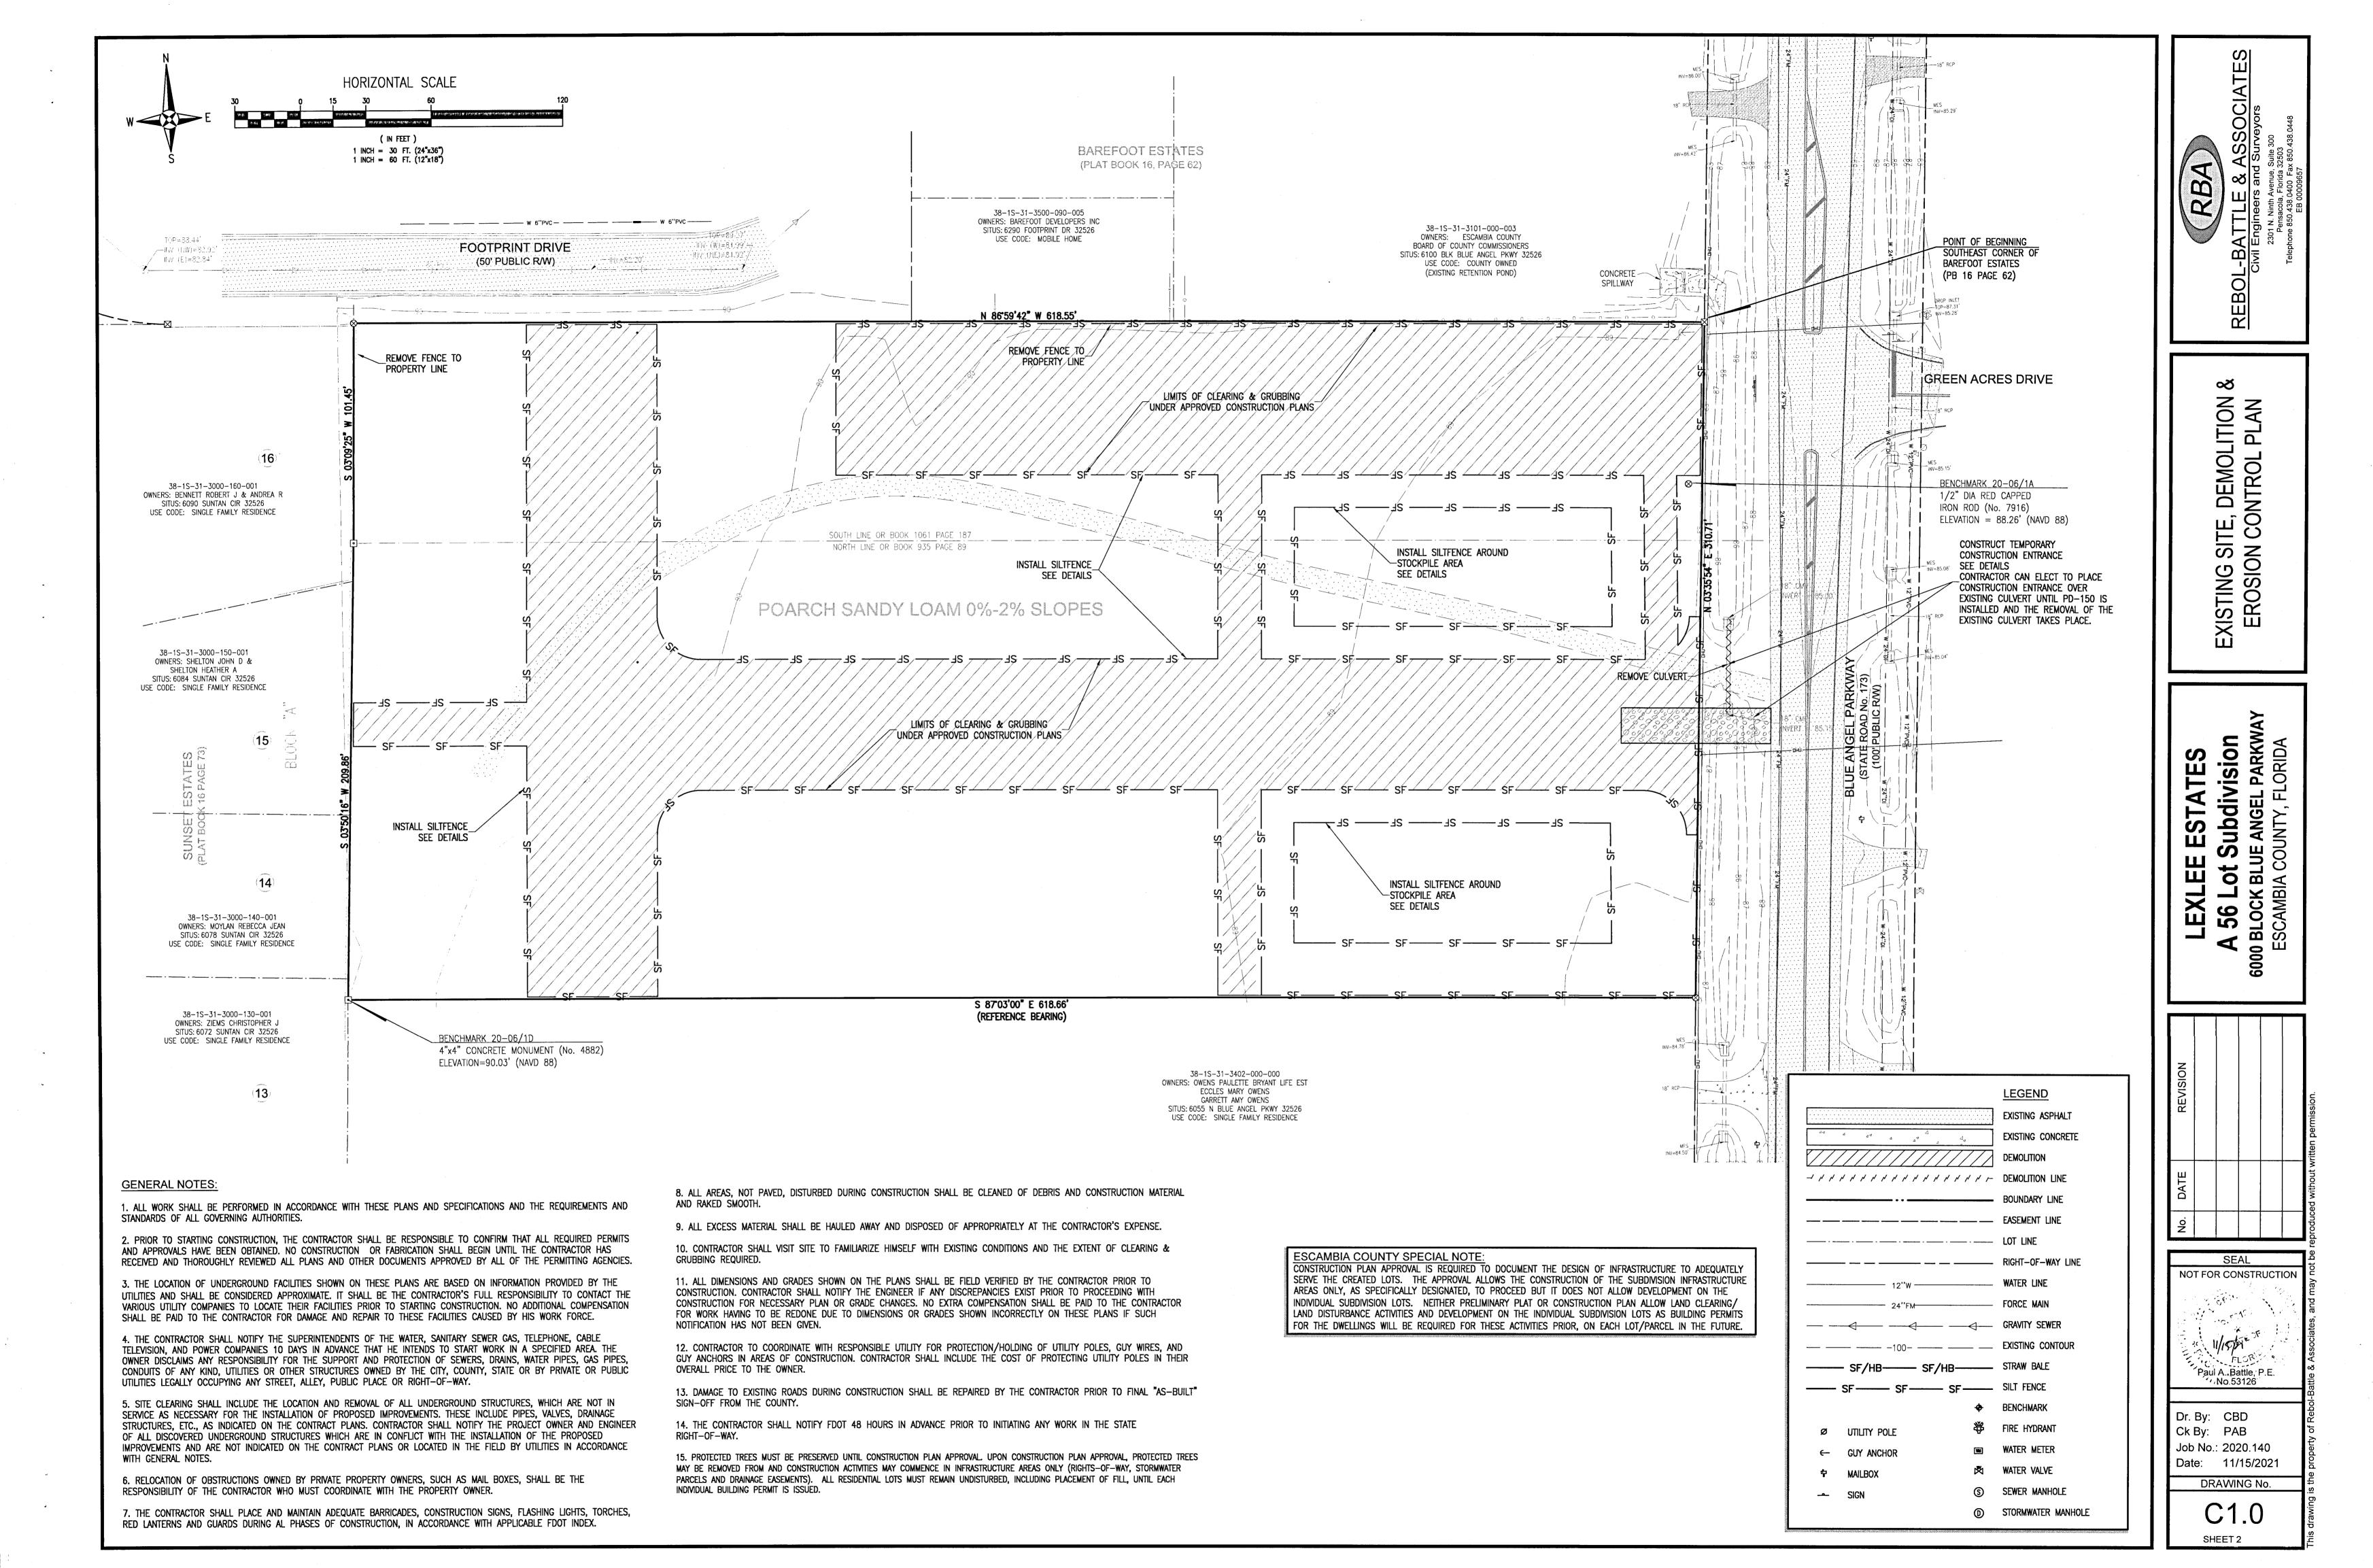

1. ALL EROSION AND SEDIMENT CONTROL PRACTICES TO BE INSTALLED PRIOR TO ANY MAJOR SOIL DISTURBANCE, OR IN THEIR PROPER SEQUENCE, AND MAINTAINED UNTIL PERMANENT PROTECTION IS

2. ANY DISTURBED AREAS THAT WILL BE LEFT EXPOSED MORE THAN 30 DAYS, AND NOT SUBJECT TO CONSTRUCTION TRAFFIC, WILL IMMEDIATELY RECEIVE A TEMPORARY SEEDING. IF THE SEASON PREVENTS THE ESTABLISHMENT OF A TEMPORARY COVER, THE DISTURBED AREAS WILL BE MULCHED WITH STRAW, OR EQUIVALENT MATERIAL, AT A RATE OF TWO (2) TONS PER ACRE, ACCORDING TO STATE STANDARDS.

3. PERMANENT VEGETATION TO BE SEEDED OR SODDED ON ALL EXPOSED AREAS WITHIN TEN (10) DAYS AFTER GRADING. MULCH TO BE USED AS NECESSARY FOR PROTECTION UNTIL SEEDING IS ESTABLISHED.

4. ALL WORK AND MATERIALS TO BE IN ACCORDANCE WITH THE FDOT "STANDARD SPECIFICATIONS FOR ROAD AND BRIDGE CONSTRUCTION", LATEST EDITION, SECTIONS 104, 570, 575 AND 980 TO 986.

*5. A BITUMINOUS CONCRETE BASE COURSE WILL BE APPLIED IMMEDIATELY FOLLOWING ROUGH GRADING AND INSTALLATION OF IMPROVEMENTS IN ORDER TO STABILIZE STREETS, ROADS, DRIVEWAYS AND PARKING AREAS. IN AREAS WHERE NO UTILITIES ARE PRESENT, THE BITUMINOUS CONCRETE BASE SHALL BE INSTALLED WITHIN 15 DAYS OF THE PRELIMINARY GRADING.

*6. IMMEDIATELY FOLLOWING INITIAL DISTURBANCE OR ROUGH GRADING, ALL CRITICAL AREAS SUBJECT TO EROSION (I.E. STEEP SLOPES AND ROADWAY EMBANKMENTS) WILL RECEIVE A TEMPORARY SEEDING IN COMBINATION WITH STRAW MULCH OR A SUITABLE EQUIVALENT, AT A THICKNESS OF TWO (2) TO FOUR (4) INCHES MIXED WITH THE TOP TWO (2) INCHES OF SOIL, ACCORDING TO STATE STANDARDS.

*7. ANY STEEP SLOPES RECEIVING PIPELINE INSTALLATION WILL BE BACKFILLED AND STABILIZED DAILY, AS THE INSTALLATION PROCEEDS (I.E. SLOPES GREATER THAN 3:1).

*8. A CRUSHED LIMEROCK, VEHICLE WHEEL-CLEANING BLANKET SHALL BE INSTALLED AT THE CONTRACTOR'S STAGING YARD AND/OR STOCKPILE AREAS TO PREVENT OFF-SITE TRACKING OF SEDIMENT BY CONSTRUCTION VEHICLES ONTO PUBLIC ROADS. BLANKET SHALL BE 15FT. X 50FT. X 6IN. (MINIMUM), CRUSHED LIMEROCK 2

1/2 INCHES IN DIAMETER. SAID BLANKET SHALL BE UNDERLAIN WITH A FDOT CLASS 3 SYNTHETIC FILTER FABRIC AND MAINTAINED IN GOOD ORDER. 9. AT THE TIME WHEN THE SITE PREPARATION FOR PERMANENT VEGETATIVE STABILIZATION IS GOING TO BE

ACCOMPLISHED, ANY SOIL THAT WILL NOT PROVIDE A SUITABLE ENVIRONMENT TO SUPPORT ADEQUATE VEGETATIVE GROUND COVER, SHALL BE REMOVED OR TREATED IN SUCH A WAY THAT WILL PERMANENTLY ADJUST SUITABLE FOR VEGETATIVE GROUND COVER. IF THE REMOVAL OR TREATMENT OF THE SOIL WILL NOT PROVIDE SUITABLE CONDITIONS, NON-VEGETATIVE MEANS OF PERMANENT GROUND STABILIZATION WILL HAVE TO BE

*10. CONDUIT OUTLET PROTECTION MUST BE INSTALLED AT ALL REQUIRED OUTFALLS PRIOR TO THE DRAINAGE

SYSTEM BECOMING OPERATIONAL. 11. UNFILTERED DEWATERING IS NOT PERMITTED. THE CONTRACTOR SHALL TAKE ALL NECESSARY PRECAUTIONS

DURING ALL DEWATERING OPERATIONS TO MINIMIZE SEDIMENT TRANSFER. 12. SHOULD THE CONTROL OF DUST AT THE SITE BE NECESSARY, THE SITE WILL BE SPRINKLED UNTIL THE

SURFACE IS WET, TEMPORARY VEGETATION COVER SHALL BE ESTABLISHED OR MULCH SHALL BE APPLIED IN

ACCORDANCE WITH STATE STANDARDS FOR EROSION CONTROL. 13. ALL SOIL WASHED, DROPPED, SPILLED OR TRACKED OUTSIDE THE LIMIT OF DISTURBANCE OR ONTO PUBLIC

RIGHTS-OF-WAY WILL BE REMOVED IMMEDIATELY.

14. THE CONTRACTOR SHALL BE RESPONSIBLE FOR ANY EROSION OR SEDIMENTATION THAT MAY OCCUR BELOW STORMWATER OUTFALLS OR OFFSITE AS A RESULT OF CONSTRUCTION OF THE PROJECT.

15. ALL SOIL STOCKPILES ARE TO BE TEMPORARILY STABILIZED IN ACCORDANCE WITH SOIL EROSION AND SEDIMENT CONTROL NOTE NUMBER 2 (ABOVE).

16. THE SITE SHALL AT ALL TIMES BE GRADED AND MAINTAINED SUCH THAT ALL STORM WATER RUNOFF IS DIVERTED TO SOIL EROSION AND SEDIMENT CONTROL FACILITIES.

17. ALL SEDIMENTATION STRUCTURES SHALL BE INSPECTED AND MAINTAINED REGULARLY.

18. ALL CATCH BASIN INLETS SHALL BE PROTECTED WITH HAY BALES AS SHOWN ON DETAIL.

19. THE CONTRACTOR SHALL PREPARE A PLAN FOR THE PROPER DEWATERING AND DOWNSTREAM SILTATION PROTECTION OF EACH STREAM CROSSING PRIOR TO EXCAVATING THE STREAM BED. PLAN SHALL BE FORWARDED TO THE ENGINEER FOR APPROVAL. THE ENGINEER SHALL BE NOTIFIED FOR INSPECTION PRIOR TO EACH STREAM

20. ANY AREAS USED FOR THE CONTRACTOR'S STAGING, INCLUDING BUT NOT LIMITED TO, TEMPORARY STORAGE OF STOCKPILED MATERIALS (E.G. CRUSHED STONE, QUARRY PROCESS STONE, SELECT FILL, EXCAVATED MATERIALS, ETC.), SHALL BE ENTIRELY PROTECTED BY A SILT FENCE ALONG THE LOW ELEVATION SIDE TO CONTROL SEDIMENT RUNOFF.

21. SAG FILTERS IN CURB THROATS ARE NOT AN ALLOWABLE SEDIMENT CONTROL METHOD.

* WHERE APPLICABLE

TEMPORARY SEEDING DETAILS:

SEED BED PREPARATION:

CROSSING CONSTRUCTION.

SOIL TO BE THOROUGHLY PULVERIZED BY DISK-HARROWING AND BE LOOSE AND REASONABLY SMOOTH. APPLY FERTILIZER AT A RATE OF 260 LBS/ACRE OF 16-16-16 OR EQUIVALENT, APPLY DOLOMITIC LIMESTONE AT A RATE OF 800 TO 1000 LBS./ACRE TO PROVIDE A SOIL pH OF 5.5 TO 6.5, LIME & FERTILIZER TO BE WORKED INTO THE TOPSOIL TO A DEPTH OF 4". ADD SANDY LOAM TOPSOIL TO A MINIMUM OF TWO (2) INCHES WHERE

SEED MIXTURE

CONSISTING OF ANNUAL RYE (LOLIUM MULTIFLORUM) AT A RATE OF 174 LBS/ACRE.

PERMANENT SEEDING DETAILS:

SEED BED PREPARATION:

SOIL TO BE THOROUGHLY PULVERIZED BY DISK-HARROWING AND BE LOOSE AND REASONABLY SMOOTH. APPLY FERTILIZER AT A RATE OF 260 LBS/ACRE OF 16-16-16 OR EQUIVALENT, APPLY DOLOMITIC LIMESTONE AT A RATE OF 800 TO 1000 LBS./ACRE TO PROVIDE A SOIL pH OF 5.5 TO 6.5, LIME & FERTILIZER TO BE WORKED INTO THE TOPSOIL TO A DEPTH OF 4". ADD SANDY LOAM TOPSOIL TO A MINIMUM OF TWO (2) INCHES WHERE

SEED MIXTURE CONSISTING OF <u>PURITY</u> <u>GERMINATION</u> ARGENTINE BAHIA 260 LBS/AC. 95% 80% PENSACOLA BAHIA 260 LBS/AC. 95% 40%(MIN.)-80%(TOTAL)

SOD SHALL BE WELL ROOT MATTED CENTIPEDE OR BAHIA GRASS COMMERCIALLY CUT TO A MINIMUM DIMENSION OF 12" x 24" A MAXIMUM OF 72 HOURS PRIOR TO PLACEMENT, SOD SHALL BE LIVE, FRESH AND UNINJURED. REASONABLY FREE OF WEEDS AND OTHER GRASSES, WITH A HEAVY SOIL MAT ADHERING TO THE ROOT SYSTEM. SOD SHALL BE GROWN, CUT, AND SUPPLIED BY A STATE CERTIFIED GROWER.

TRAFFIC CONTROL STANDARDS:

1. CONSTRUCTION TRAFFIC SHALL BE RESTRICTED TO ONSITE ACCESS BY MEANS SO DESIGNATED BY THE ENGINEER, POLICE/SHERIFF DEPARTMENT, ESCAMBIA COUNTY HIGHWAY DEPARTMENT, AND/OR THE FLORIDA DEPARTMENT OF TRANSPORTATION. 2. TRAFFIC DURING WET WEATHER SHALL BE MINIMIZED AND APPROPRIATE ROADWAY AND SITE CLEAN-UP SHALL

BE PROVIDED BY THE CONTRACTOR AS SOON AS WEATHER CONDITIONS PERMIT. TREE PROTECTION: 1. DAMAGED TRUNKS OR EXPOSED ROOTS WILL BE PAINTED IMMEDIATELY WITH A GOOD GRADE OF "TREE

2. TREE LIMB REMOVAL, WHERE NECESSARY, WILL BE DONE FLUSH TO TRUNK OR MAIN BRANCH AND THAT AREA PAINTED IMMEDIATELY WITH A GOOD GRADE OF TREE PAINT.

DUST CONTROL

1. ALL AREAS OF CLEARING AND EMBANKMENT AS WELL AS CONSTRUCTION HAUL ROADS SHALL BE TREATED AND MAINTAINED IN SUCH A MANNER AS TO MINIMIZE ANY DUST GENERATION.

2. DISTURBED AREAS SHALL BE MAINTAINED IN A ROUGH GRADED CONDITION AND TEMPORARILY SEEDED AND/OR MULCHED UNTIL PROPER WEATHER CONDITIONS EXIST FOR THE ESTABLISHMENT OF PERMANENT VEGETATION COVER.

3. IN EVENT OF EMERGENCY CONDITIONS, TILLAGE WILL BE SATISFACTORY FREE BEFORE SOIL BLOWING STARTS.

4. CALCIUM CHLORIDE MAY BE APPLIED TO UNPAVED ROADWAY AREAS, ONLY, SUBJECT TO THE ENGINEER'S APPROVAL AND CONFORMANCE WITH FDOT STANDARD SPECIFICATIONS, SECTION 102-5, LATEST EDITION.

PROPOSED SEQUENCE OF CONSTRUCTION: 1. THE INSTALLATION OF ALL SEDIMENT AND EROSION CONTROL DEVICES THAT CAN BE PLACED PRIOR TO ANY

2. CLEAR AND REMOVE ALL EXISTING VEGETATION IN THOSE AREAS IN INFRASTRUCTURE AREAS ONLY AS NOTED IN HATCHED CLEARING & GRUBBING AREAS ON SHEET C1.0. ALL REMAINING VEGETATION IS TO BE PROPERLY PROTECTED AND IS TO REMAIN IN ITS NATURAL STATE. TOPSOIL IN AREAS TO BE DISTURBED IS TO BE STRIPPED TO A MINIMUM DEPTH OF SIX (6) INCHES AND STOCKPILED SEPARATELY FROM FROM OTHER

3. THE IMMEDIATE INSTALLATION OF ALL REMAINING SEDIMENT AND EROSION CONTROL DEVICES.

4. PERFORM ALL DEMOLITION WORK.

MAJOR SOIL DISTURBANCES.


5. CONSTRUCT ALL UNDERGROUND UTILITIES AND STORM DRAIN SYSTEMS.

6. CONSTRUCT ROADS (SUBGRADE, CURB & GUTTER, BASE, PAVEMENT, SIDEWALKS AND LANDSCAPING).

7. COMPLETE STORMWATER PONDS.


8. UPON THE COMPLETION OF THE CONSTRUCTION ACTIVITIES, PROVIDE RESTORATION, FINE GRADE REMAINDER OF SITE, RESPREAD STOCKPILED TOPSOIL AND STABILIZE WITH PERMANENT VEGETATIVE COVER AND

9. THE REMOVAL OF APPROPRIATE TEMPORARY SEDIMENT AND EROSION CONTROL DEVICES.

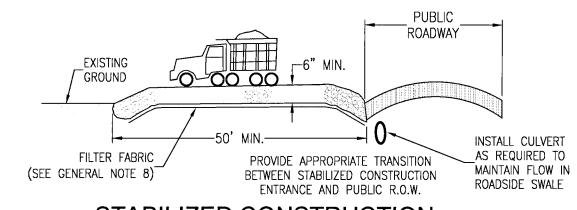

STABILIZED CONSTRUCTION **ENTRANCE DETAIL**

N.T.S.

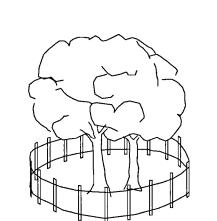

ALL PROTECTED TREES AS SHOWN ON THE PLANS TO REMAIN ARE TO BE PROTECTED DURING CONSTRUCTION. THE CONTRACTOR SHALL INSTALL ORANGE CONSTRUCTION FENCING AT THE DRIP LINE OF EACH PROTECTED TREE BEFORE WORKING IN THE VICINITY OF THE TREE.

TREE BARRICADE DETAIL N.T.S.


FILTER BAGS WILL BE USED AS AN EFFECTIVE FILTER MEDIUM TO CONTAIN SAND, SILT AND FINES WHEN TRENCH DEWATERING. THE WETLAND FILTER BAG CONTAINS THESE

WETLAND FILTER BAGS MAY REPLACE HAY BALE CORRALS DURING TRENCH DEWATERING. AT THE DISCRETION OF THE ENGINEER INSPECTOR. TO INSURE PROPER INSTALLATION, FILTER BAGS WILL BE PLACED ON RELATIVELY FLAT TERRAIN FREE OF BRUSH AND STUMPS TO AVOID RUPTURES AND PUNCTURES. PROPER INSTALLATION REQUIRES CUTTING A SMALL HOLE IN THE CORNER OF THE BAG, INSERTING THE PUMP DISCHARGE HOSE, AND THEN SECURING THE DISCHARGE HOSE TO THE BAG WITH A HOSE CLAMP. FILTER BAGS WILL BE PLACED AS FAR AWAY FROM FLOWING STREAMS AND WETLANDS AS POSSIBLE.


MATERIALS WHILE ALLOWING THE WATER TO FLOW THROUGH THE FABRIC.

PRIOR TO REMOVING A BAG FROM THE HOSE, THE BAG WILL BE TIED OFF BELOW THE END OF THE HOSE ALLOWING THE BAG TO DRAIN. DRAINAGE WILL NOT BE ALLOWED THROUGH THE INLET HOLE. TO AVOID RUPTURE, THE BAGS WILL BE ATTENDED AND PUMPING RATES MONITORED. ONCE THE BAG IS INFLATED TO A HEIGHT OF 4 FEET, PUMPING WILL STOP TO AVOID RUPTURE. FILTER BAGS USED DURING CONSTRUCTION WILL BE BUNDLED AND REMOVED FOR PROPER DISPOSAL.

FILTER BAGS ARE CONSTRUCTED OF NON-WOVEN GEOTEXTILE FABRIC. A MAXIMUM OF ONE SIX INCH DISCHARGE HOSE WILL BE ALLOWED PER FILTER BAG. BAG CAPACITY WILL BE EXCEEDED BEYOND 2.000 GALLONS PER MINUTE. TYPICAL BAG DIMENSIONS ARE 15 FEET BY 13.25 FEET. TO HELP PREVENT PUNCTURES, GEOTEXTILE FABRIC WILL BE PLACED BENEATH THE FILTER BAG WHEN USED IN WOODED LOCATIONS. UNATTENDED FILTER BAGS WILL BE ENCIRCLED WITH A HAY BALE OR SILT FENCE CORRAL, HOSE CLAMPS WILL BE USED TO SECURE THE DISCHARGE HOSE, WIRE OR STRING WILL NOT BE USED.

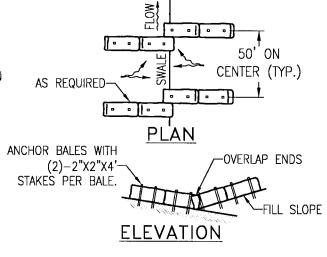


TO BE USED AT SELECTED SITES WHERE THE NATURAL GROUND SLOPES TOWARD THE TOE OF SLOPE

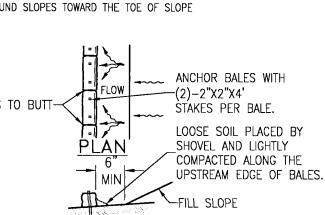


ELEVATION TO BE USED AT SELECTED SITES WHERE THE NATURAL


GROUND SLOPES AWAY FROM THE TOE OF SLOPE


BARRIERS FOR FILL SLOPES N.T.S.

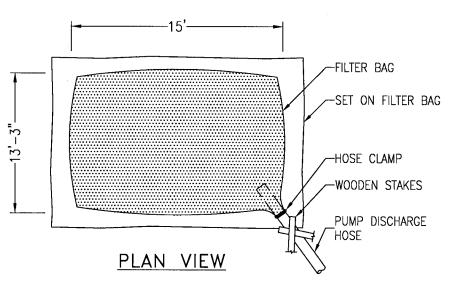

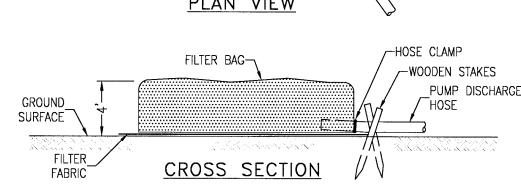

FILTER BAG DETAIL FOR TRENCH DEWATERING OPERATIONS

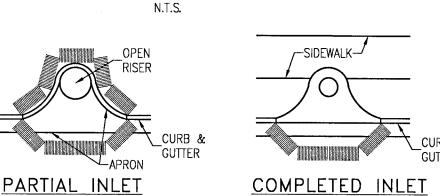

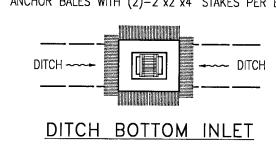

ANCHOR BALES WITH (2)-2"x2"x4' STAKES PER BALE.

2"x4" OR 3"ø TREATED

FIBERTEX (OR

APPROVED EQUAL).

MATERIAL ATTACHED

FILTERED RUNOFF-

WWWW

ANCHOR BALES WITH 2 - 2"X2"X4' STAKES PER BALE

ELEVATION

TYPE

<u>PLAN</u>

TYPE III SILT FENCE

WOVEN FILTER FABRIC IN ABSENCE OF

ESTABLISHED GRASS (APPROX. 12' X 12').

SECURE EDGES BY ENTRENCHING AND

EXTEND UNDER BAGS AND BALES. FABRIC

SHALL MEET THE REQUIREMENTS OF

SECTION 985 OF THE STANDARD

SPECIFICATIONS. COST OF FABRIC TO BE

INCLUDED IN THE CONTRACT UNIT PRICE

FOR BALED HAY OR STRAW, TN.

APPLICATION AND SPACING: THE USE OF TYPES I &

II BALE BARRIERS SHOULD BE LIMITED TO THE CONDITIONS

OUTLINED IN CHART I, SHEET 1 OF 3, INDEX NO. 102

BARRIER FOR UNPAVED DITCH

LOOSE SOIL PLACED BY

COMPACTED ALONG UPSTREAM

_1' MIN. RECOMMENDED

SHOVEL AND LIGHTLY

EDGE OF BALES.

LOOSE SOIL PLACED BY SHOVEL

-AND LIGHTLY COMPACTED ALONG

RECOMMENDED

THE UPSTREAM EDGE OF BALES.

TYPE III SILT FENCE

SILT FENCE APPLICATIONS

DO NOT DEPLOY IN A MANNER THAT SILT FENCES WILL ACT AS A DAM ACROSS

PERMANENT FLOWING WATERCOURSES. SILT FENCES ARE TO BE USED AT UPLAND

LOCATIONS AND TURBIDITY BARRIERS USED AT PERMANENT BODIES OF WATER.

AROUND DITCH BOTTOM INLETS.

BALES TO BE STAKED AT THE

DIRECTION OF THE ENGINEER.

LOOSE SOIL PLACED BY SHOVEL AND LIGHTLY COMPACTED ALONG UPSTREAM FACE OF BALES.

5' MIN.

<u>PLAN</u>

ANCHOR LOWER BALES WITH 2 - 2"X2"X4' STAKES PER

BALE. ANCHOR TOP BALES TO LOWER BALES WITH 2 -

ELEVATION

TYPE II

ELEVATION

BALE BARRIERS FOR PAVED DITCHES SHOULD BE SPACED IN

ACCORDANCE WITH CHART I, SHEET 1 OF 3, INDEX NO. 102

BARRIER FOR PAVED DITCH

2"X2"X4' STAKES PER BALE.

ANCHOR BALES WITH

STAKES PER BALE.

(2)-2"X2"X4'-

STRAW BALES BACKED BY FENCE

TO WIRE FENCE

COMPACTED SOIL-

STRAW BALE DETAIL

LOOSE SOIL PLACED BY SHOVE AND LIGHTLY COMPACTED ALONG

1' MIN.

ANCHOR PINS

STOCKPILE OF

MATERIAL STOCKPILE DETAIL

ERODIBLE MATERIAL

No. 5 STEEL BARS TWO PER STRAW BALE

RECOMMENDED

THE UPSTREAM EDGE OF BALES.

SILT FENCE DETAIL

STAKED &

-ENTRENCHED

STRAW BALE

COMPACTED SOIL TO

-SEDIMENT LADEN RUNOFF

PREVENT PIPING

TOE OF FABRIC

-TIMBER POST @ 6' O.C.

-TOE OF FABRIC

PROTECTION AROUND INLETS OR SIMILAR STRUCTURES

t Subd .ot $\overline{\mathbf{\Omega}}$ LEX \ 56 A 5 0 BL(ESC, 0

Sion

NOT FOR CONSTRUCTION Paul A. Battle, P.E. No.53126

Dr. By: CBD Ck By: PAB Job No.: 2020.140 Date: 11/15/202

DRAWING No.

SHEET 3

RE CONTROL AILS

ROSION (

1.1 INTRODUCTION:

THE REFERENCED SUPPORT DOCUMENTATION FOR THIS STORM WATER POLLUTION PREVENTION PLAN (SWPPP) IS THE UNITED STATES ENVIRONMENTAL PROTECTION AGENCY'S (EPA) STORM WATER MANAGEMENT FOR CONSTRUCTION ACTIVITIES, DEVELOPING POLLUTION PREVENTION PLANS AND BEST MANAGEMENT PRACTICES SUMMARY GUIDANCE (EPA 833-R-92-001) AND STORM WATER MANAGEMENT FOR CONSTRUCTION ACTIVITIES, DEVELOPING POLLUTION PREVENTION PLANS AND BEST MANAGEMENT PRACTICES (EPA 832-R-92-005). THIS SWPPP IS DESIGNED TO PROTECT ONSITE AND ADJACENT NATURAL RESOURCES, INCLUDING BUT NOT LIMITED TO, WETLANDS, MARSHES, BAYOUS AND BAYS, WHILE PRESERVING WILDLIFE AND ARCHEOLOGICAL RESOURCES.

AN ENVIRONMENTAL RESOURCE PERMIT APPLICATION WILL BE SUBMITTED NWFWMD AUGUST 2021

1.2 NOTICE OF INTENT (NOI):

RULE 62-621.300(4), FAC REQUIRES THE CONSTRUCTION OPERATOR OF A SITE THAT DISTURBS ONE OR MORE ACRES TO OBTAIN COVERAGE FROM THE GENERIC PERMIT FOR STORMWATER DISCHARGE FROM LARGE AND SMALL CONSTRUCTION ACTIVITIES. THE CONTRACTOR IS REQUIRED TO SUBMIT A NOTICE OF INTENT TO USE GENERIC PERMIT FOR STORMWATER DISCHARGE FROM LARGE AND SMALL CONSTRUCTION ACTIVITIES (FDEP FORM 62-621.300(4)(B)) ALONG WITH THE APPROPRIATE APPLICATION FEE TO THE FOLLOWING ADDRESS 48 HOURS PRIOR TO COMMENCING CONSTRUCTION:

NPDES STORMWATER NOTICES CENTER, MS # 2510 FLORIDA DEPARTMENT OF ENVIRONMENTAL PROTECTION 2600 BLAIR STONE ROAD TALLAHASSEE, FLORIDA 32399-2400

THIS FORM CAN BE OBTAINED FROM FDEP'S WEBSITE (WWW.DEP.STATE.FL.US) OR BY CONTACTING FDEP. PLEASE NOTE THAT THE CURRENT APPLICATION FEE IS \$300; HOWEVER, THIS FEE IS SUBJECT TO CHANGE WITHOUT NOTICE. ALWAYS REFER TO THE MOST CURRENT VERSION OF RULE 62-4.050(4)(D), FAC TO CONFIRM THE AMOUNT BEFORE SUBMITTING PAYMENT. IF CONSTRUCTION ACTIVITY EXCEEDS FIVE YEARS, THE CONTRACTOR MUST RE-APPLY FOR COVERAGE.

1.3 STORMWATER POLLUTION PREVENTION PLAN (SWPPP):

THE CONTRACTOR IS REQUIRED TO CERTIFY THIS STORMWATER POLLUTION PREVENTION PLAN (SWPPP) BELOW PRIOR TO SUBMITTING THE NOI. THIS SWPPP IS NOT REQUIRED TO BE SUBMITTED WITH THE NOI, BUT IS REQUIRED TO BE KEPT ON SITE DURING ALL PHASES OF CONSTRUCTION. BECAUSE EROSION AND SEDIMENT CONTROLS AND CONSTRUCTION METHODS VARY SIGNIFICANTLY FROM CONTRACTOR TO CONTRACTOR. THE CONTRACTOR CAN PROPOSE ALTERNATIVE METHODS TO THIS SWPPP THAT ARE EQUAL OR BETTER AT CONTROLLING EROSION AND SEDIMENTATION. AT A MINIMUM, THE CONTRACTOR MUST FOLLOW THE EROSION CONTROL PLAN SPECIFIED IN THE CONSTRUCTION PLANS AND DOCUMENTS. ANY MODIFICATIONS TO THIS SWPPP MUST BE DOCUMENTED AND KEPT WITH THE PLAN AS PART OF THE RECORDS KEEPING PROCESS TO BE IN FULL COMPLIANCE WITH THE CGP.

1.4 CONTRACTOR'S / SUBCONTRACTOR CERTIFICATION:

I CERTIFY UNDER PENALTY OF LAW THAT I UNDERSTAND, AND SHALL COMPLY WITH, THE TERMS AND CONDITIONS OF THE STATE OF FLORIDA GENERIC PERMIT FOR STORMWATER DISCHARGE FROM LARGE AND SMALL CONSTRUCTION ACTIVITIES AND THIS STROMWATER POLLUTION PREVENTION PLAN PREPARED THEREUNDER.

PRINT & SIGN NAME		COMPANY & ADDRES
NAME & TITLE (PRINT)	-	
SIGNATURE	DATE	

1.5 RESPONSIBLE AUTHORITY CERTIFICATION:

I CERTIFY UNDER PENALTY OF LAW THAT THIS DOCUMENT AND ALL ATTACHMENTS WERE PREPARED UNDER MY DIRECTION OR SUPERVISION IN ACCORDANCE WITH A SYSTEM DESIGNED TO ASSURE THAT QUALIFIED PERSONNEL GATHERED AND EVALUATED THE INFORMATION SUBMITTED BASED ON MY INQUIRY OF THE PERSON OR PERSONS WHO MANAGE THE SYSTEM, OR THOSE PERSONS DIRECTLY RESPONSIBLE FOR GATHERING THE INFORMATION, THE INFORMATION SUBMITTED IS, TO THE BEST OF MY KNOWLEDGE AND BELIEF, TRUE, ACCURATE, AND COMPLETE. I AM AWARE THAT THERE ARE SIGNIFICANT PENALTIES FOR SUBMITTING FALSE INFORMATION, INCLUDING THE POSSIBILITY OF FINE AND IMPRISONMENT FOR KNOWING VIOLATIONS.

PRINT & SIGN NAME	COMPANY & ADDRESS
NAME & TITLE (PRINT)	

SIGNATURE DATE

1.6 NOTICE OF TERMINATION (NOT):

THE CONTRACTOR IS REQUIRED TO SUBMIT A NOTICE OF TERMINATION OF GENERIC PERMIT COVERAGE (FDEP FORM 62-621.300(6)) UPON CONSTRUCTION COMPLETION TO DISCONTINUE PERMIT COVERAGE. THE NOT IS TO BE SUBMITTED TO THE FOLLOWING ADDRESS:

NPDES STORMWATER NOTICES CENTER, MS # 2510 FLORIDA DEPARTMENT OF ENVIRONMENTAL PROTECTION 2600 BLAIR STONE ROAD TALLAHASSEE, FLORIDA 32399-2400

THIS FORM CAN BE OBTAINED FROM FDEP'S WEBSITE (WWW.DEP.STATE.FL.US) OR BY CONTACTING FDEP. THE NOT CAN NOT BE SUBMITTED UNTIL ALL DISTURBED SOILS AT THE CONSTRUCTION SITE HAVE BEEN FINALLY STABILIZED AND TEMPORARY EROSION AND SEDIMENT CONTROL MEASURES HAVE BEEN REMOVED OR WILL BE REMOVED AT AN APPROPRIATE TIME. FINAL STABILIZATION MEANS THAT ALL SOIL DISTURBING ACTIVITIES AT THE SITE HAVE BEEN COMPLETED AND THAT A UNIFORM PERENNIAL VEGETATIVE COVER WITH A DENSITY OF 70 PERCENT OF THE COVER FOR UNPAVED AREAS AND AREAS NOT COVERED BY PERMANENT STRUCTURES HAS BEEN ESTABLISHED, OR EQUIVALENT STABILIZATION MEASURES HAVE BEEN EMPLOYED. IF CONSTRUCTION ACTIVITY EXCEEDS FIVE YEARS, THE CONTRACTOR MUST RE-APPLY FOR COVERAGE.

N 30.464833°

1.7 APPLICATION INFORMATION:

PROJECT ADDRESS:	6000 BLOCK OF BLUE ANGEL PKWY PENSACOLA, FL

LONGITUDE: W 87.324256° WATER MANAGEMENT DISTRICT: NORTHWEST FLORIDA (NWFWMD)

MS4 OPERATOR NAME: ESCAMBIA COUNTY PERDIDO BAY

RECEIVING WATER NAME:

2.0 SITE DESCRIPTION:

LATITUDE:

2.1 NATURE OF CONSTRUCTION ACTIVITIES:

THIS PROJECT INVOLVES THE CONSTRUCTION OF A 56 LOT RESIDENTIAL SUBDIVISION. CONSTRUCTION INCLUDES ROADWAYS, UTILITIES AND STORMWATER COLLECTION/MANAGEMENT SYSTEMS.

2.2 SEQUENCE OF MAJOR SOIL DISTURBING ACTIVITIES:

THE FOLLOWING SEQUENCE OF MAJOR ACTIVITIES SHALL BE FOLLOWED UNLESS THE CONTRACTOR CAN PROPOSE AN ALTERNATIVE THAT IS EQUAL TO OR BETTER AT CONTROLLING EROSION AND SEDIMENTATION. THE DETAILED SEQUENCE FOR THE ENTIRE PROJECT CAN VARY SIGNIFICANTLY FROM CONTRACTOR TO CONTRACTOR. THE CONTRACTOR IS RESPONSIBLE FOR DOCUMENTING ANY CHANGES.

1. CLEAR, GRUB (IN INFRASTRUCTURE AREAS ONLY AS NOTED ON C1.0) AND PERFORM ALL DEMOLITION WORK.

2. COMPLETE ROUGH GRADING OF THE POND AND DIRECT ALL STORMWATER RUNOFF TO THE

3. CONSTRUCT ALL UNDERGROUND UTILITIES AND STORM DRAIN SYSTEM.

4. CONSTRUCT ROADS (SUBGRADE, CURB & GUTTER, BASE, PAVEMENT, SIDEWALKS, AND LANDSCAPING).

5. COMPLETE STORMWATER PONDS.

2.3 AREA ESTIMATES:

ONSITE AREA:	4.42	ACRES
OFFSITE AREA:	0.32	ACRES
TOTAL AREA:	4.74	ACRES
AREA TO BE DISTURBED:	4.42	ACRES

2.4 RUNOFF DATA:

RUNOFF COEFFICIENTS (C):

		THASE
BEFORE:	COMPOSITE C =	0.20
DURING:	VARIES BETWEEN =	0.20 & 0.90
AFTER:	COMPOSITE C =	0.73

SOILS DATA: BENEATH UP TO 24" OF TOPSOIL, THE TEST BORINGS GENERALLY ENCOUNTERED MIXED STRATA OF FINE-GRAINED SANDS, SLIGHTLY SILTY SANDS, AND SILTY SANDS.

DRAINAGE AREAS FOR EACH OUTFALL:

OUTFALL LOCATION	TOTAL AREA FLOWING	TO POND	'C' COEFFICIENT
POND A	4.74 AC		0.73

PHASE 1

2.5 SITE MAP:

THE CONSTRUCTION PLANS ARE TO BE USED AS THE SITE MAPS. THE LOCATION OF THE REQUIRED INFORMATION IS DESCRIBED BELOW. THE SHEET NUMBERS FOR ALL THE ITEMS DISCUSSED BELOW ARE IDENTIFIED ON THE KEY SHEET OF THE CONSTRUCTION PLANS.

 DRAINAGE PATTERNS: ALL DRAINAGE PATTERNS ARE SHOWN ON THE GRADING & DRAINAGE PLANS.

 APPROXIMATE SLOPES: APPROXIMATE SLOPES ARE SHOWN ON THE GRADING & DRAINAGE POND SIDE SLOPES ARE SHOWN ON THE POND CROSS-SECTIONS.

 AREAS OF SOIL DISTURBANCE: ALL DEMOLITION IS SHOWN ON THE EXISTING SITE CONDITIONS AND DEMOLITION AND EROSION CONTROL PLAN SHEET. ALL PROPOSED CONSTRUCTION IS SHOWN ON THE REMAINING PLANS. ANY AREAS WHERE DEMOLITION WORK OR PERMANENT FEATURES ARE SHOWN ABOVE OR BELOW GROUND WILL BE

 AREAS NOT TO BE DISTURBED: ANY AREAS NOT SHOWING DEMOLITION WORK OR PERMANENT FEATURES ARE ASSUMED NOT TO BE DISTURBED. IT WILL BE THE CONTRACTOR'S RESPONSIBILITY TO INDICATE ON THE PLANS ANY OF THESE AREAS THAT DO GET DISTURBED AS WELL AS ANY AREAS USED FOR STAGING AND MATERIALS STORAGE.

• LOCATIONS OF CONTROLS: ALL PROPOSED TEMPORARY CONTROLS AND EXISTING PERMANENT CONTROLS ARE SHOWN ON THE EXISTING SITE. DEMOLITION AND EROSION CONTROL PLAN. ALL PROPOSED PERMANENT CONTROLS ARE SHOWN ON THE REMAINING PLANS. IT WILL BE THE CONTRACTOR'S RESPONSIBILITY TO INDICATE THE LOCATION OF ANY OTHER CONTROLS ON THE PLANS THAT ARE USED DURING CONSTRUCTION.

 PERMANENT STABILIZATION IS SHOWN ON THE PLANS. IT WILL BE THE CONTRACTOR'S RESPONSIBILITY TO INDICATE THE LOCATION ON THE PLANS OF ALL TEMPORARY STABILIZATION PRACTICES USED DURING CONSTRUCTION.

• SURFACE WATERS: N/A

• <u>DISCHARGE POINTS:</u> FDOT R/W

2.6 RECEIVING WATERS:

PERDIDO BAY

3.0 CONTROLS:

3.1 EROSION AND SEDIMENT CONTROLS:

ALL EROSION AND SEDIMENT CONTROLS SPECIFIED ON THE DEMOLITION AND EROSION CONTROL PLAN SHEETS, AND THE EROSION CONTROL DETAILS SHALL BE INSTALLED PRIOR TO ANY CONSTRUCTION OR DEMOLITION. SILT FENCING AND STAKED HAY BALES SHALL BE INSTALLED ALONG

TEMPORARY SEEDING AND MULCHING SHALL BE APPLIED AFTER 14-DAY INTERVALS OF CEASED DISTURBANCE ACTIVITIES THAT WILL EXCEED 20-DAY PERIODS. GRADED AREAS SHALL BE STABILIZED WITH PERMANENT SEEDING, MULCHING, AND FERTILIZING, OR SODDING WITHIN FIVE DAYS OF FINAL GRADING, LANDSCAPING, INCLUDING SODDING, SHALL BE INSTALLED BY AN EXPERIENCED LANDSCAPE CONTRACTOR. PROPOSED DISTURBED AREAS WILL NOT EXCEED 8 ACRES IN ANY DRAINAGE AREA.

3.2 STORMWATER MANAGEMENT:

PROPOSED STORMWATER MANAGEMENT FACILITIES FOR THIS SITE INCLUDE: TWO WET DETENTION PONDS AND A DRY RETENTION FACILITY.

THE PROPOSED STORMWATER MANAGEMENT FACILITIES MEET ALL STORMWATER TREATMENT REQUIREMENTS AND ALL RATE CONTROL REQUIREMENTS SET FORTH BY THE LOCAL AND STATE REGULATORY AGENCIES.

3.3 OTHER CONTROLS:

WASTE DISPOSAL: THE CONTRACTOR IS RESPONSIBLE FOR ALL WASTE DISPOSAL FROM THE SITE. THE CONTRACTOR SHALL EMPLOY WASTE DISPOSAL PRACTICES THAT MEET ALL LOCAL, STATE, AND FEDERAL GUIDELINES AND PREVENT DISCHARGE OF SOLID MATERIALS TO WATERS OF THE UNITED STATES. THE CONTRACTOR IS RESPONSIBLE FOR DOCUMENTING THIS PORTION OF THE SWPPP.

OFFSITE VEHICLE TRACKING: IF OFF SITE TRACKING OF SEDIMENTS BY CONSTRUCTION VEHICLES OCCURS, THE CONTRACTOR IS REQUIRED TO INSTALL A SOIL TRACKING PREVENTION DEVICE (STPD) AS PER FDOT STANDARD INDEX 106 AT ALL EXITS TO THE SITE WHERE SEDIMENT TRACKING IS OCCURRING. THE CONTRACTOR IS ALSO RESPONSIBLE FOR DOCUMENTING THIS PORTION OF THE SWPPP.

HAZARDOUS MATERIALS: ALL POLLUTANTS AND HAZARDOUS MATERIALS INCLUDING BUT NOT LIMITED TO FERTILIZERS, HERBICIDES, PESTICIDES, SOLVENTS, OILS AND OIL FILTERS, PETROLEUM PRODUCTS, PAINT, AND EQUIPMENT MAINTENANCE FLUIDS, SHALL BE STORED INDOORS OR UNDER COVER IN AREAS WITH SECONDARY CONTAINMENT. SECONDARY CONTAINMENT PREVENTS A SPILL FROM SPREADING ACROSS THE SITE AND INCLUDES DIKES, BERMS, CURBING, OR OTHER CONTAINMENT METHODS. HAZARDOUS MATERIAL STORAGE AREAS SHALL BE INSPECTED WEEKLY AND AFTER STORM EVENTS. STORAGE AREAS SHALL BE KEPT CLEAN, WELL ORGANIZED, AND EQUIPPED WITH AMPLE CLEANUP SUPPLIES/SPILL KITS AS APPROPRIATE FOR THE MATERIALS BEING STORED. MATERIAL SAFETY DATA SHEETS. MATERIAL INVENTORY. AND EMERGENCY CONTACT INFORMATION SHALL BE MAINTAINED ON-SITE. ALL PERSONNEL SHALL RECEIVE INSTRUCTION REGARDING PROPER PROCEDURES FOR HAZARDOUS MATERIAL HANDLING AND DISPOSAL HAZARDOUS MATERIALS SHALL NOT BE DISPOSED OF INTO ON-SITE DUMPSTERS: HAZARDOUS MATERIALS SHALL BE DISPOSED OF IN ACCORDANCE WITH FEDERAL, STATE, AND MUNICIPAL REGULATIONS. VEHICLES AND EQUIPMENT WILL BE MAINTAINED OFF-SITE. ALL VEHICLES AND EQUIPMENT INCLUDING SUBCONTRACTOR VEHICLES WILL BE CHECKED FOR LEAKING OIL AND FLUIDS. VEHICLES LEAKING FLUIDS WILL NOT BE ALLOWED ON-SITE. DRIP PANS SHALL BE PLACED UNDER ALL VEHICLES AND EQUIPMENT THAT ARE PARKED OVERNIGHT.

APPLICATION OF FERTILIZERS, HERBICIDES, AND PESTICIDES: FERTILIZERS, HERBICIDES, AND PESTICIDES SHALL BE DELIVERED TO THE SITE IN ORIGINAL. UNOPENED CONTAINERS BEARING MANUFACTURER'S CHEMICAL ANALYSIS, NAME, TRADE NAME, TRADEMARK, AND INDICATION OF CONFORMANCE TO STATE AND FEDERAL LAWS. FERTILIZERS, HERBICIDES, AND PESTICIDES SHALL BE IN APPLIED IN ACCORDANCE WITH THE MANUFACTURER'S SUGGESTED

5.0 INSPECTIONS:

QUALIFIED PERSONNEL SHALL INSPECT THE FOLLOWING ITEMS, BUT NOT LIMITED TO, AT LEAST ONCE EVERY SEVEN CALENDAR DAYS AND WITHIN 24 HOURS OF THE END OF A STORM THAT IS 0.25 INCHES OR GREATER. WHERE SITES HAVE BEEN FINALLY STABILIZED, INSPECTIONS SHALL BE CONDUCTED AT LEAST ONCE EVERY MONTH.

 POINTS OF DISCHARGE TO WATERS OF THE UNITED STATES. POINTS OF DISCHARGE TO MUNICIPAL SEPARATE STORM SEWER

DISTURBED AREAS OF THE SITE THAT HAVE NOT BEEN FINALLY

STABILIZED. AREAS USED FOR STORAGE OF MATERIALS THAT ARE EXPOSED TO PRECIPITATION.

 STRUCTURAL CONTROLS. • STORMWATER MANAGEMENT SYSTEMS.

LOCATIONS WHERE VEHICLES ENTER OR EXIT THE SITE.

6.0 NON-STORMWATER DISCHARGES:

THE CONTRACTOR SHALL BE RESPONSIBLE FOR REPORTING ANY HAZARDOUS SUBSTANCE SPILLS THAT MAY EQUAL OR EXCEED A REPORTABLE QUANTITY (RQ). REFER TO EPA'S LIST OF HAZARDOUS SUBSTANCES AND REPORTABLE QUANTITIES (EPA 40 CFR 302.4 & 117). V THIS LIST CAN BE OBTAINED FROM EPA'S WEBSITE (WWW.EPA.GO) OR BY CONTACTING EPA. IF AN RQ RELEASE DOES OCCUR THE CONTRACTOR SHALL PERFORM THE FOLLOWING PROCEDURES:

 NOTIFY THE NATIONAL RESPONSE CENTER IMMEDIATELY AT 800-424-8802.

 PROVIDE WRITTEN DESCRIPTION OF THE RELEASE WITHIN 14 DAYS PROVIDING DATES, CAUSE AND PREVENTION METHODS TO THE REGIONAL EPA OFFICE.

 MODIFY THE SWPPP AS NECESSARY TO ADDRESS ADDED PREVENTION METHODS.

7.0 IMPLEMENTATION CHECKLIST:

7.1 RECORDS:

THE CONTRACTOR SHALL MAINTAIN RECORDS OF CONSTRUCTION ACTIVITIES INCLUDING, BUT NOT LIMITED TO:

 DATES WHEN MAJOR GRADING ACTIVITIES OCCUR. DATES WHEN CONSTRUCTION ACTIVITIES TEMPORARILY CEASE ON A PORTION OF THE SITE. DATES WHEN CONSTRUCTION ACTIVITIES PERMANENTLY CEASE ON A

PORTION OF THE SITE. DATES WHEN STABILIZATION MEASURES ARE INITIATED ON THE SITE.

7.2 INSPECTION REPORTS:

THE CONTRACTOR SHALL PREPARE INSPECTION REPORTS SUMMARIZING THE FOLLOWING, BUT NOT LIMITED TO:

NAME OF INSPECTOR.

QUALIFICATIONS OF INSPECTOR.

MEASURES/AREAS INSPECTED.

 OBSERVED CONDITIONS. CHANGES NECESSARY TO THE SWPPP.

7.3 RELEASES OF REPORTABLE QUANTITIES OF OIL OR HAZARDOUS **MATERIALS:**

THE CONTRACTOR SHALL REPORT ANY RELEASES OF REPORTABLE QUANTITIES OF OIL OR HAZARDOUS MATERIALS IF THEY OCCUR AS PER THE MEASURES OUTLINED IN SECTION 6.0 OF THE SWPPP.

7.4 SWPPP MODIFICATION:

THE CONTRACTOR SHALL MODIFY THE SWPPP AS NECESSARY TO:

 COMPLY WITH MINIMUM PERMIT REQUIREMENTS WHEN NOTIFIED BY FDEP THAT THE PLAN DOES NOT COMPLY. ADDRESS ANY CHANGES IN DESIGN, CONSTRUCTION OPERATIONS OR MAINTENANCE, WHICH HAS AN EFFECT ON THE POTENTIAL FOR DISCHARGE OF POLLUTANTS.

 PREVENT REOCCURRENCE OF REPORTABLE QUANTITY RELEASES OF HAZARDOUS MATERIAL OR OIL.

8.0 TERMINATION CHECKLIST:

THE FOLLOWING ITEMS SHALL BE COMPLETE BEFORE SUBMITTING THE NOT:

 ALL SOIL DISTURBING ACTIVITIES ARE COMPLETE. TEMPORARY EROSION AND SEDIMENT CONTROL MEASURES HAVE BEEN REMOVED OR WILL BE REMOVED AT AN APPROPRIATE TIME ALL AREAS OF THE CONSTRUCTION SITE NOT OTHERWISE COVERED BY PERMANENT PAVEMENT OR STRUCTURE HAVE BEEN STABILIZED WITH UNIFORM PERENNIAL VEGETATIVE COVER WITH A DENSITY OF 70% OR EQUIVALENT MEASURES HAVE BEEN EMPLOYED.

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Ω_ - STORMWATER PREVENTION F UTION NPD!


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Dr. By: CBD Ck By: PAB Job No.: 2020.140 11/15/2021 Date:

SHEET 4

DRAWING No.



REBOL-BATTLE & ASSOCIANI Engineers and Surveyor 2301 N. Ninth Avenue, Suite 300 Pensacola, Florida 32503 Telephone 850.438.0400 Fax 850.438.0448 EB 00009657

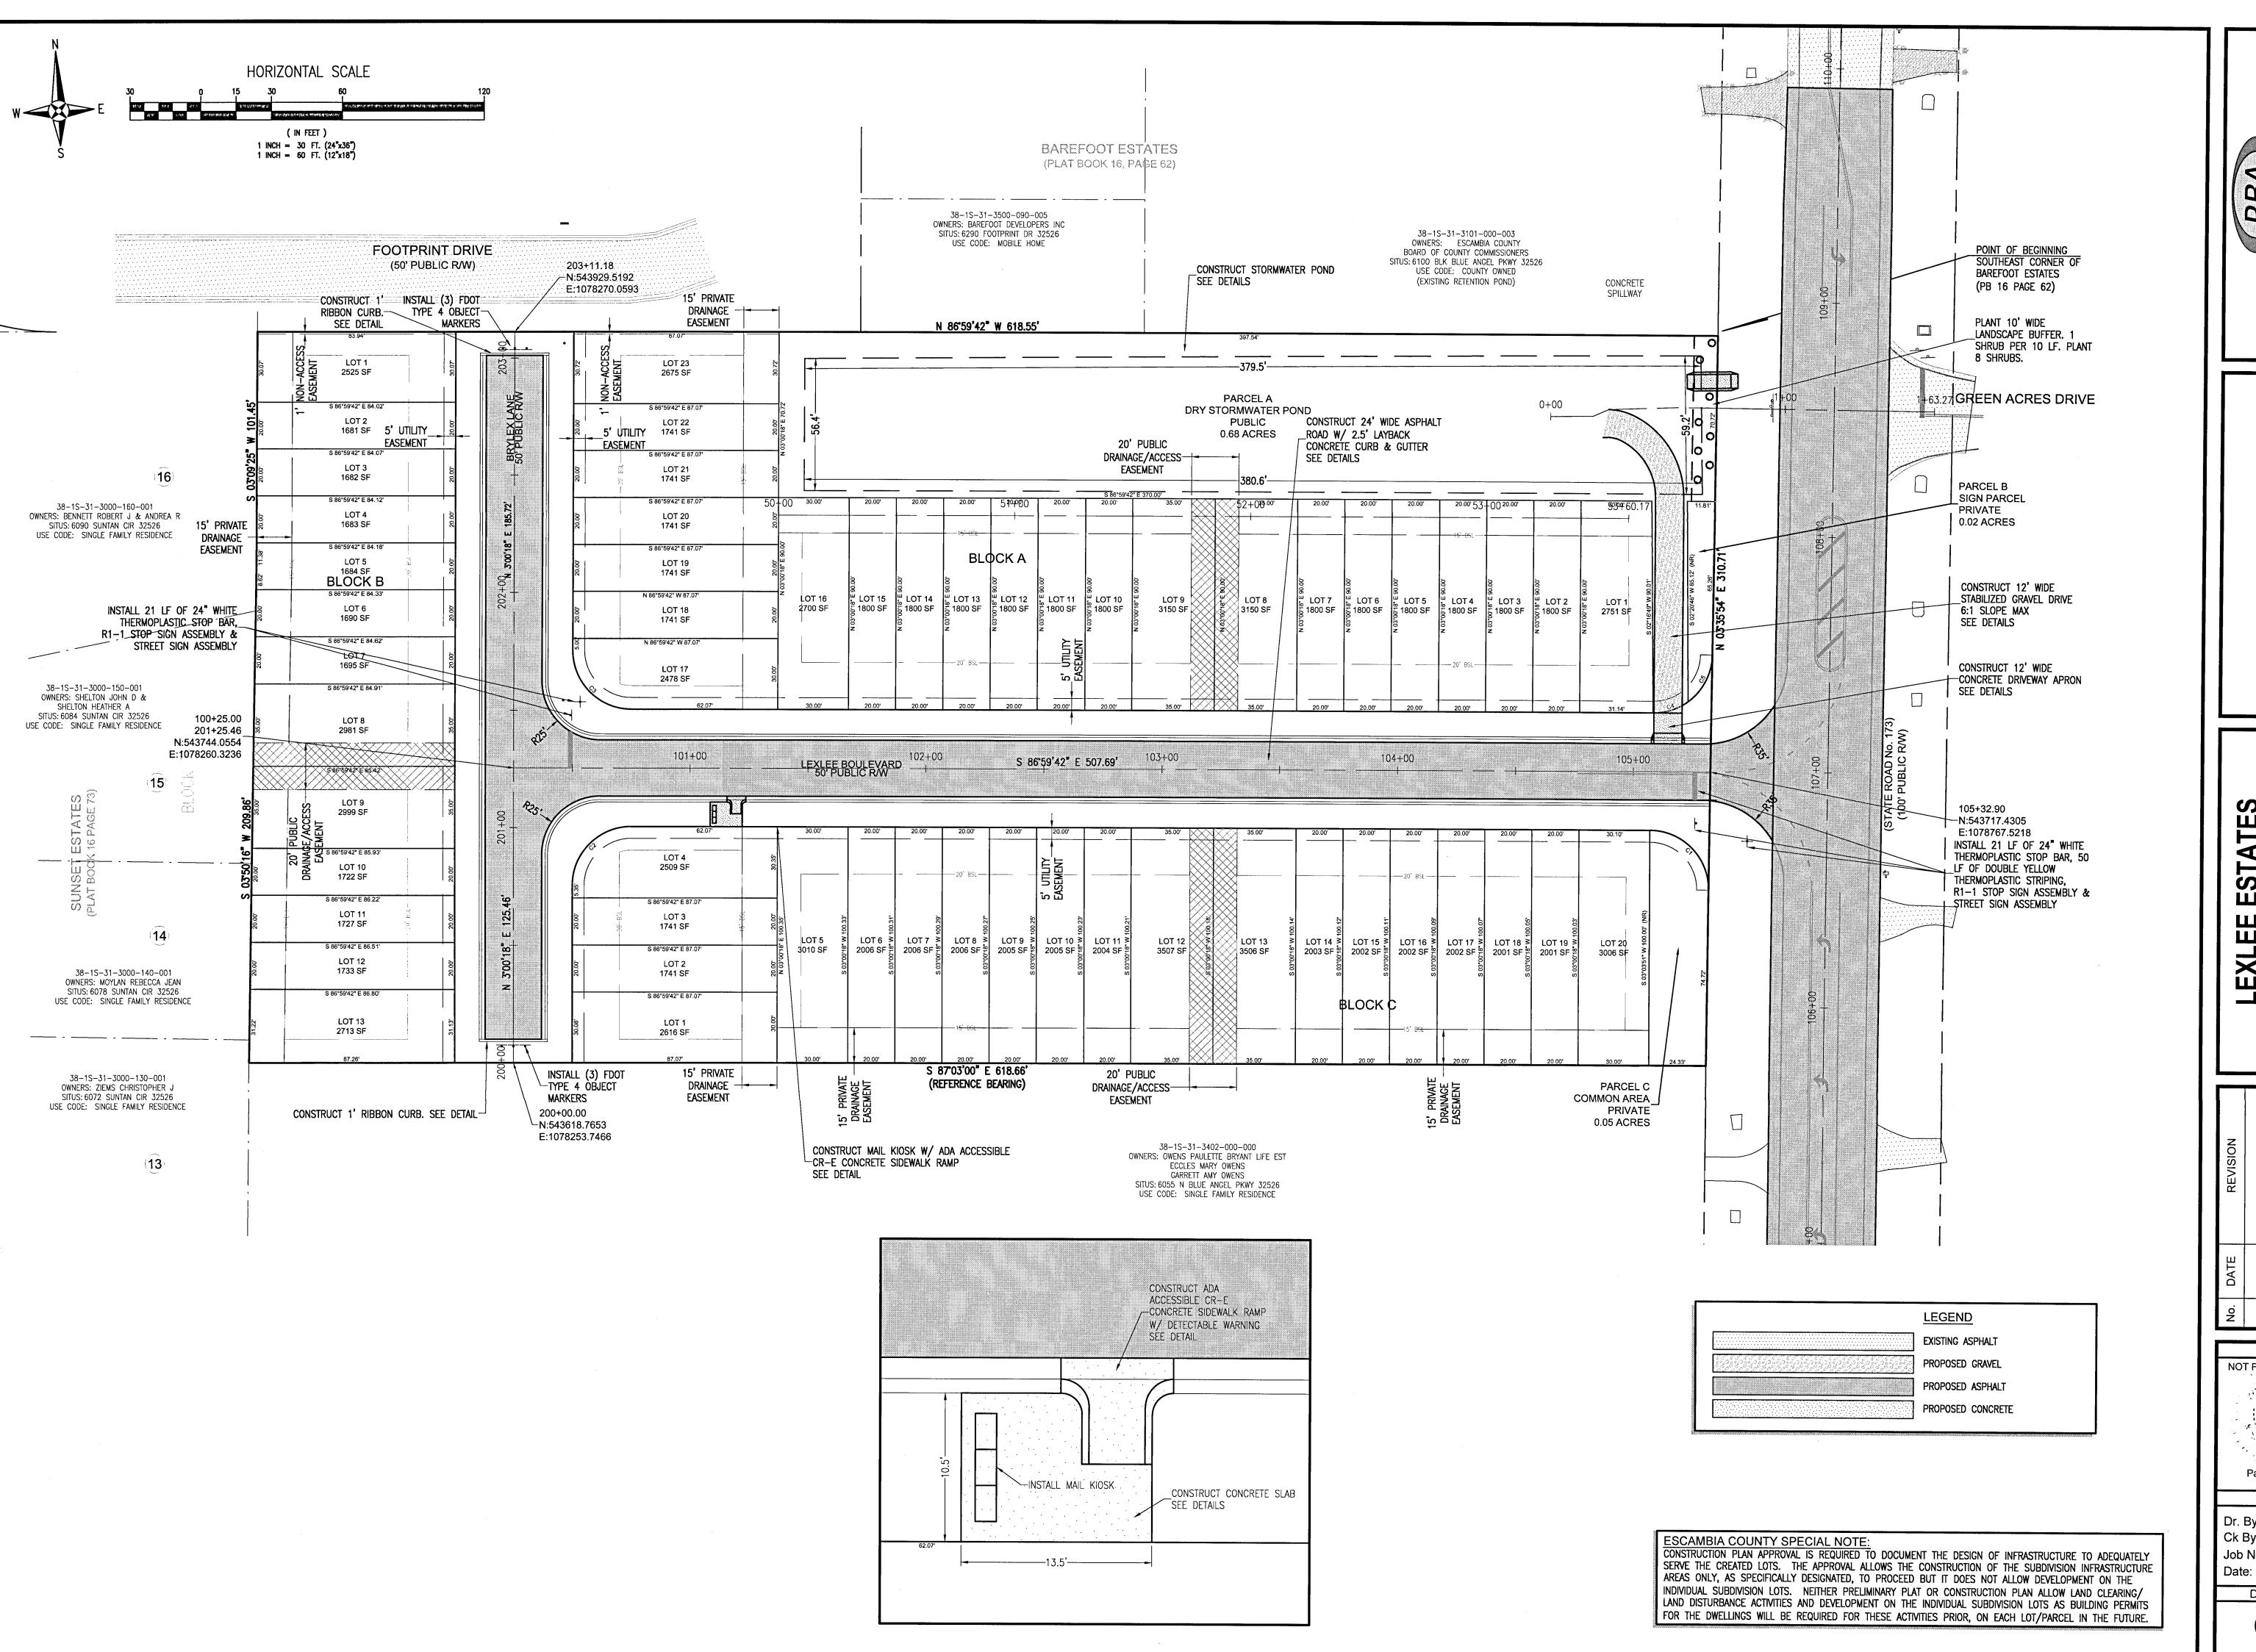SITE LAYOUT & DIMENSION PLAN

LEXLEE ESTATES
A 56 Lot Subdivision
6000 BLOCK BLUE ANGEL PARKWAY
ESCAMBIA COUNTY, FLORIDA

No. DATE REVISION

SEAL

NOT FOR CONSTRUCTION

Paul A. Battle, P.E.


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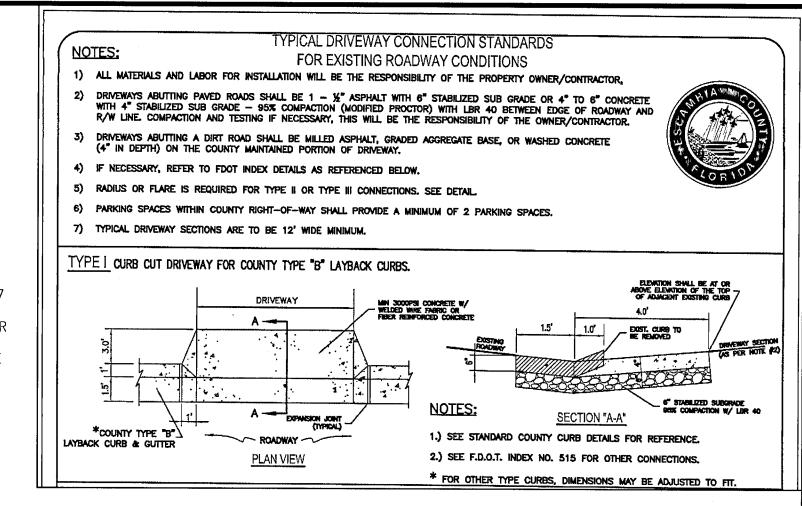
Dr. By: CBD Ck By: PAB Job No.: 2020.140


Date: 11/15/2021

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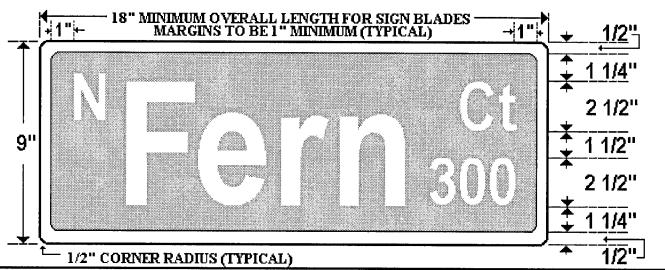
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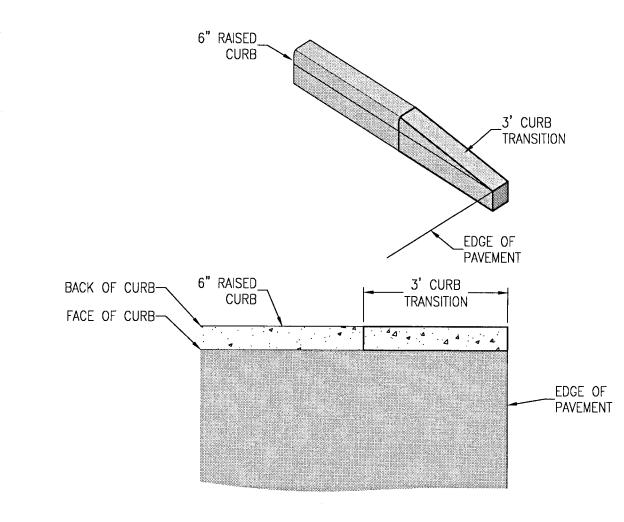


•F.D.O.T. TYPE III-A REFLECTIVE SHEETING TO BE USED ON ALL STREET NAME SIGN BLADES. STREET NAME SIGN BLADES TO HAVE WHITE LEGENDS. 1/2" WHITE BORDERS AND GREEN BACKGROUND. PRIMARY LETTERING TO SERIES B,6" UPPER CASE AND 4 1/2" LOWER CASE. •PREFIX AND SUFFIX LETTERING TO BE SERIES C, 2 1/2" UPPER CASE AND 1 3/4" LOWER CASE.

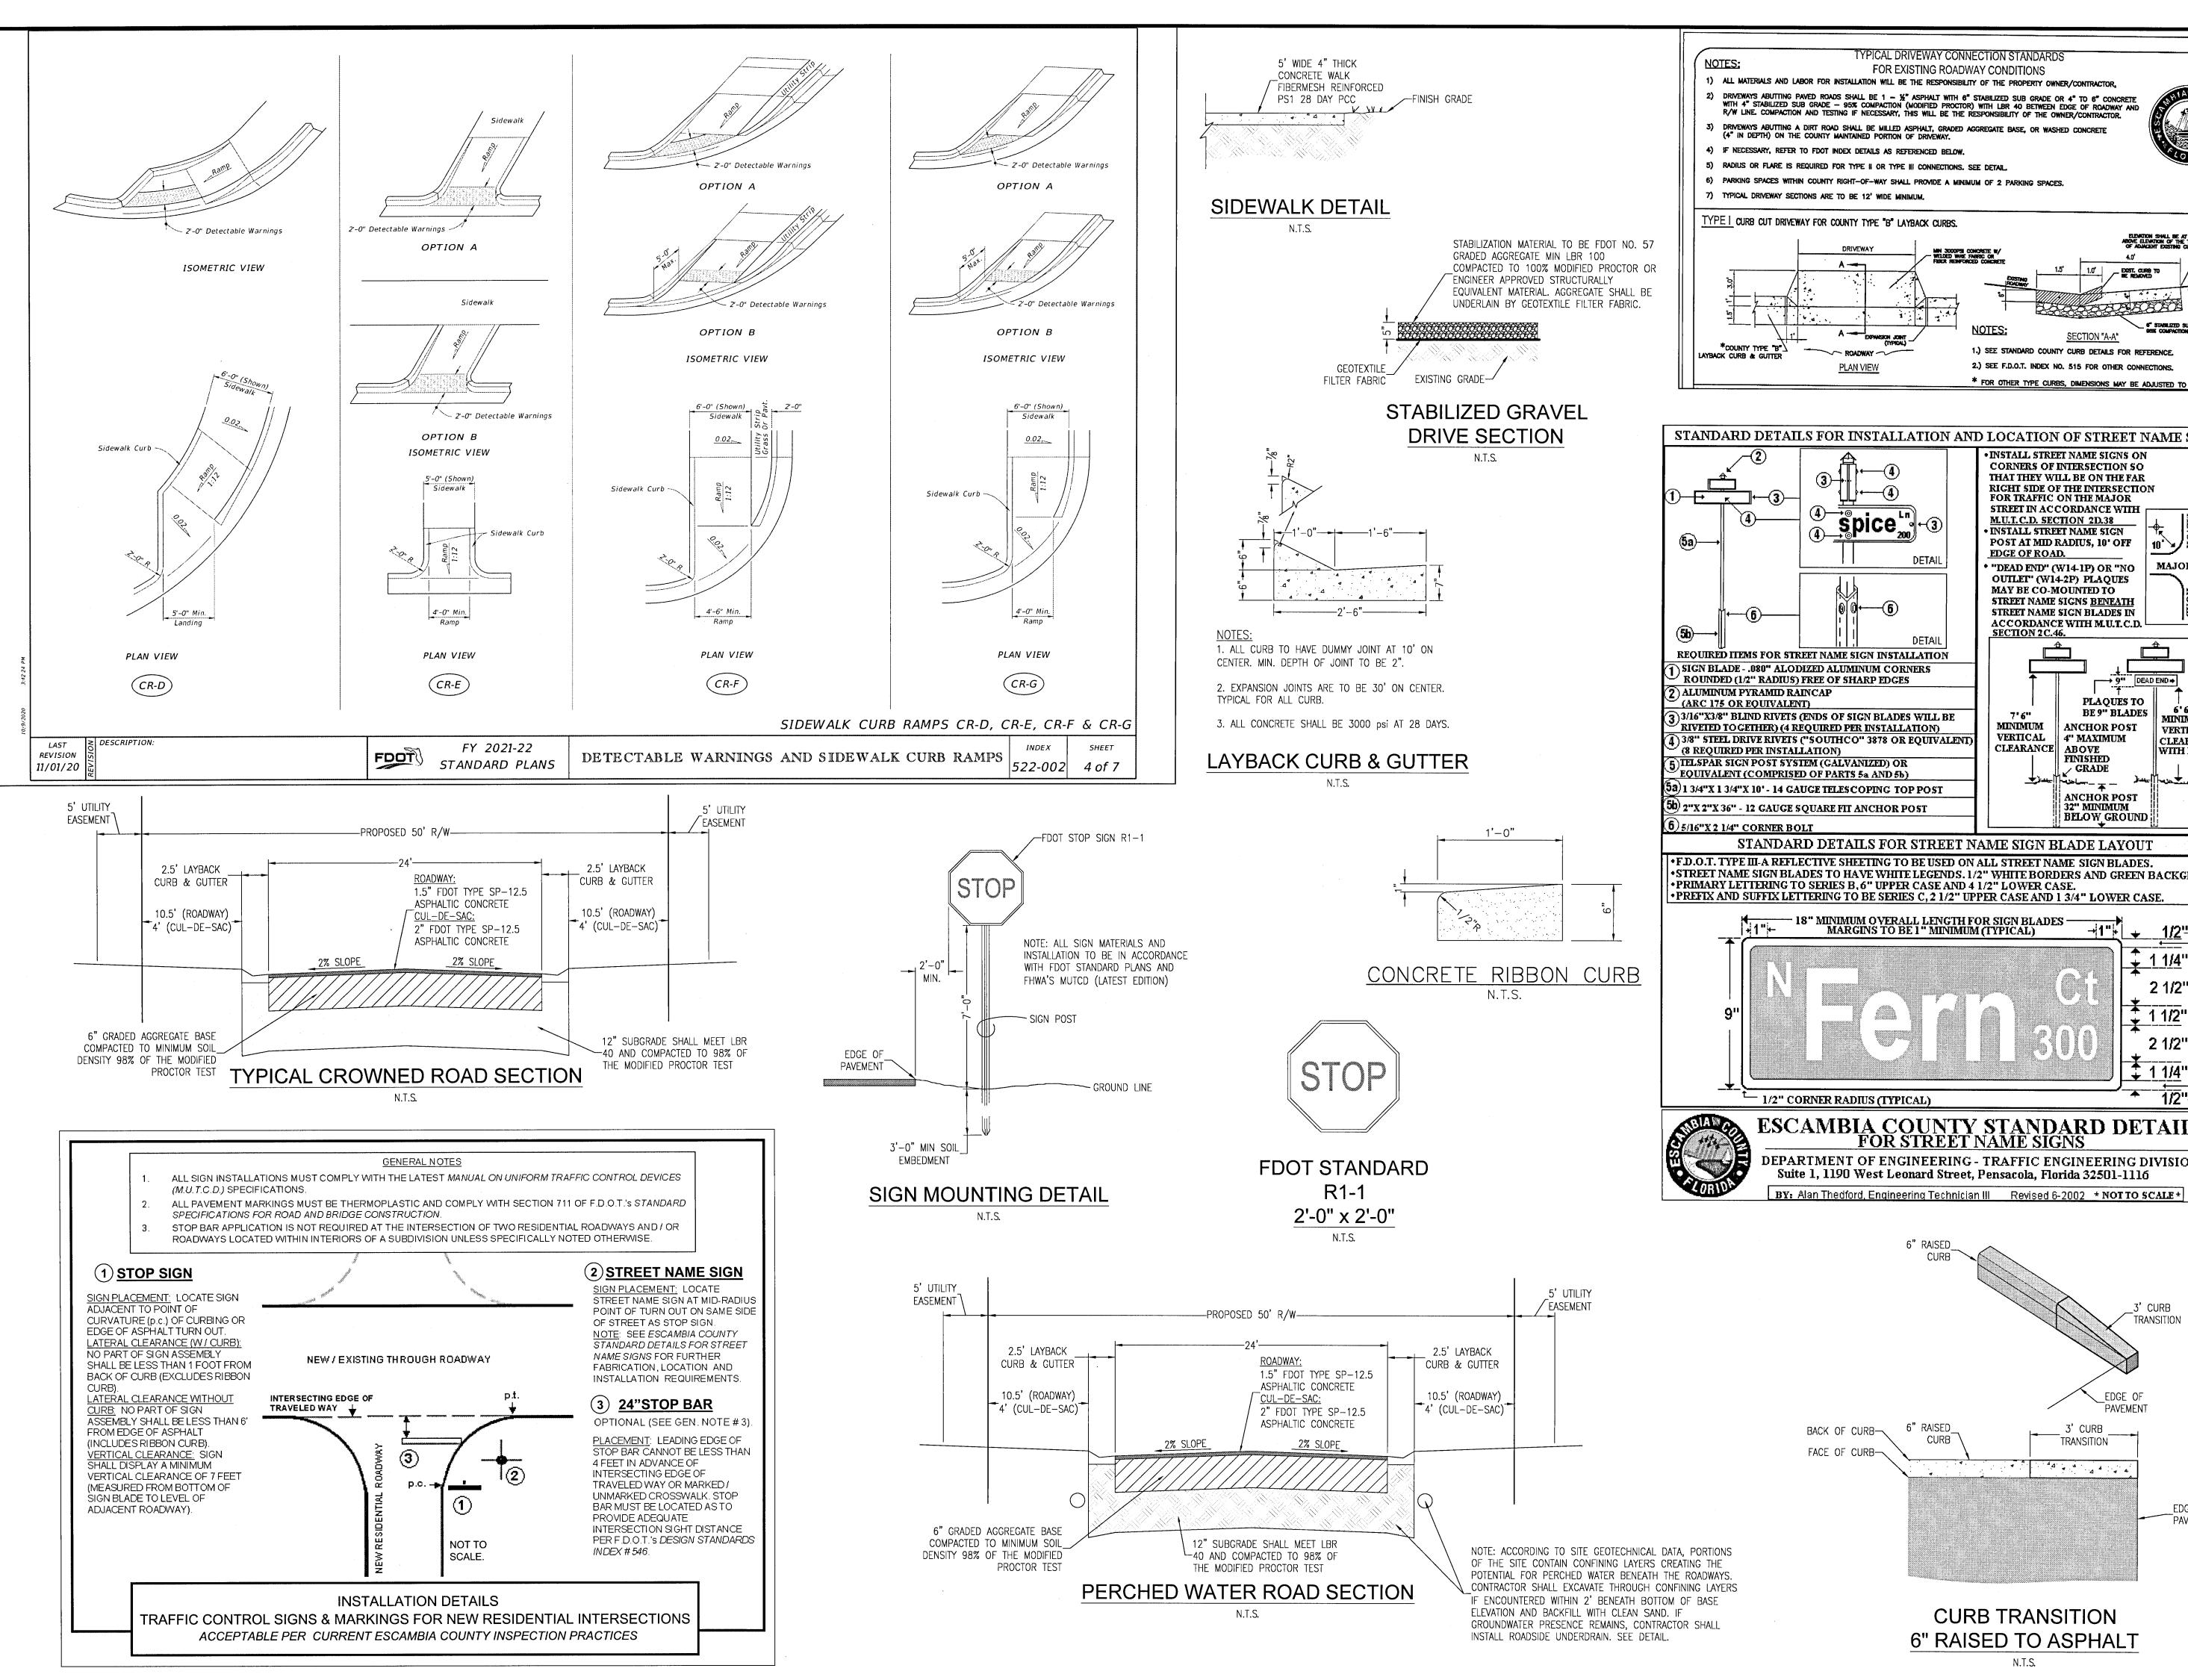

ESCAMBIA COUNTY STANDARD DETAILS FOR STREET NAME SIGNS

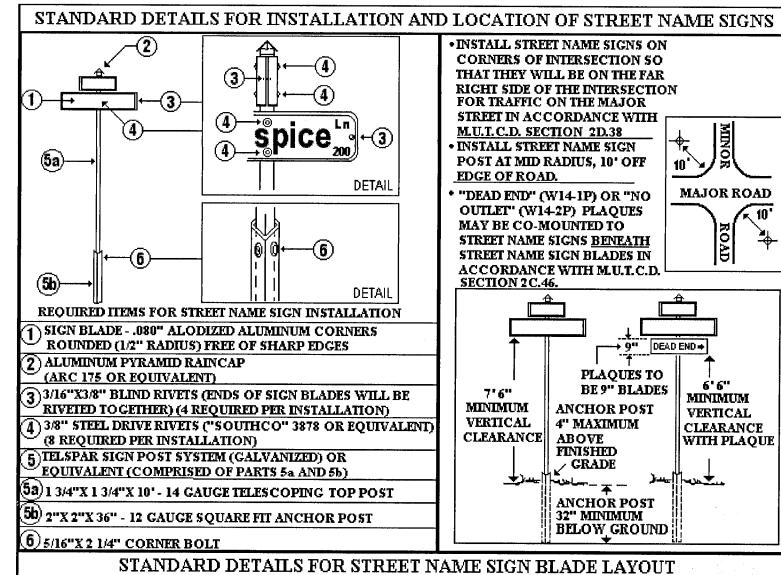DEPARTMENT OF ENGINEERING - TRAFFIC ENGINEERING DIVISION Suite 1, 1190 West Leonard Street, Pensacola, Florida 32501-1116



CURB TRANSITION 6" RAISED TO ASPHALT

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10 BLOCK

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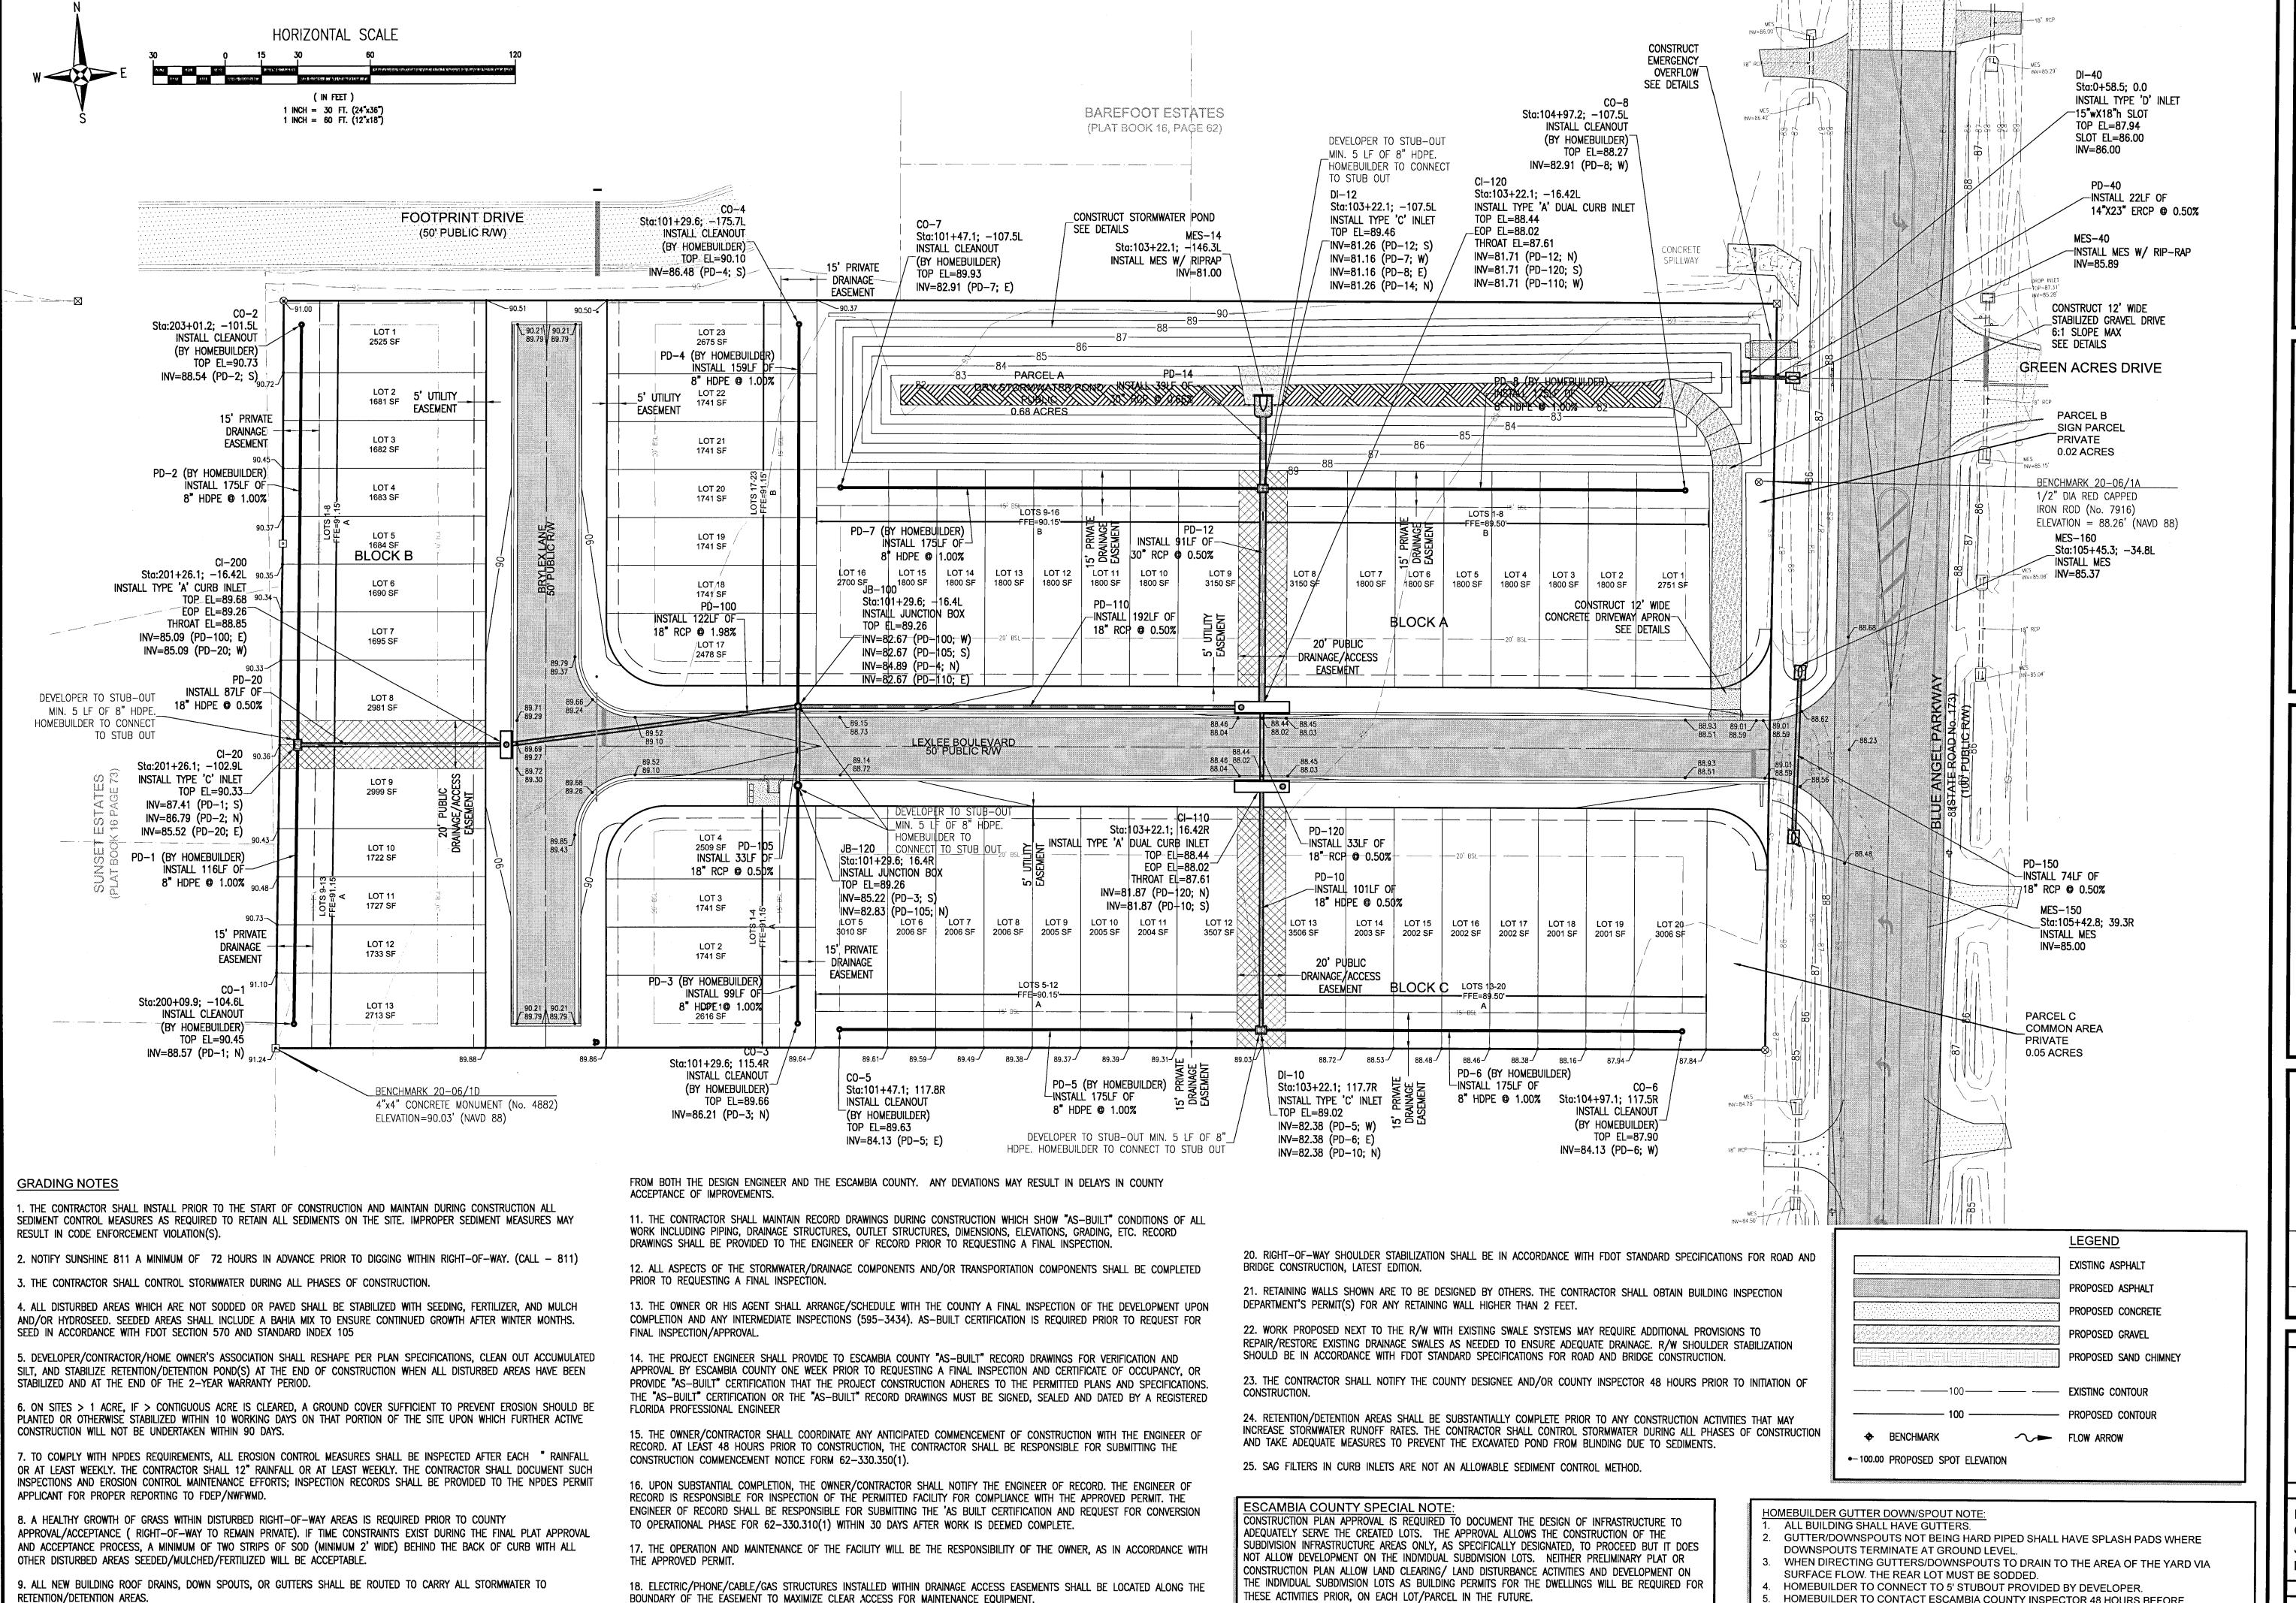
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SITE LAYOUT OF DIMENSION PLA

SEAL NOT FOR CONSTRUCTION 119.57.123 Paul A. Battle, P.E. No.53126

Dr. By: CBD Ck By: PAB Job No.: 2020.140 Date: 11/15/2021 DRAWING No.



BOUNDARY OF THE EASEMENT TO MAXIMIZE CLEAR ACCESS FOR MAINTENANCE EQUIPMENT.

19. MINIMUM ONE (1) FOOT GROUND COVER IS REQUIRED FOR ALL UNDERGROUND PIPES.

RETENTION/DETENTION AREAS.

10. NO DEVIATIONS OR REVISIONS FROM THESE PLANS BY THE CONTRACTOR SHALL BE ALLOWED WITHOUT PRIOR APPROVAL

OCIATE REBOL

GRADING & DRAINAGE PLAN

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NOT FOR CONSTRUCTION Paul A. Battle, P.E. No.53126 Dr. By: CBD

Ck By: PAB Job No.: 2020.140 Date: 11/15/2021

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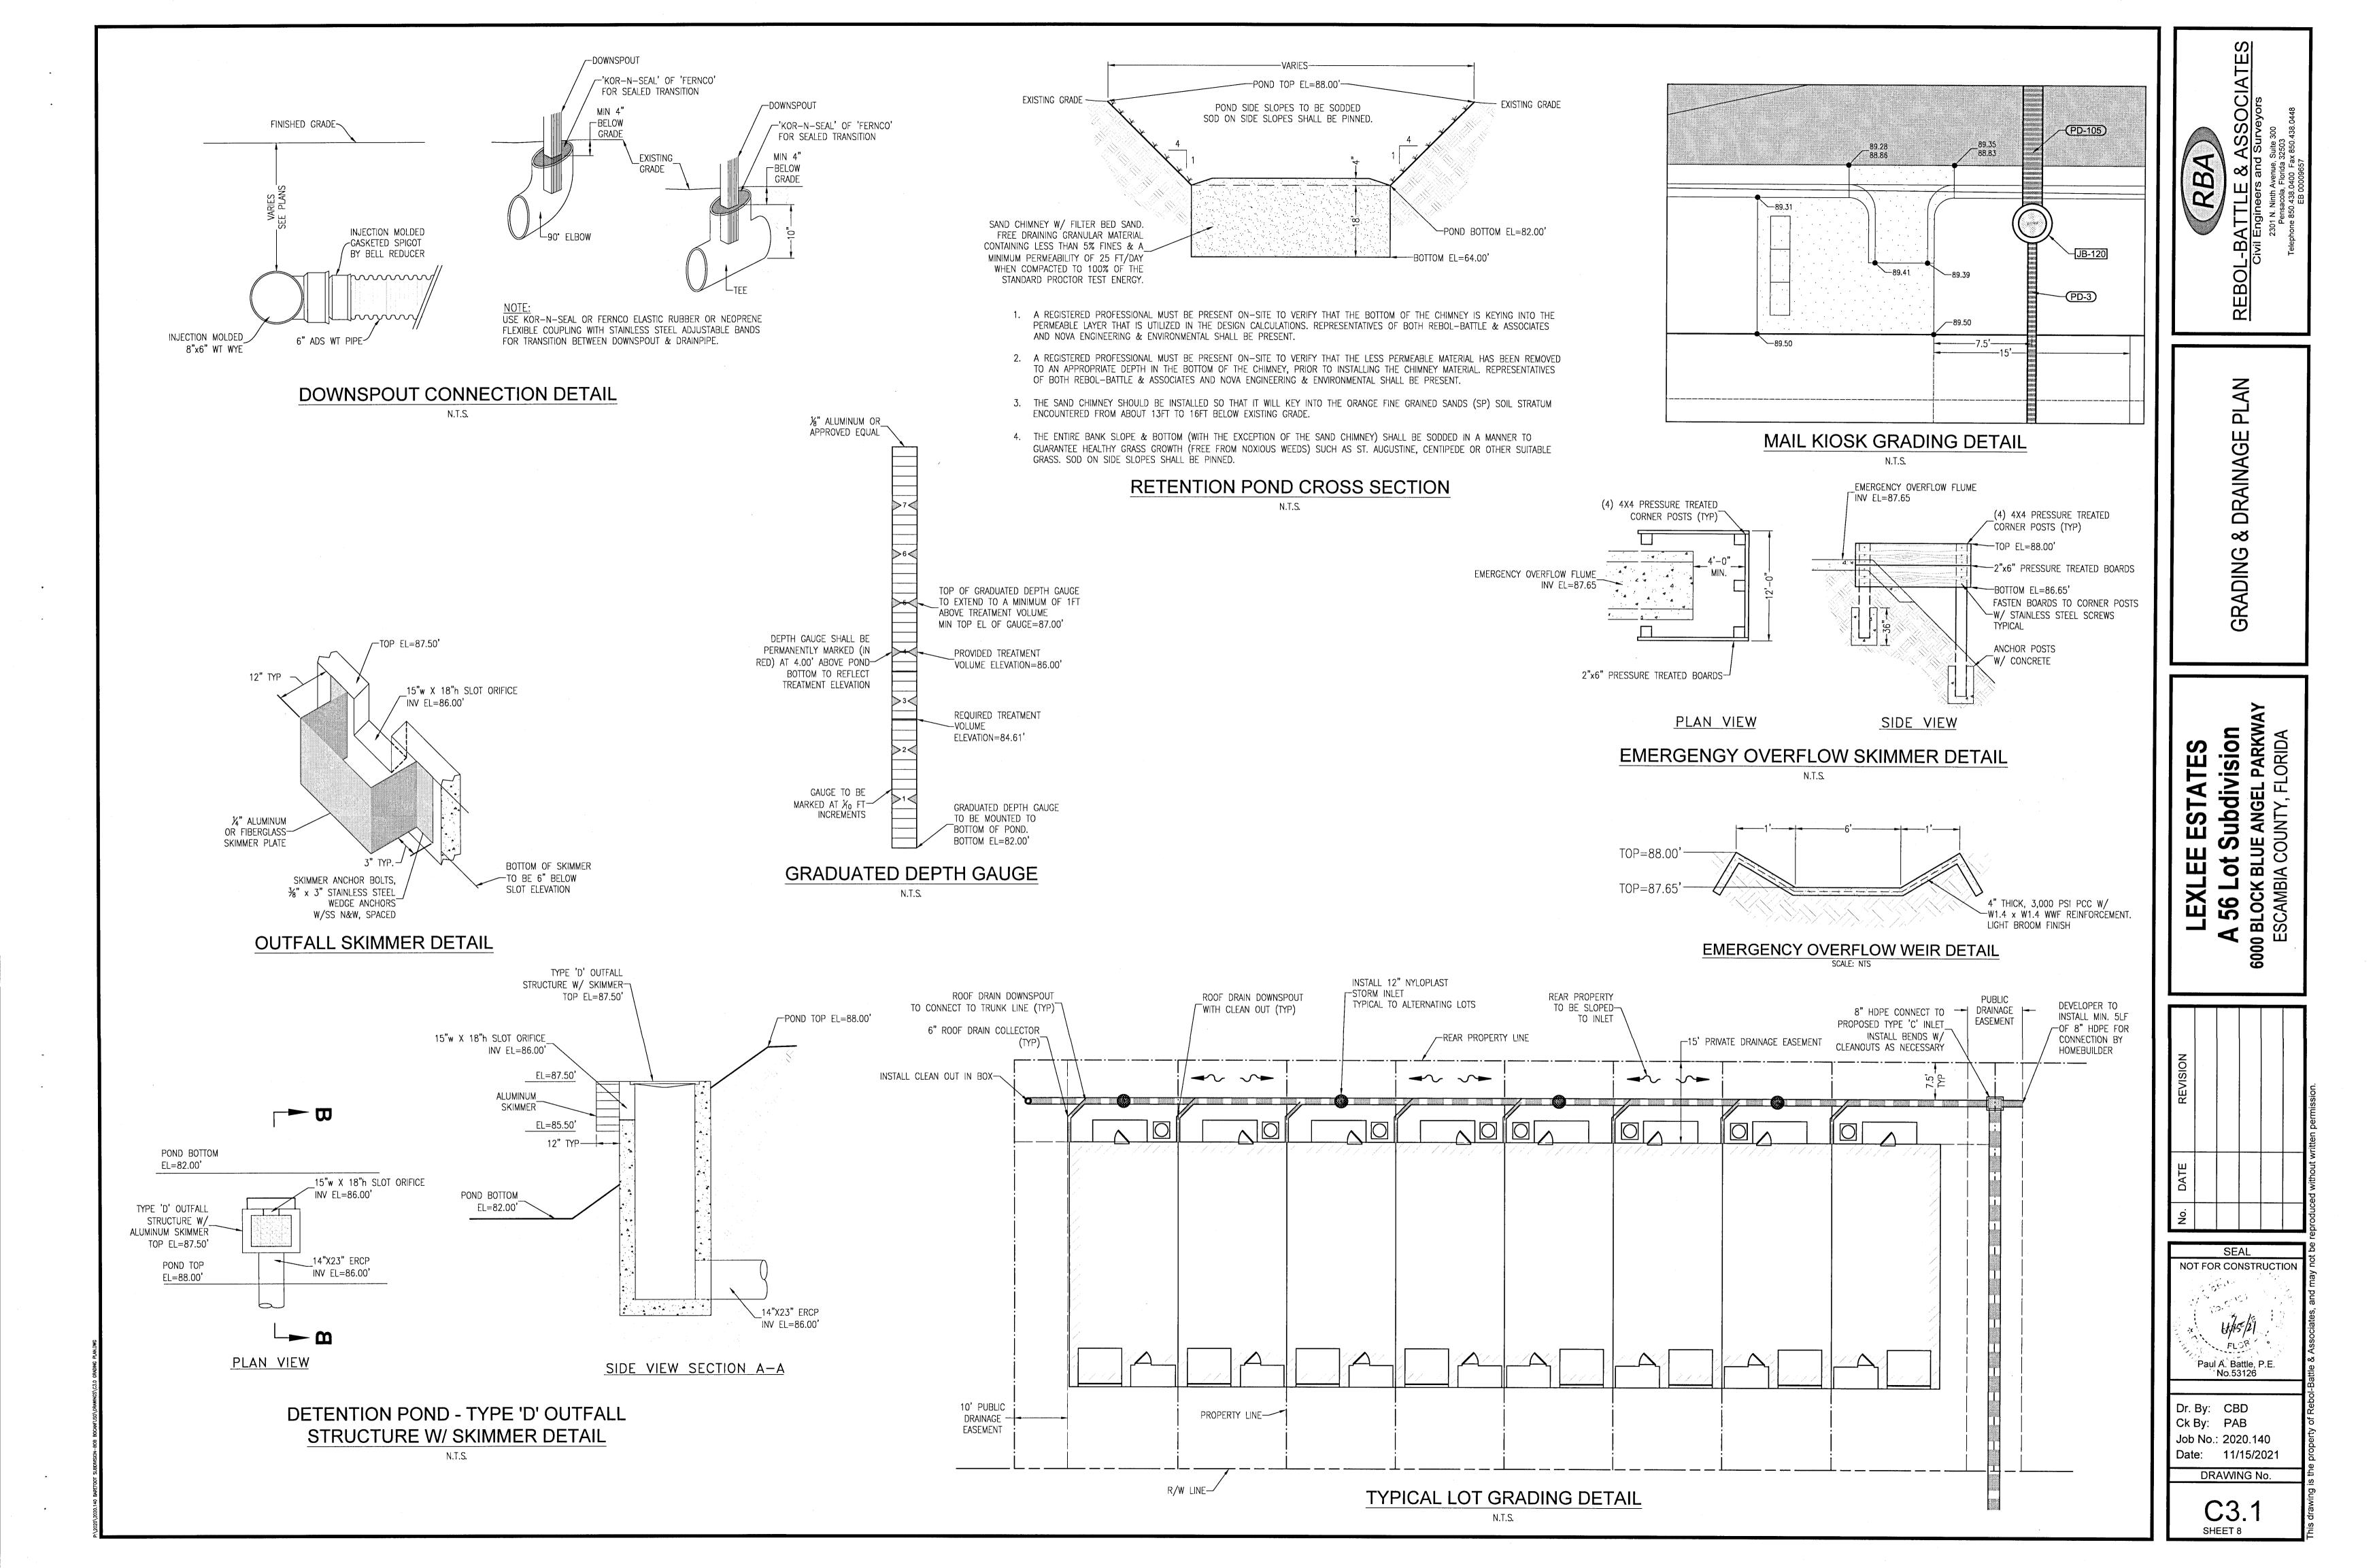
SHEET 7


5. HOMEBUILDER TO CONTACT ESCAMBIA COUNTY INSPECTOR 48 HOURS BEFORE


INSTALL 12" NYLOPLAST STORM INLETS LOCATED ON ALTERNATING LOTS. REAR YARDS TO


HOMEBUILDER PIPES ARE INSTALLED.

BE SLOPED TO INLETS.



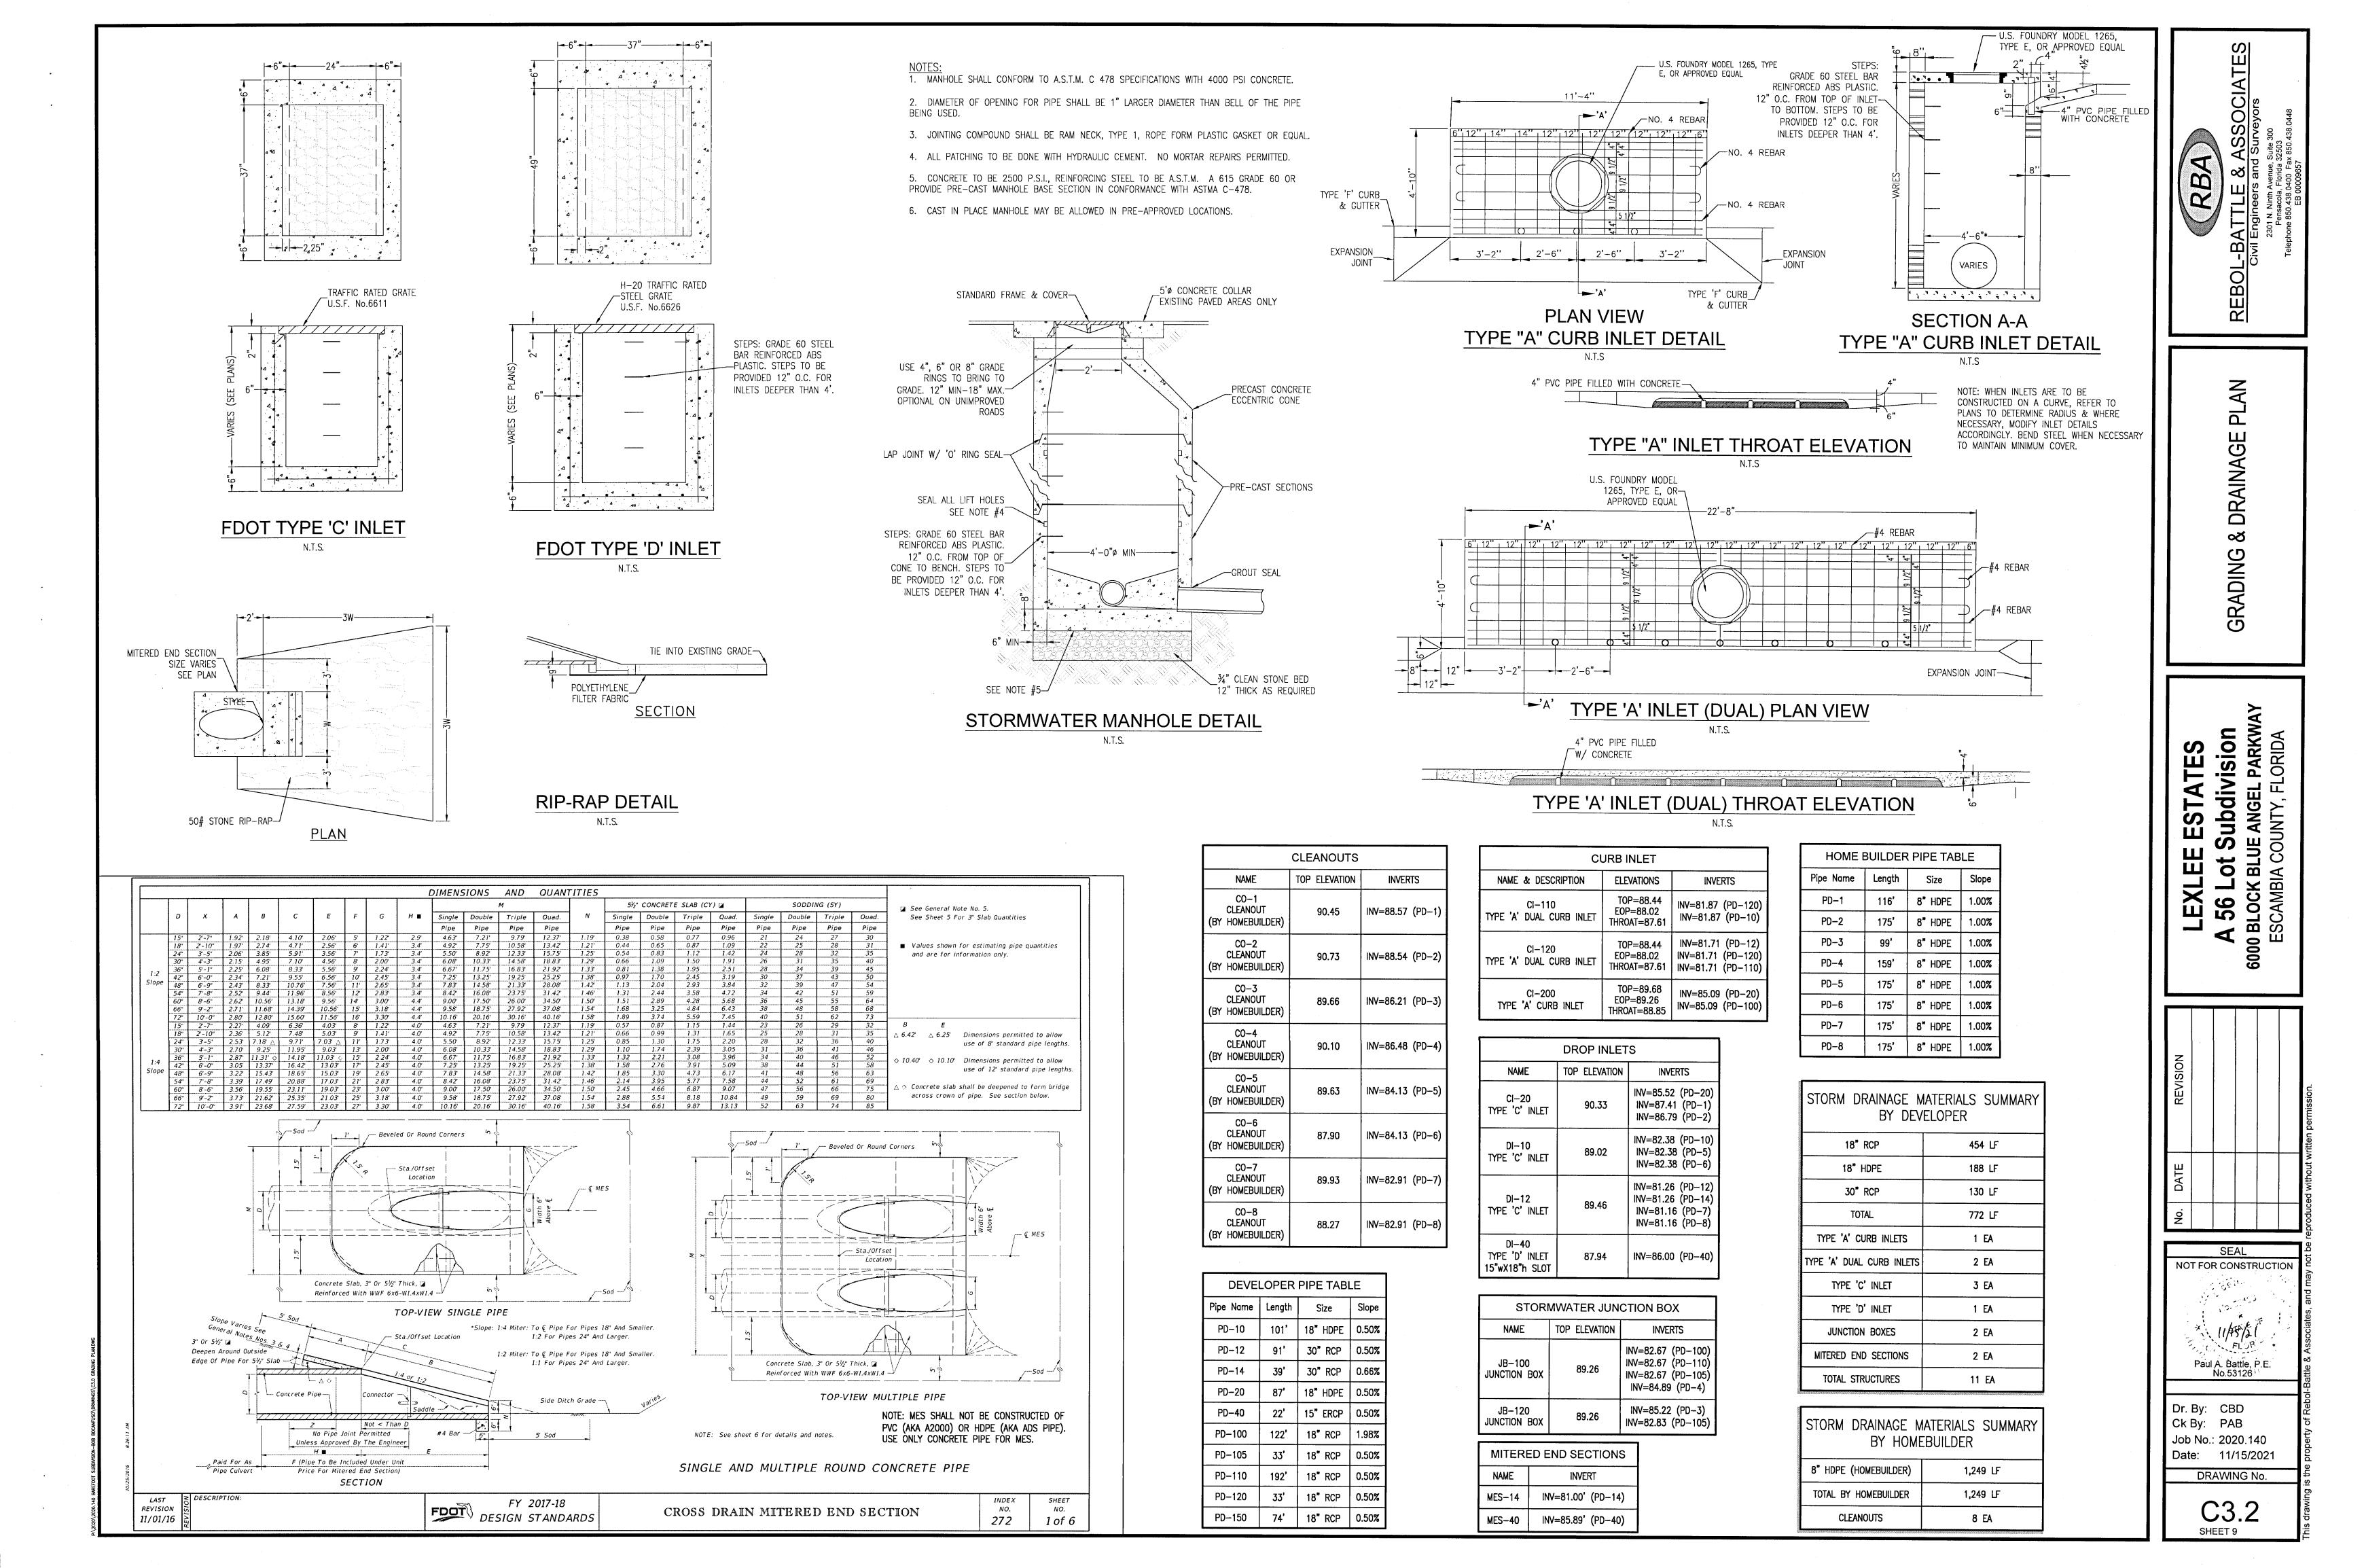

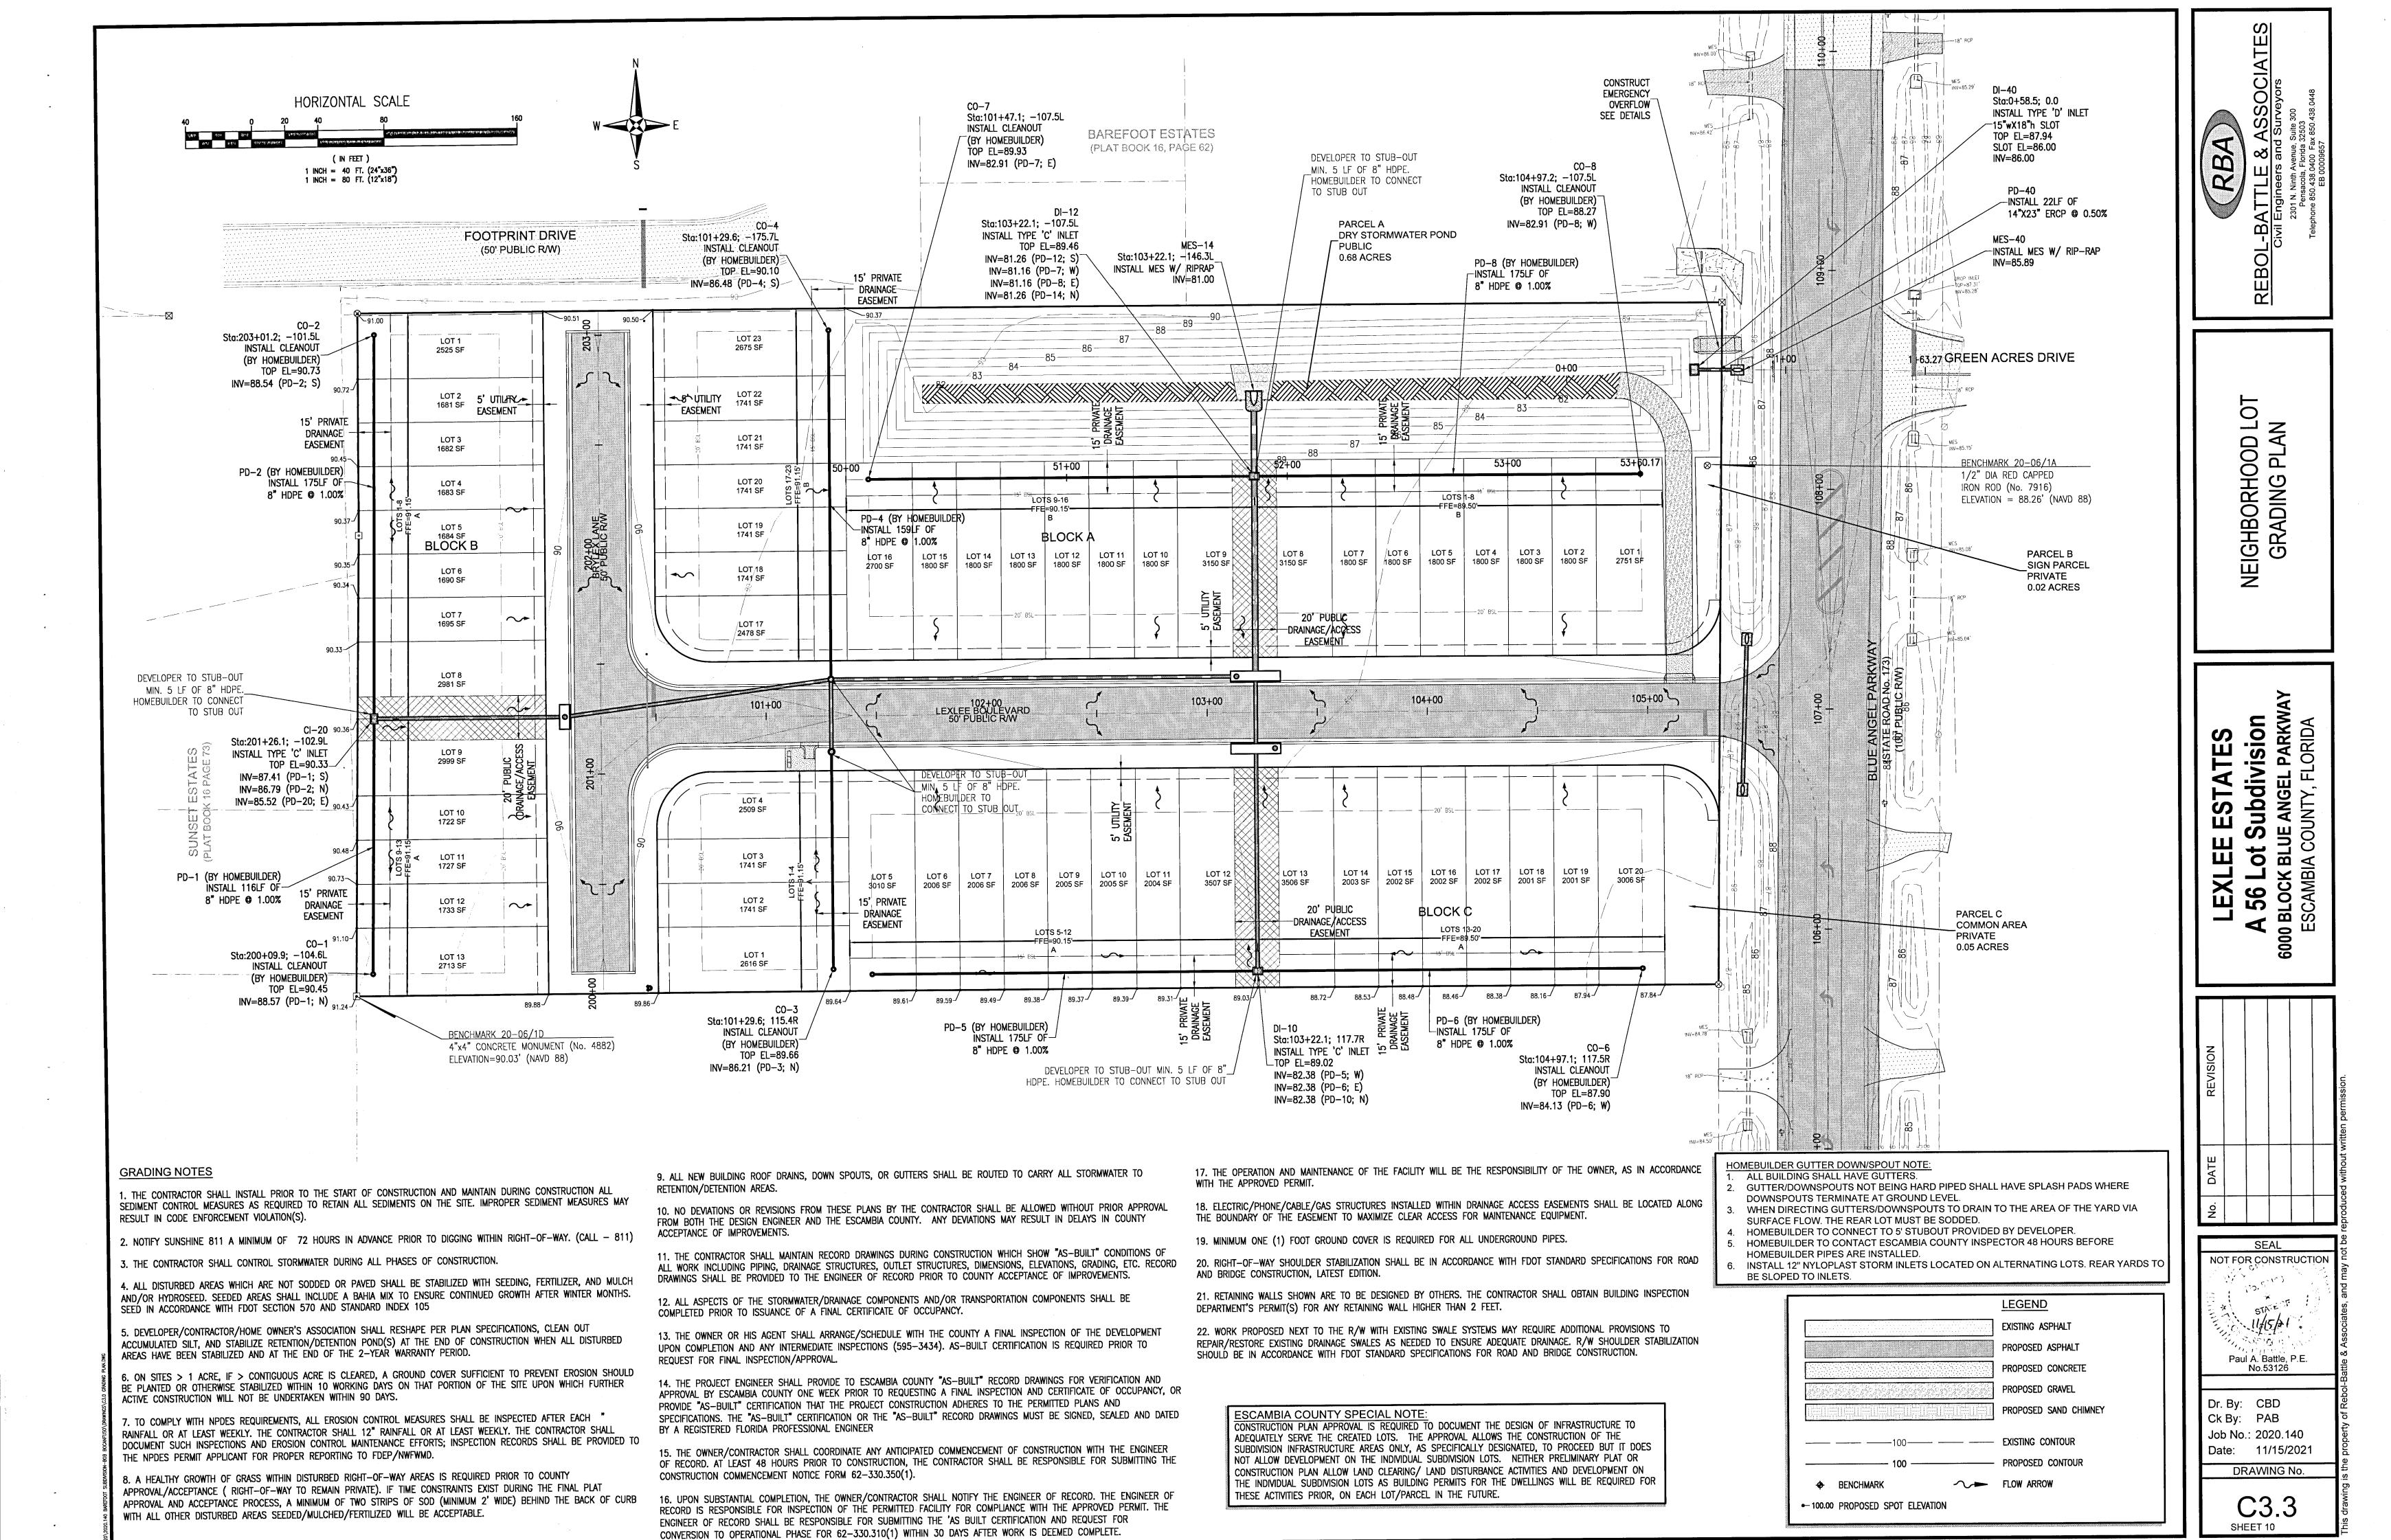

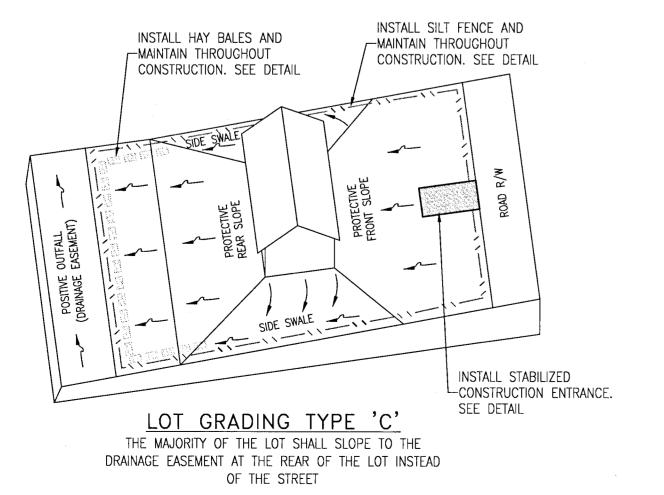

NOTE: VARIATIONS IN GRADING ARE ACCEPTABLE IF GRADING DRAINS TO A POSITIVE OUTFALL.

MAXIMUM LOT SURFACE COVERAGE

ALL RESIDENTIAL LOTS 1,900 SF (HOUSE & DRIVEWAY)

TOTAL IMPERVIOUS SURFACE

TOTAL NEW INFRASTRUCTURE

24,488 SF (ROADWAY, CURB)

TOTAL IMPERVIOUS AREA FOR POST DEVELOPMENT CONDITIONS

130,888 SF (NEW INFRASTRUCTURE, LOTS)

R/W LINE. COMPACTION AND TESTING IF NECESSARY, THIS WILL BE THE RESPONSIBILITY OF THE OWNER/CONTRACTOR.

DRIVEWAYS ABUTTING A DIRT ROAD SHALL BE MILLED ASPHALT, GRADED AGGREGATE BASE, OR WASHED CONCRETE (4" IN DEPTH) ON THE COUNTY MAINTAINED PORTION OF DRIVEWAY.

ALL MATERIALS AND LABOR FOR INSTALLATION WILL BE THE RESPONSIBILITY OF THE PROPERTY OWNER/CONTRACTOR.

DRIVEWAYS ABUTTING PAVED ROADS SHALL BE 1 - 1/2" ASPHALT WITH 6" STABILIZED SUB GRADE OR 4" TO 6" CONCRETE

WITH 4" STABILIZED SUB GRADE - 95% COMPACTION (MODIFIED PROCTOR) WITH LBR 40 BETWEEN EDGE OF ROADWAY AND


- IF NECESSARY, REFER TO FDOT INDEX DETAILS AS REFERENCED BELOW.
- RADIUS OR FLARE IS REQUIRED FOR TYPE II OR TYPE III CONNECTIONS. SEE DETAIL.
- PARKING SPACES WITHIN COUNTY RIGHT-OF-WAY SHALL PROVIDE A MINIMUM OF 2 PARKING SPACES.
- 7) TYPICAL DRIVEWAY SECTIONS ARE TO BE 12' WIDE MINIMUM.

NOTES:


CURB CUT DRIVEWAY FOR COUNTY TYPE "B" LAYBACK CURBS.

BINDING WIRE OR TWINE-

FILTERED RUNOFF-

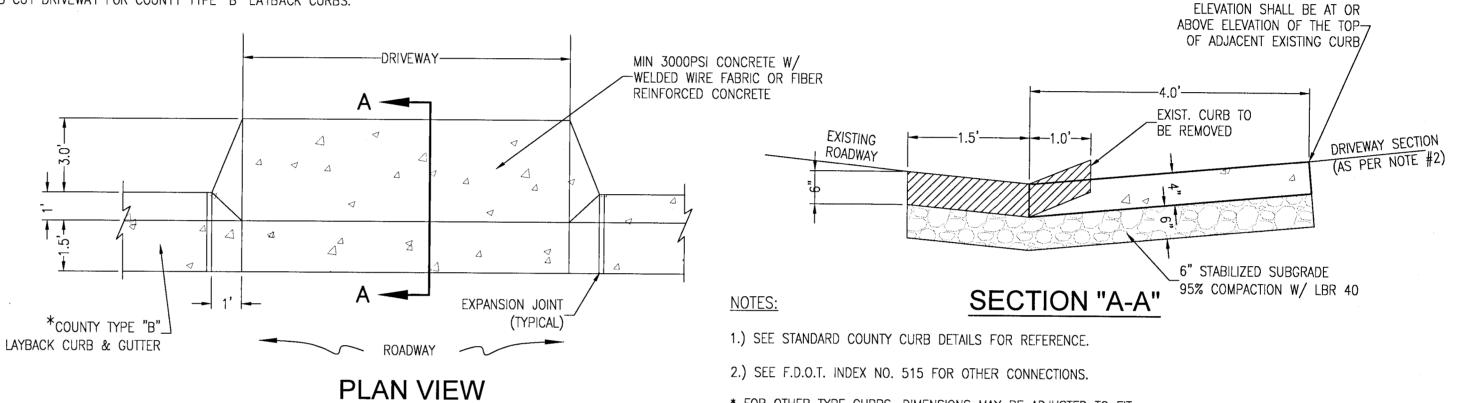


TYPICAL DRIVEWAY CONNECTION STANDARDS FOR EXISTING ROADWAY CONDITIONS

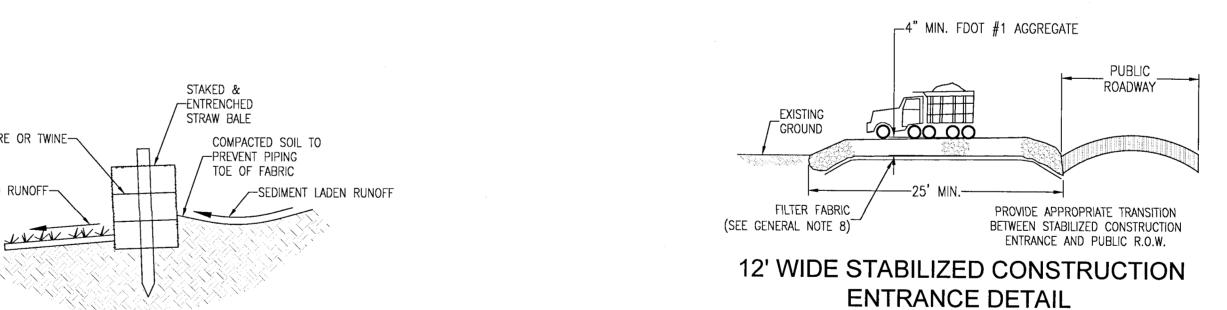


* FOR OTHER TYPE CURBS, DIMENSIONS MAY BE ADJUSTED TO FIT.

STRAW BALE DETAIL

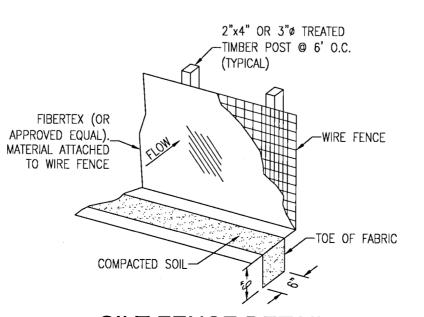

SILT FENCE DETAIL

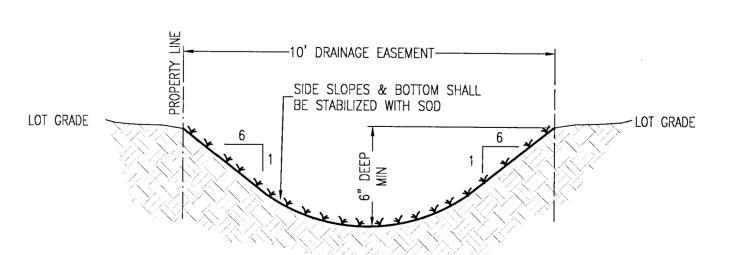

N.T.S.

2. HOME EQUIPMENT (I.E. AC UNITS) SHALL NOT HINDER THE PROPER INSTALLATION

AND/OR FUNCTION OF THE SIDE YARD SWALES

3. ALL NEW ROOF RUNOFF, DOWNSPOUTS, AND GUTTERS, SHALL BE ROUTED TO CARRY ALL STORMWATER TO THE ROADS OR SWALES THAT LEAD TO THE RETENTION POND

TYPICAL PRIVATE 10' DRAINAGE EASEMENT SWALE

- GRADIN(.S LOT ORHOOD PLAN DE NEIGHB(


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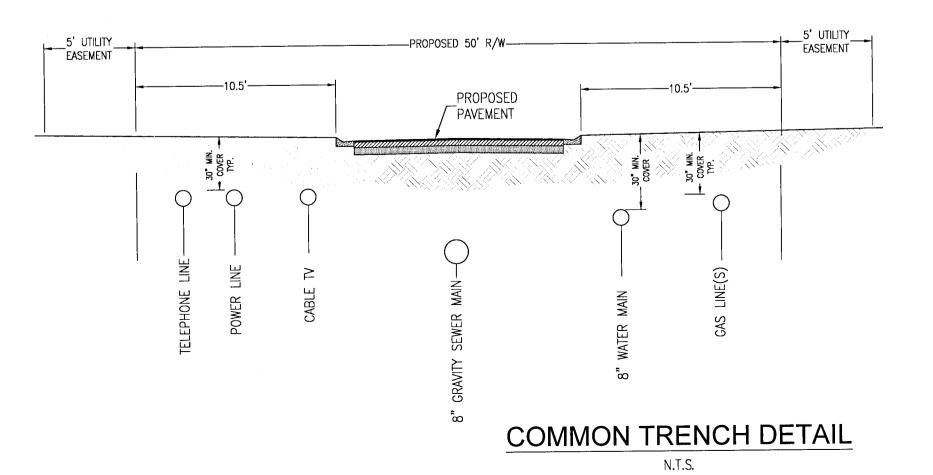
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SEAL NOT FOR CONSTRUCTION Paul A. Battle, P.E. No.53126

Dr. By: CBD Ck By: PAB Job No.: 2020.140 Date: 11/15/2021 DRAWING No.

> C4.0 SHEET 12



NOTES:

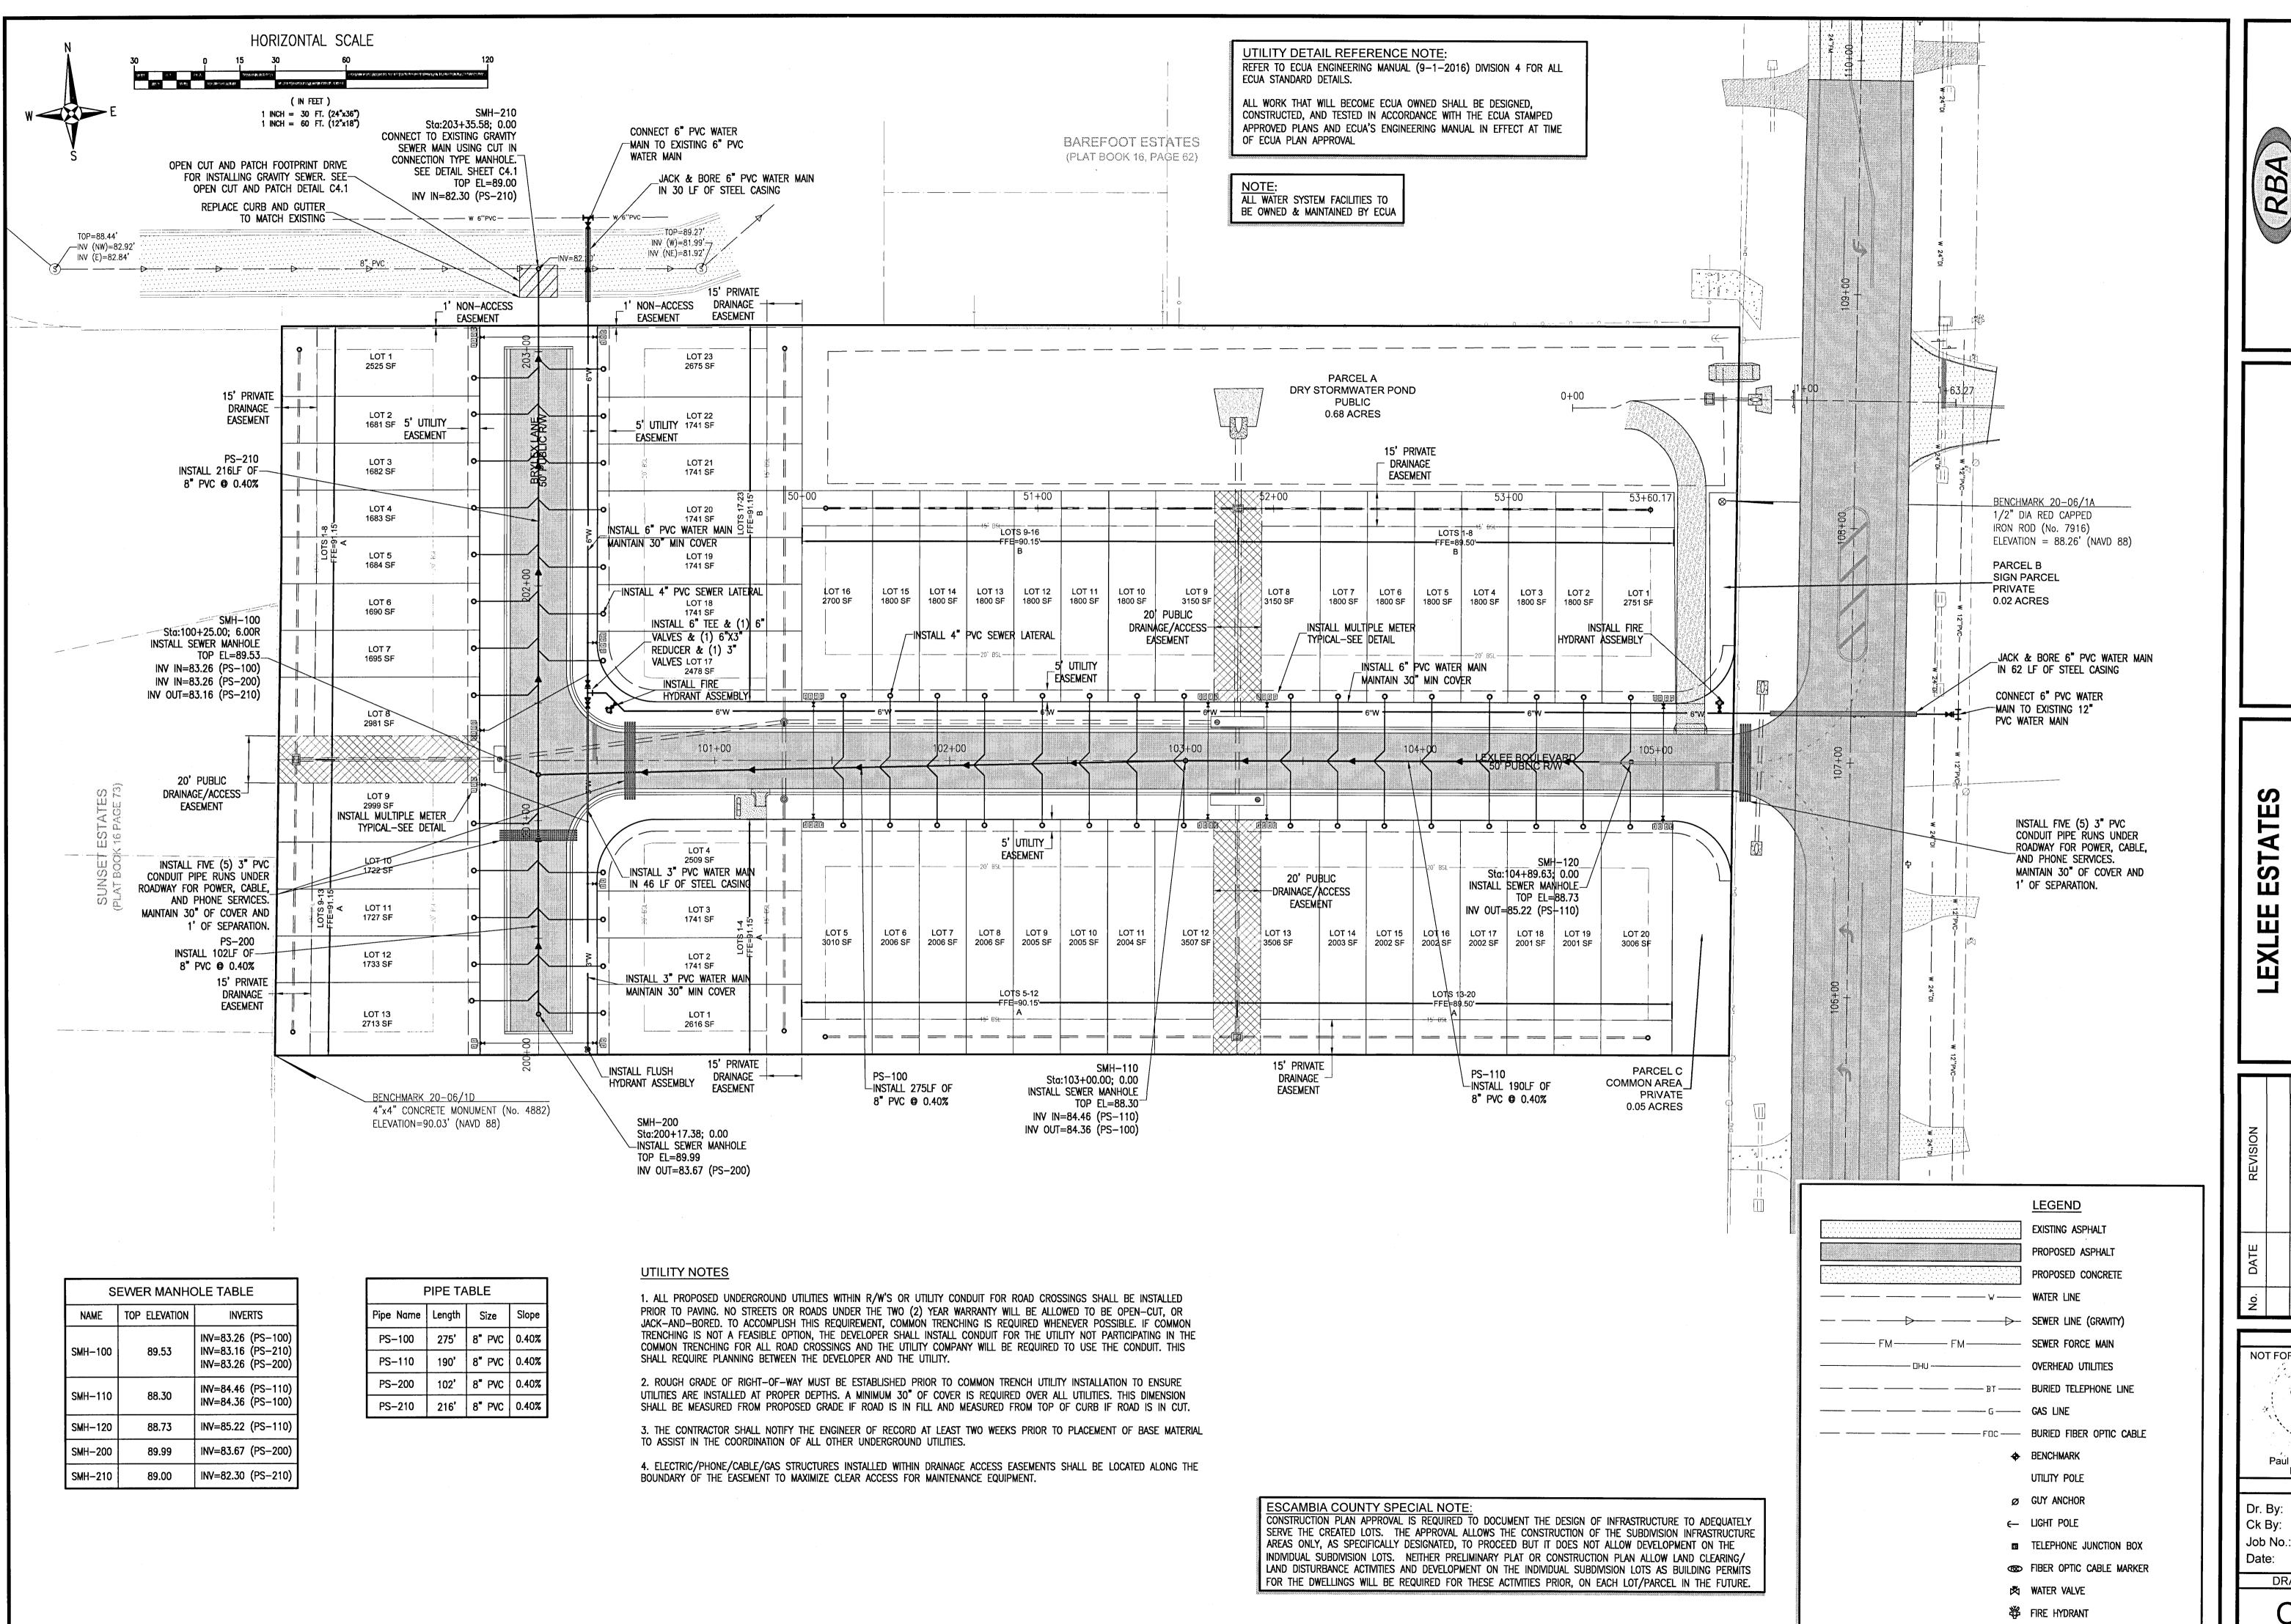1. NO STREETS OR ROADS UNDER THE TWO—YEAR WARRANTY WILL BE ALLOWED TO BE OPEN—CUT, OR JACK AND BORED. TO ACCOMPLISH THIS REQUIREMENT, COMMON TRENCHING IS REQUIRED WHENEVER POSSIBLE. IF COMMON TRENCHING IS NOT A FEASIBLE OPTION, THE DEVELOPER SHALL INSTALL CONDUIT FOR THE UTILITY NOT PARTICIPATING IN THE COMMON TRENCHING FOR ALL ROAD CROSSINGS AND THE UTILITY COMPANY WILL BE REQUIRED TO USE THE CONDUIT INSTALLED. THIS SHALL REQUIRE PLANNING BETWEEN THE DEVELOPER AND THE UTILITY. ALL PROPOSED UNDERGROUND UTILITIES WITHIN R/W'S OR UTILITY CONDUITS FOR ROAD CROSSINGS

 CONTRACTOR SHALL INSTALL EACH UTILITY SERVICE IN THE LOCATION AS SHOWN. DEVIATIONS MUST BE APPROVED BY ESCAMBIA COUNTY.

SHALL BE INSTALLED PRIOR TO PAVING.

CONTRACTOR SHALL INSTALL POWER LINE ON OPPOSITE SIDE OF ROAD AS DOMESTIC WATER LINE. NOTE:
ALL WATER SYSTEM FACILITIES TO
BE OWNED & MAINTAINED BY ECUA

ECUA STANDARD DETAILS.


OF ECUA PLAN APPROVAL

UTILITY DETAIL REFERENCE NOTE:


REFER TO ECUA ENGINEERING MANUAL (9-1-2016) DIVISION 4 FOR ALL

ALL WORK THAT WILL BECOME ECUA OWNED SHALL BE DESIGNED, CONSTRUCTED, AND TESTED IN ACCORDANCE WITH THE ECUA STAMPED APPROVED PLANS AND ECUA'S ENGINEERING MANUAL IN EFFECT AT TIME

ESCAMBIA COUNTY PATCH DETAILS

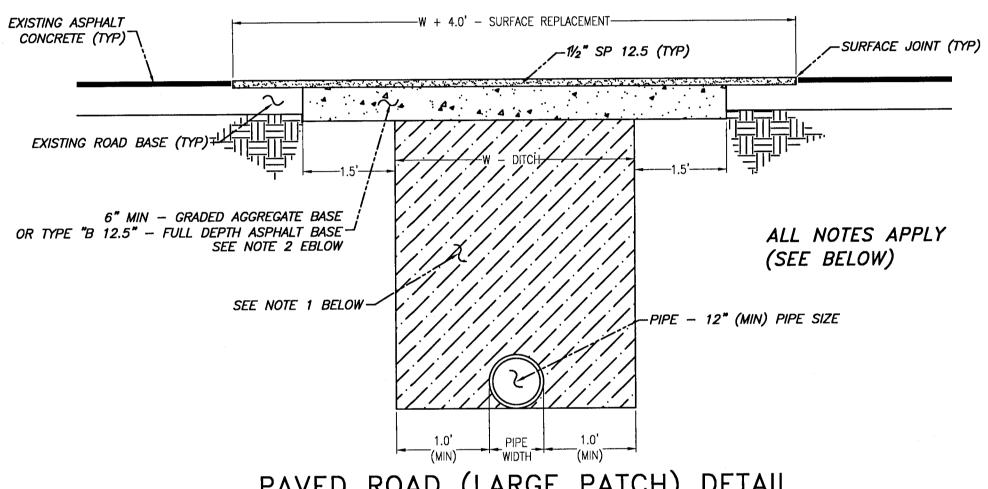


PAVED ROAD (LARGE PATCH) DETAIL
FOR LATERAL CUTS
NOT TO SCALE

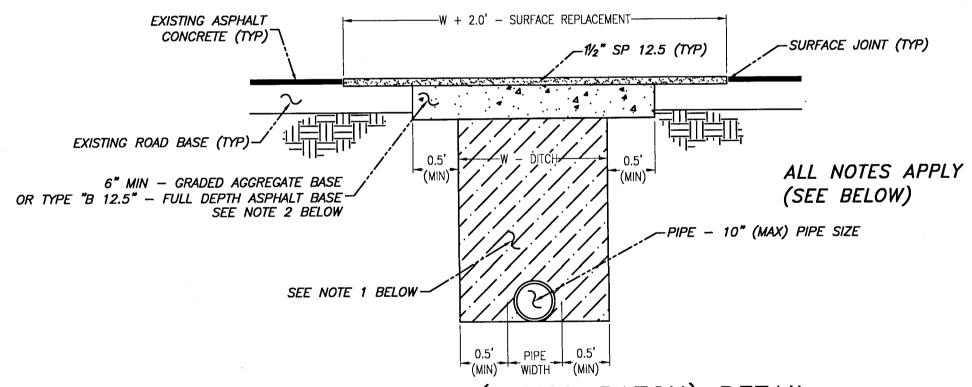

PAVED ROAD (SMALL PATCH) DETAIL

FOR LATERAL CUTS

NOT TO SCALE

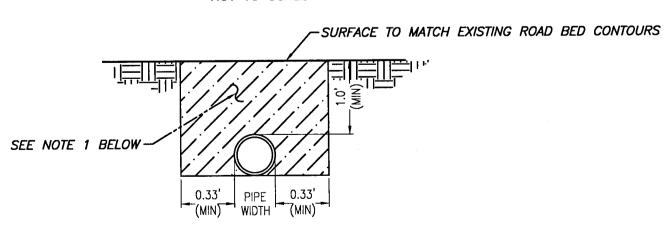

DIRT ROAD PATCH DETAIL

NOT TO SCALE

NOTES:

- 1. DIRT ROAD PATCH WORK SUB BASE MATERIAL SHALL BE PLACED IN NOT MORE THAN 8" LIFTS. EACH LAYER TO BE TAMPED TO A MINIMUM COMPACTION OF 98% MODIFIED PROCTOR TEST WITH 40 LBR.
- 2. GRADED AGGREGATE BASE SHALL BE COMPACTED TO A MIN LBR 100.
- 3. ROAD CUTS SHALL BE MECHANICALLY SAW CUT TO FORM A SURFACE PAVEMENT JOINT AND TACK COATED ALONG THE FACE OF CUT JOINTS PRIOR TO ASPHALT PLACEMENT.
- 4. LONGITUDINAL ROAD CUTS OF LESS THAN ONE—HALF PAVEMENT WIDTH TO BE PATCHED SAME AS LATERAL PATCH. LONGITUDINAL ROAD CUTS ONE—HALF OR GREATER TO BE PATCHED WITH SAME BASE MATERIAL AND ENTIRE ROAD WIDTH RESURFACED.

REBOL-BATTLE & ASSOCIAT

Civil Engineers and Surveyors

2301 N. Ninth Avenue, Suite 300
Pensacola, Florida 32503
Telephone 850 438,0408 Fax 850,438,0448


ITILITY PLAN

EXLEE ESTATES

56 Lot Subdivision

OCK BLUE ANGEL PARKWAY

AMBIA COUNTY, FLORIDA

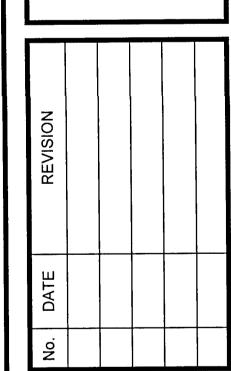

SEAL

NOT FOR CONSTRUCTION


Paul A. Battle, P.E.
No.53126


Dr. By: CBD
Ck By: PAB
Job No.: 2020.140
Date: 11/15/2021


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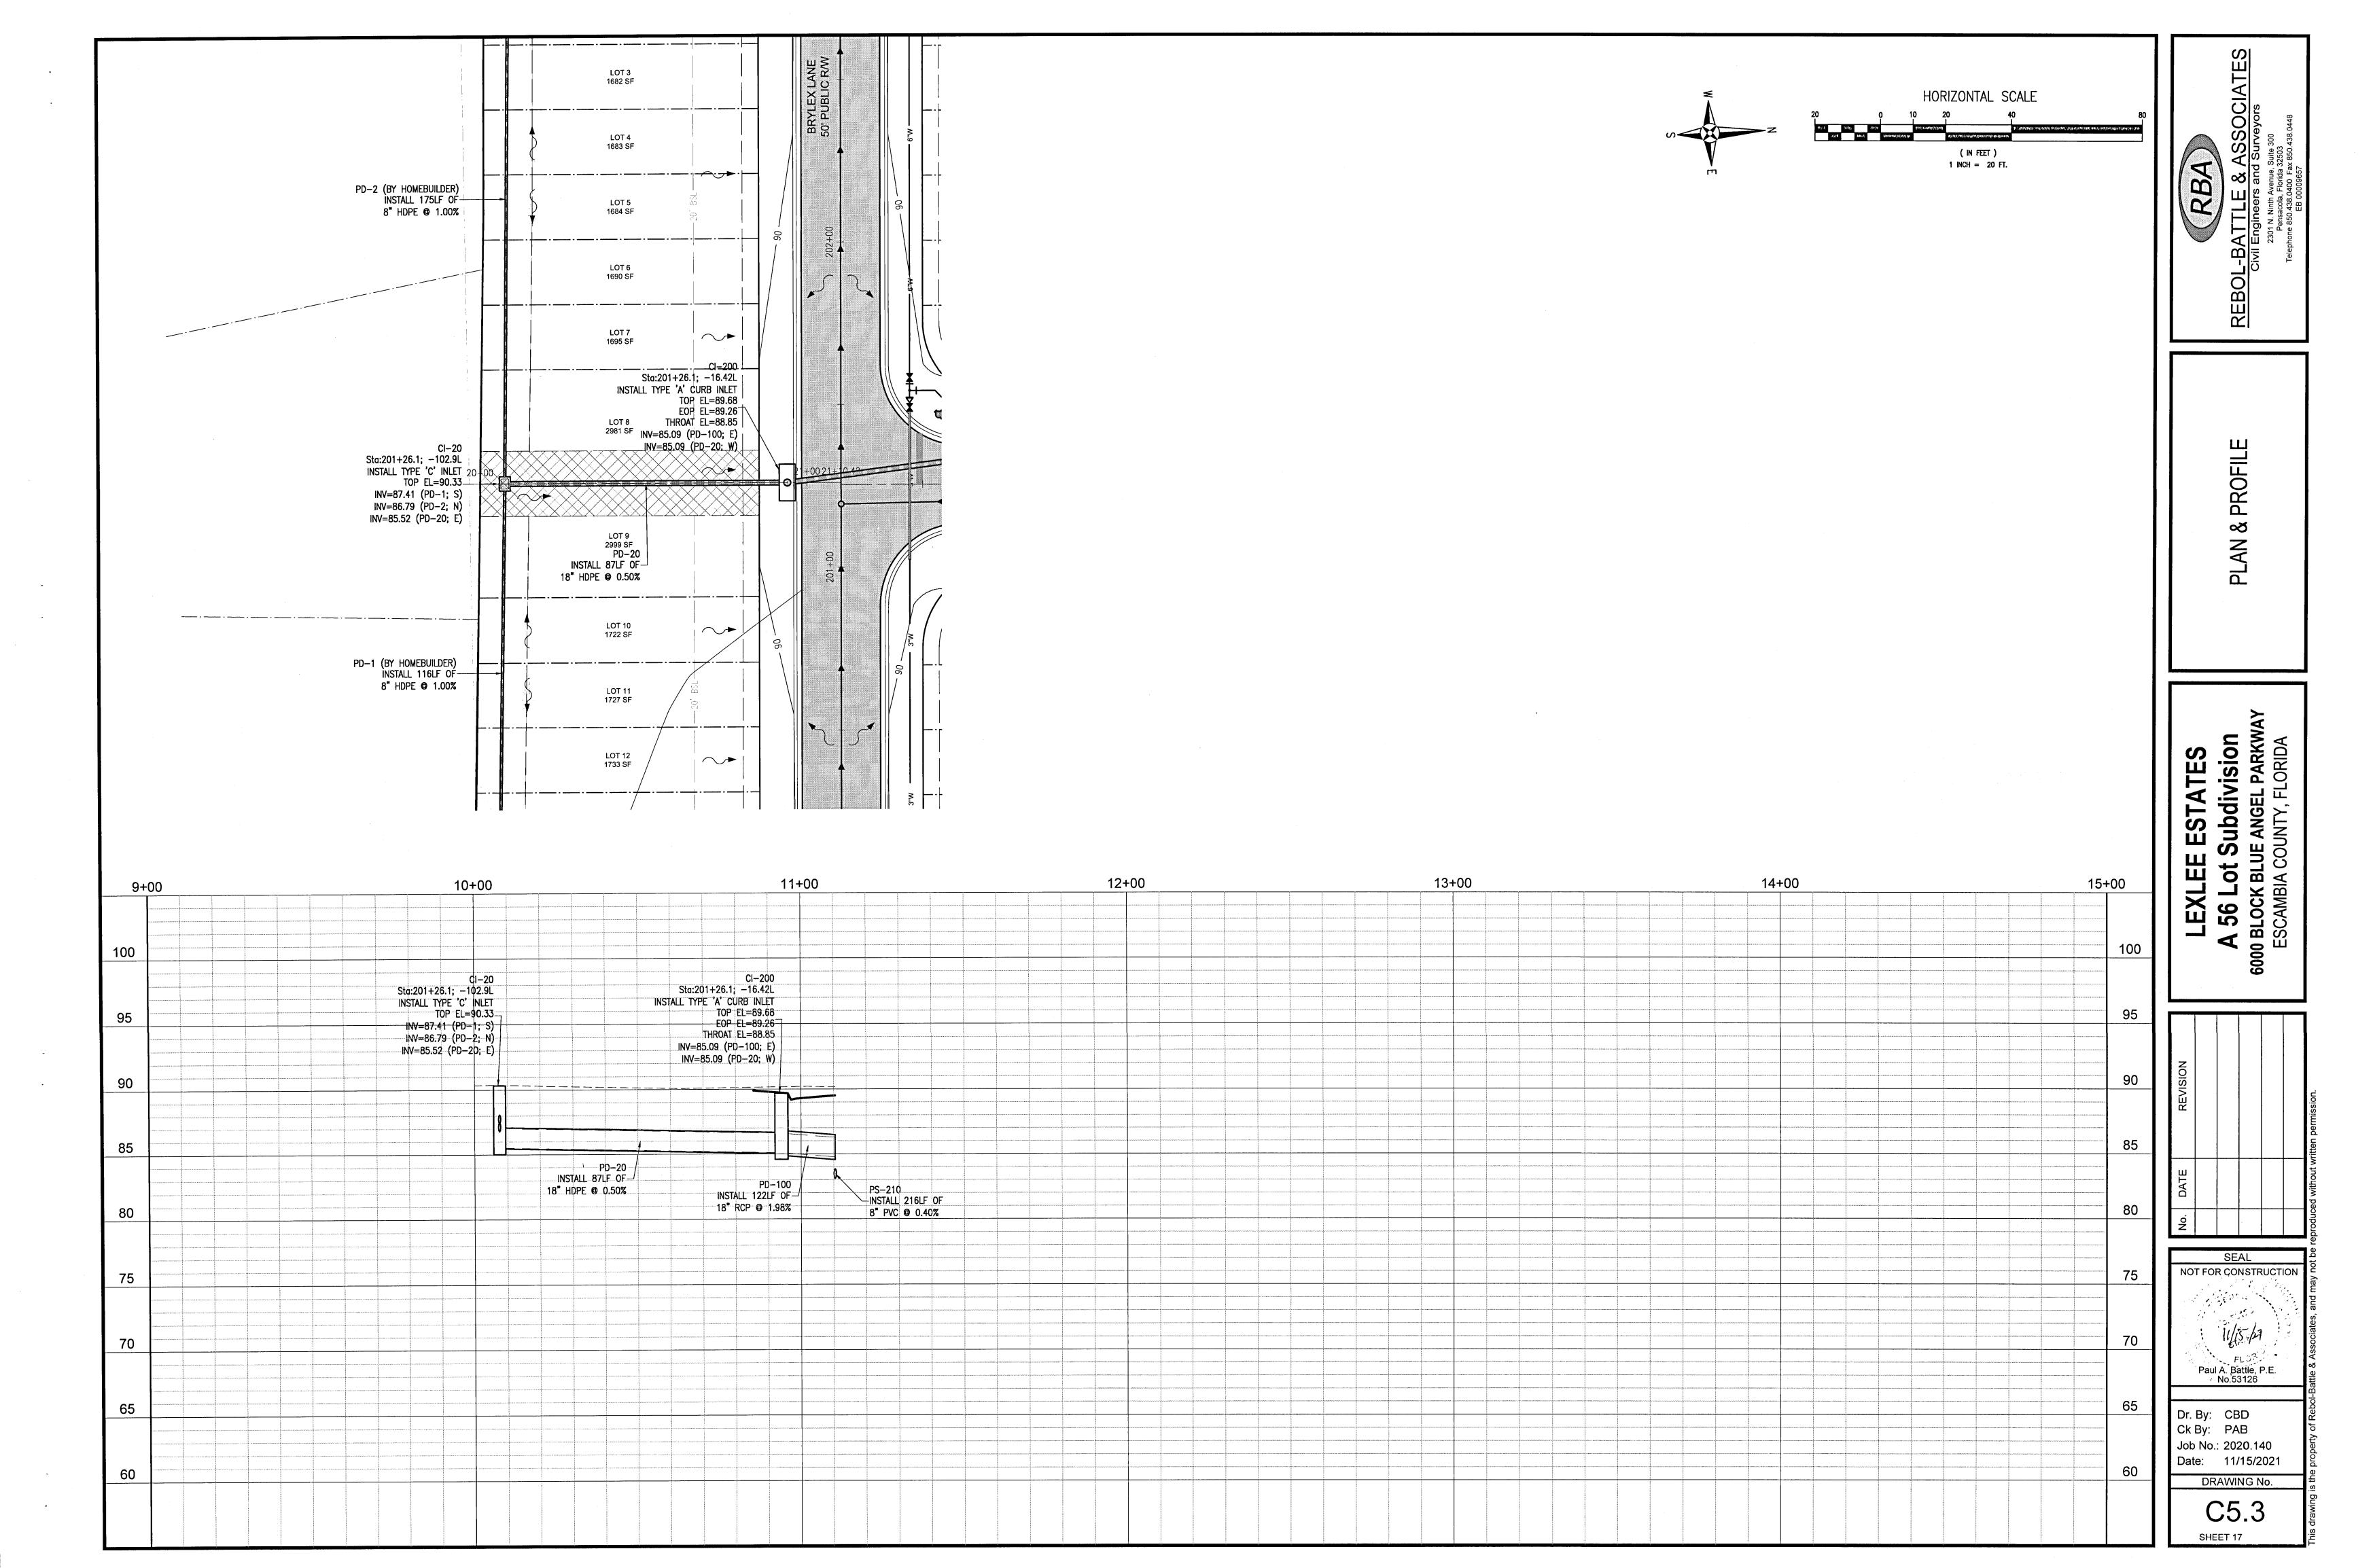
C4.1


SHEET 13




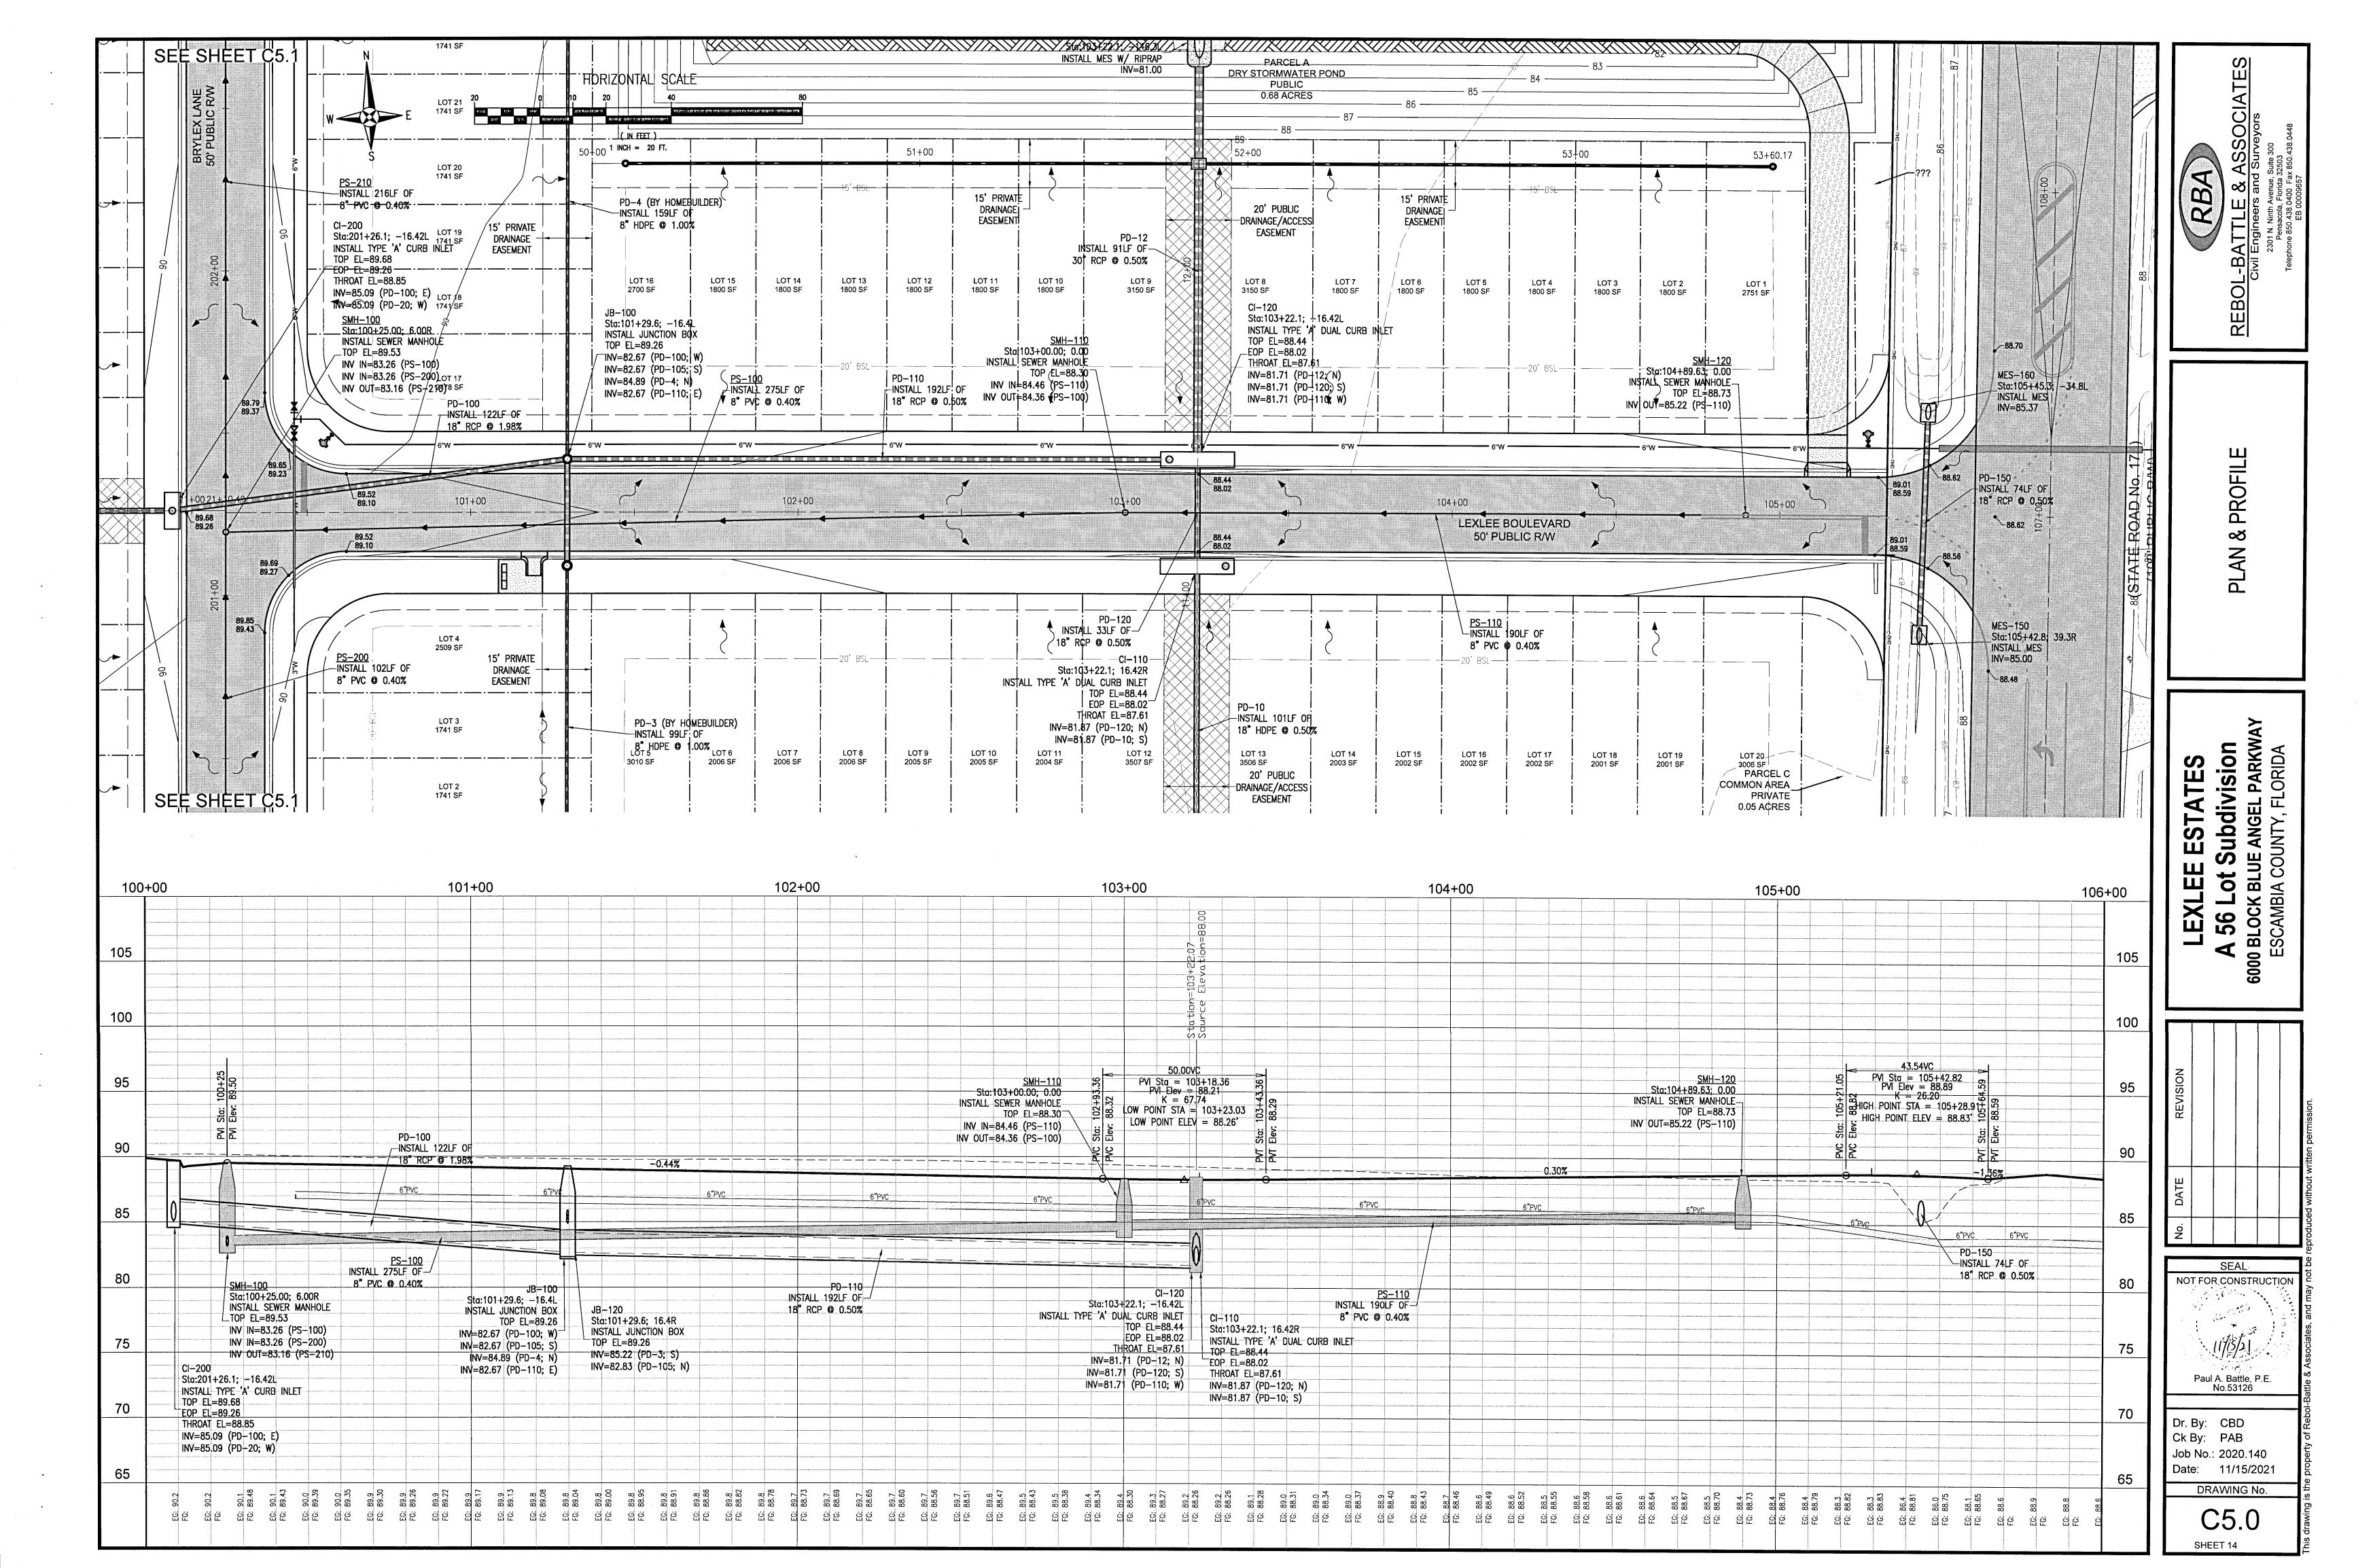

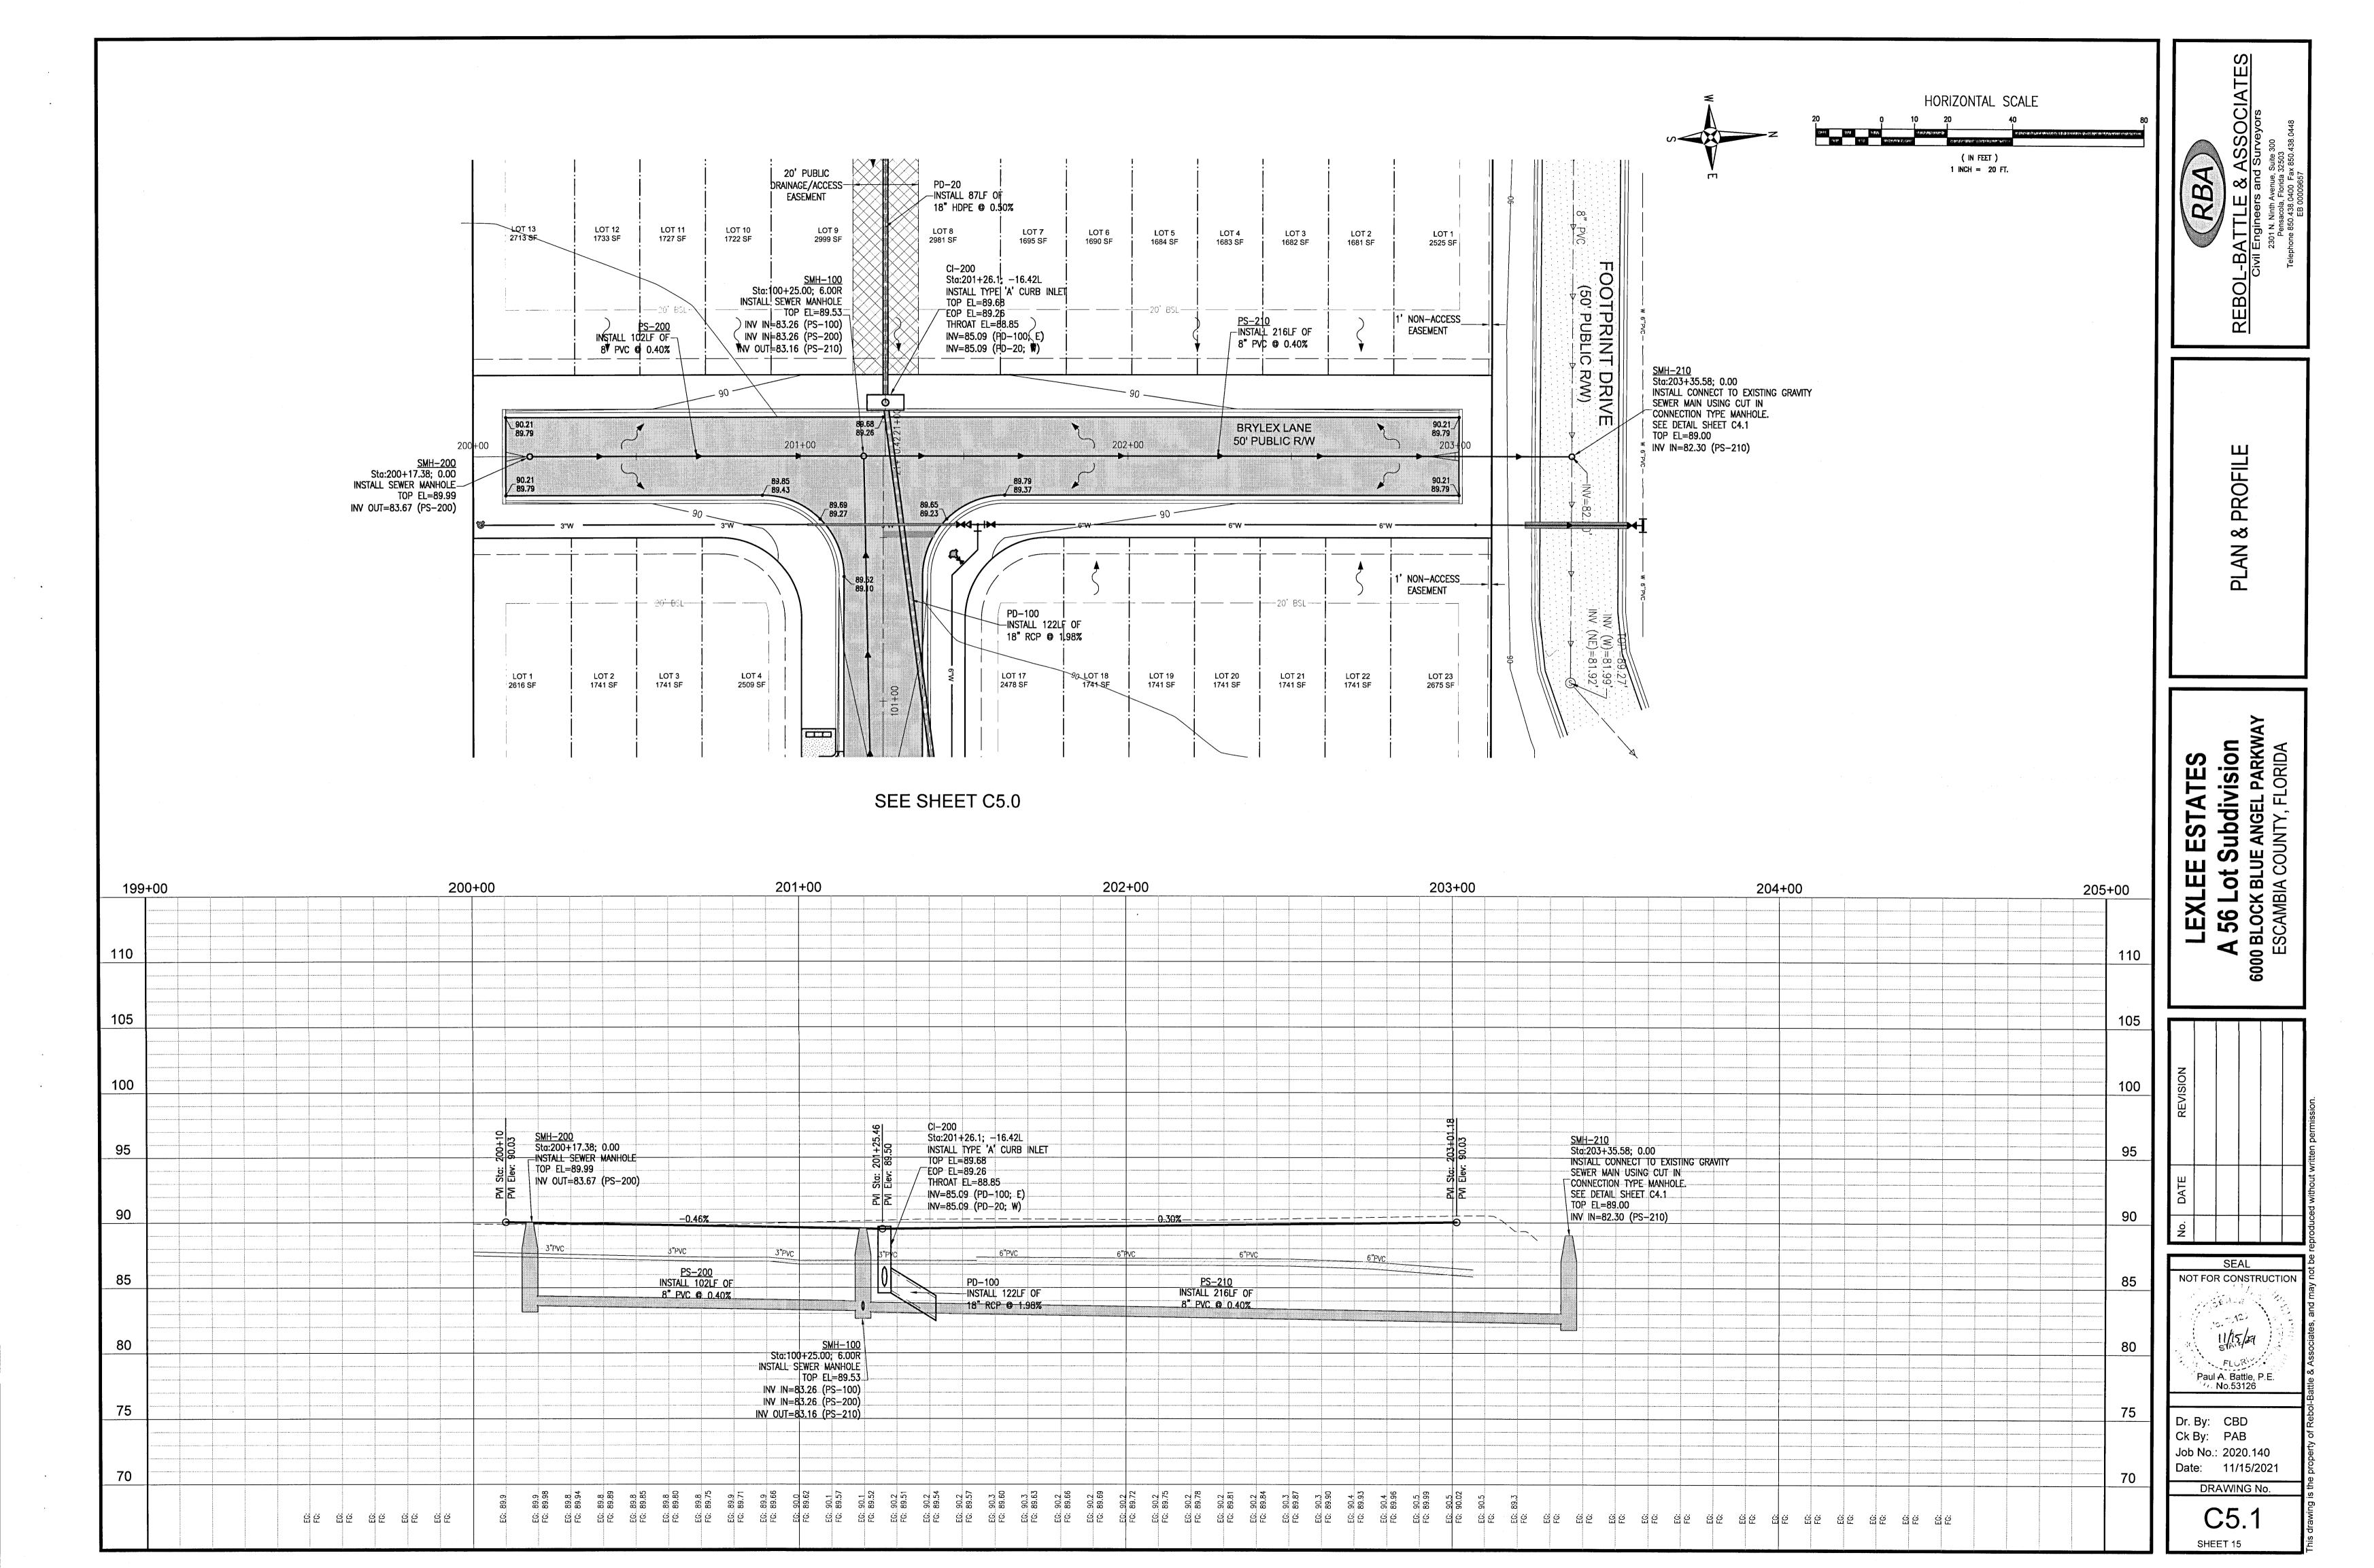

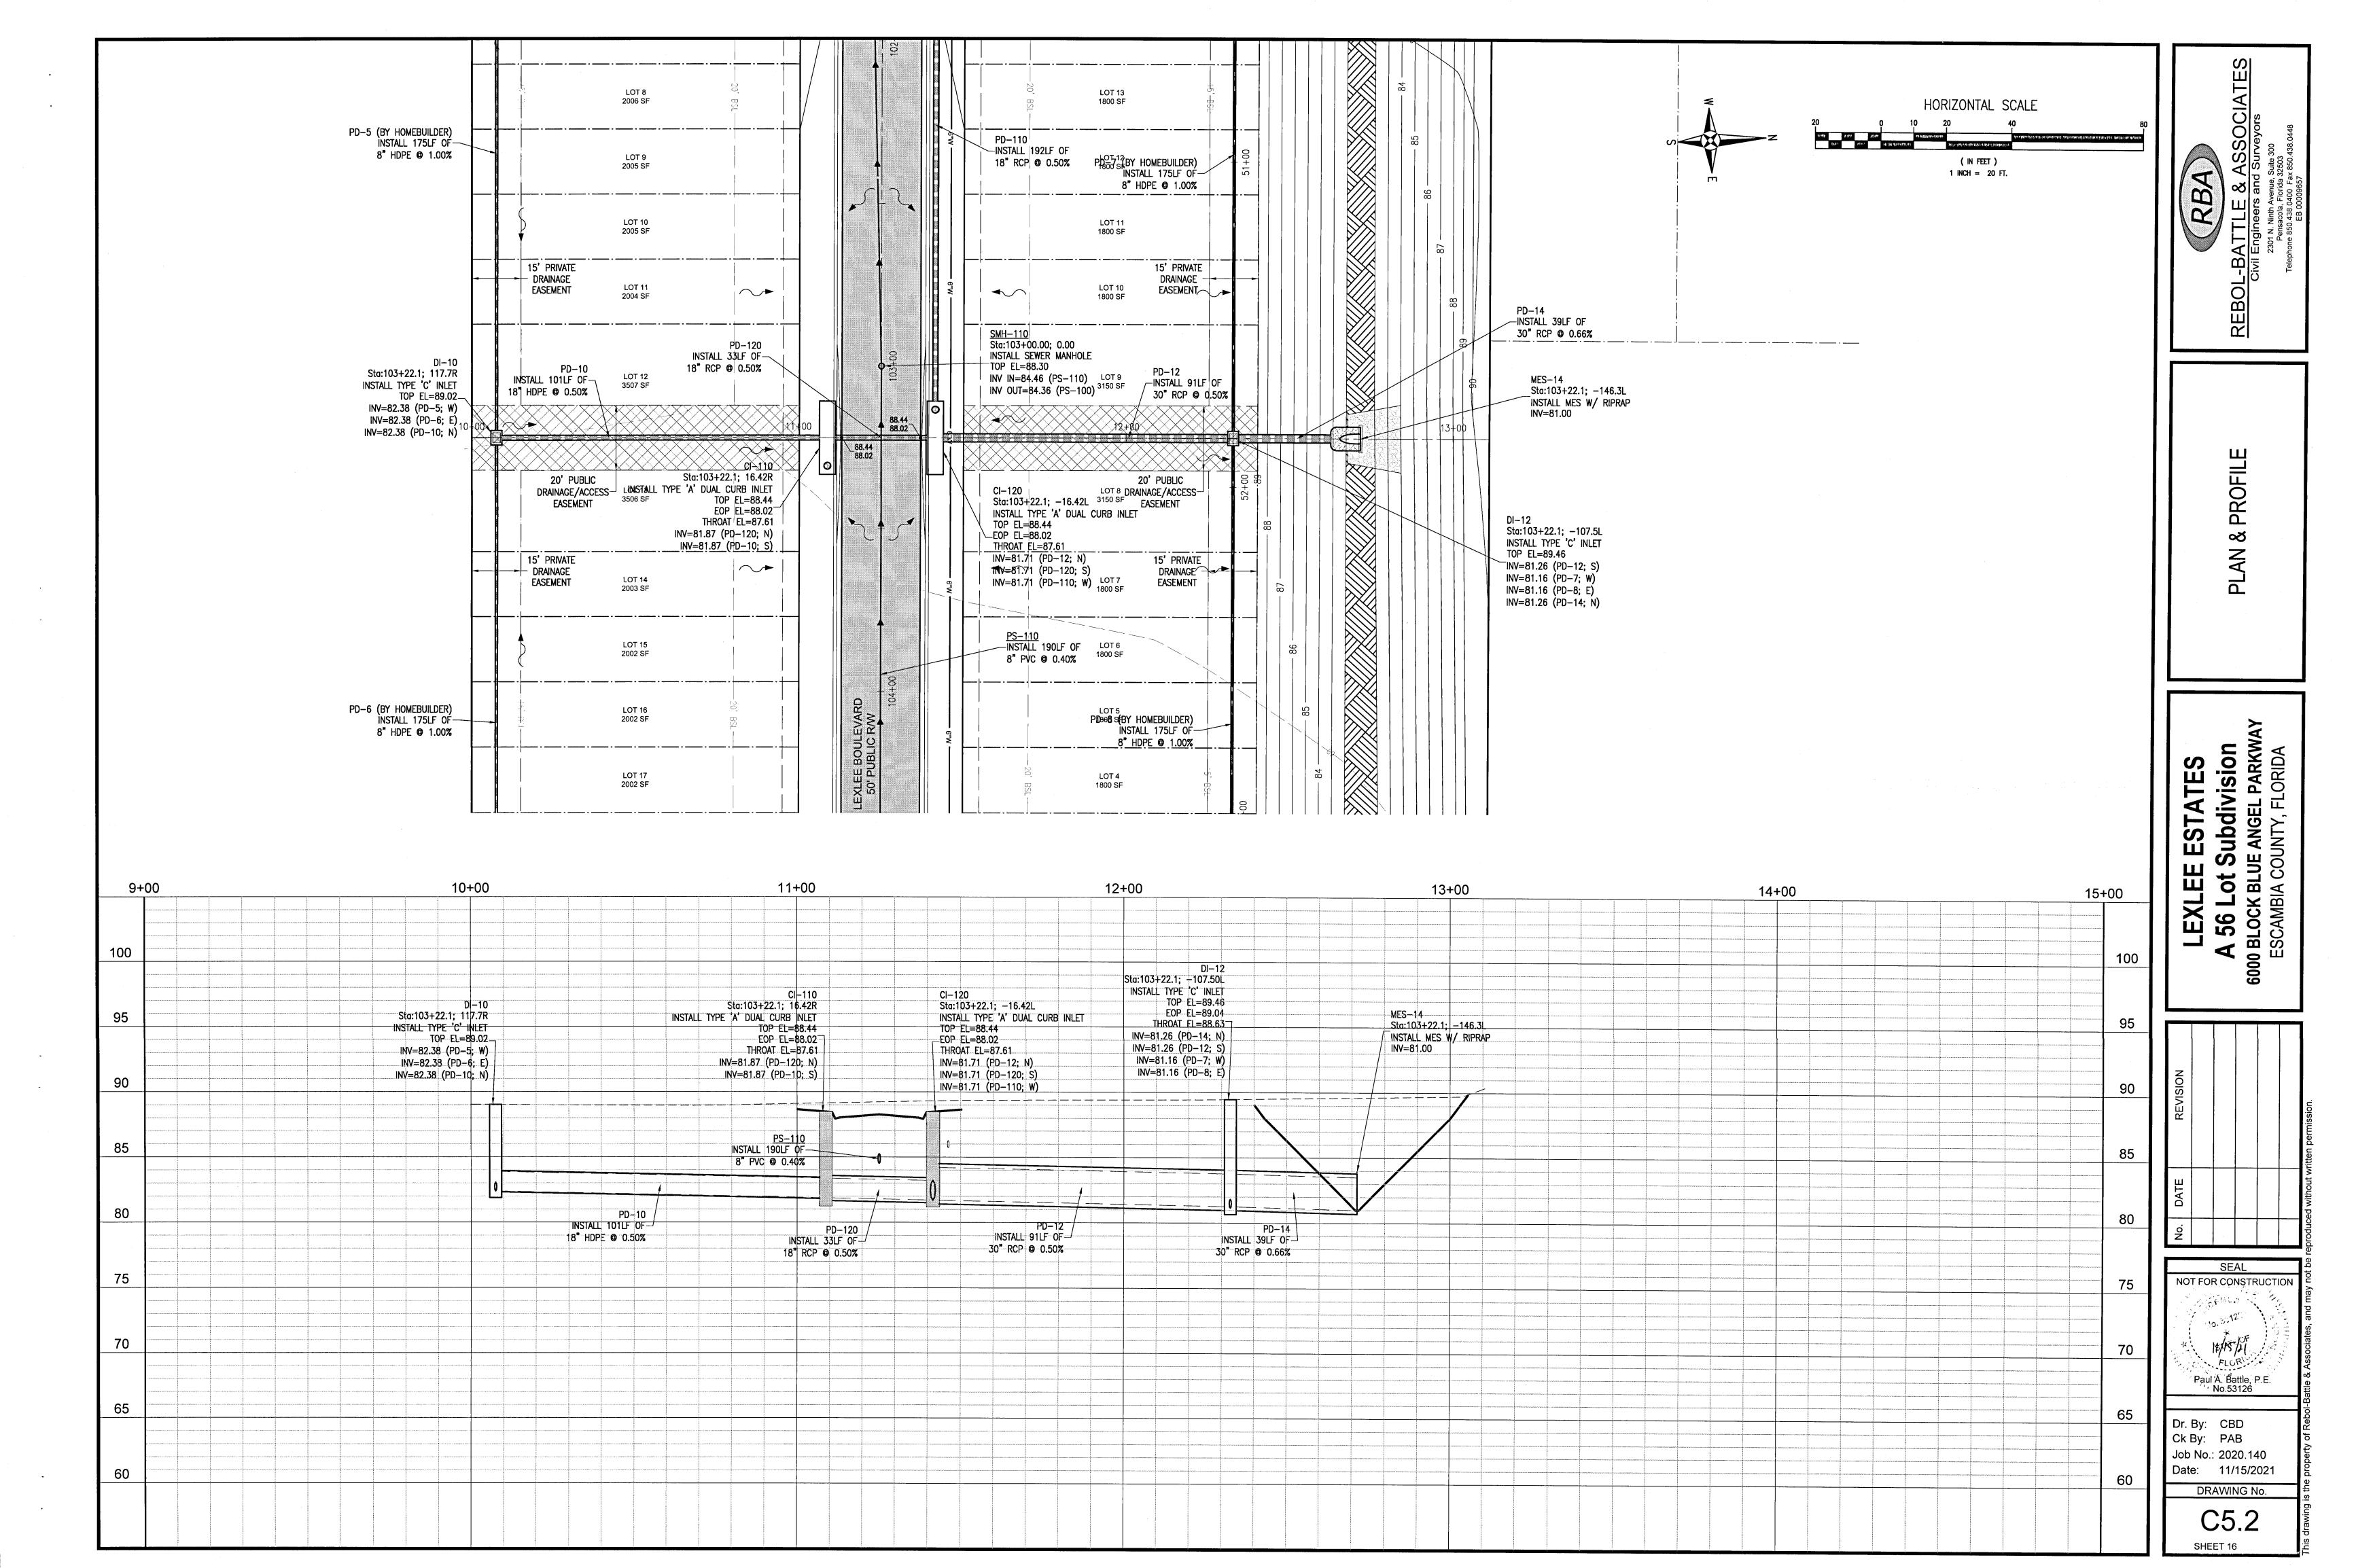

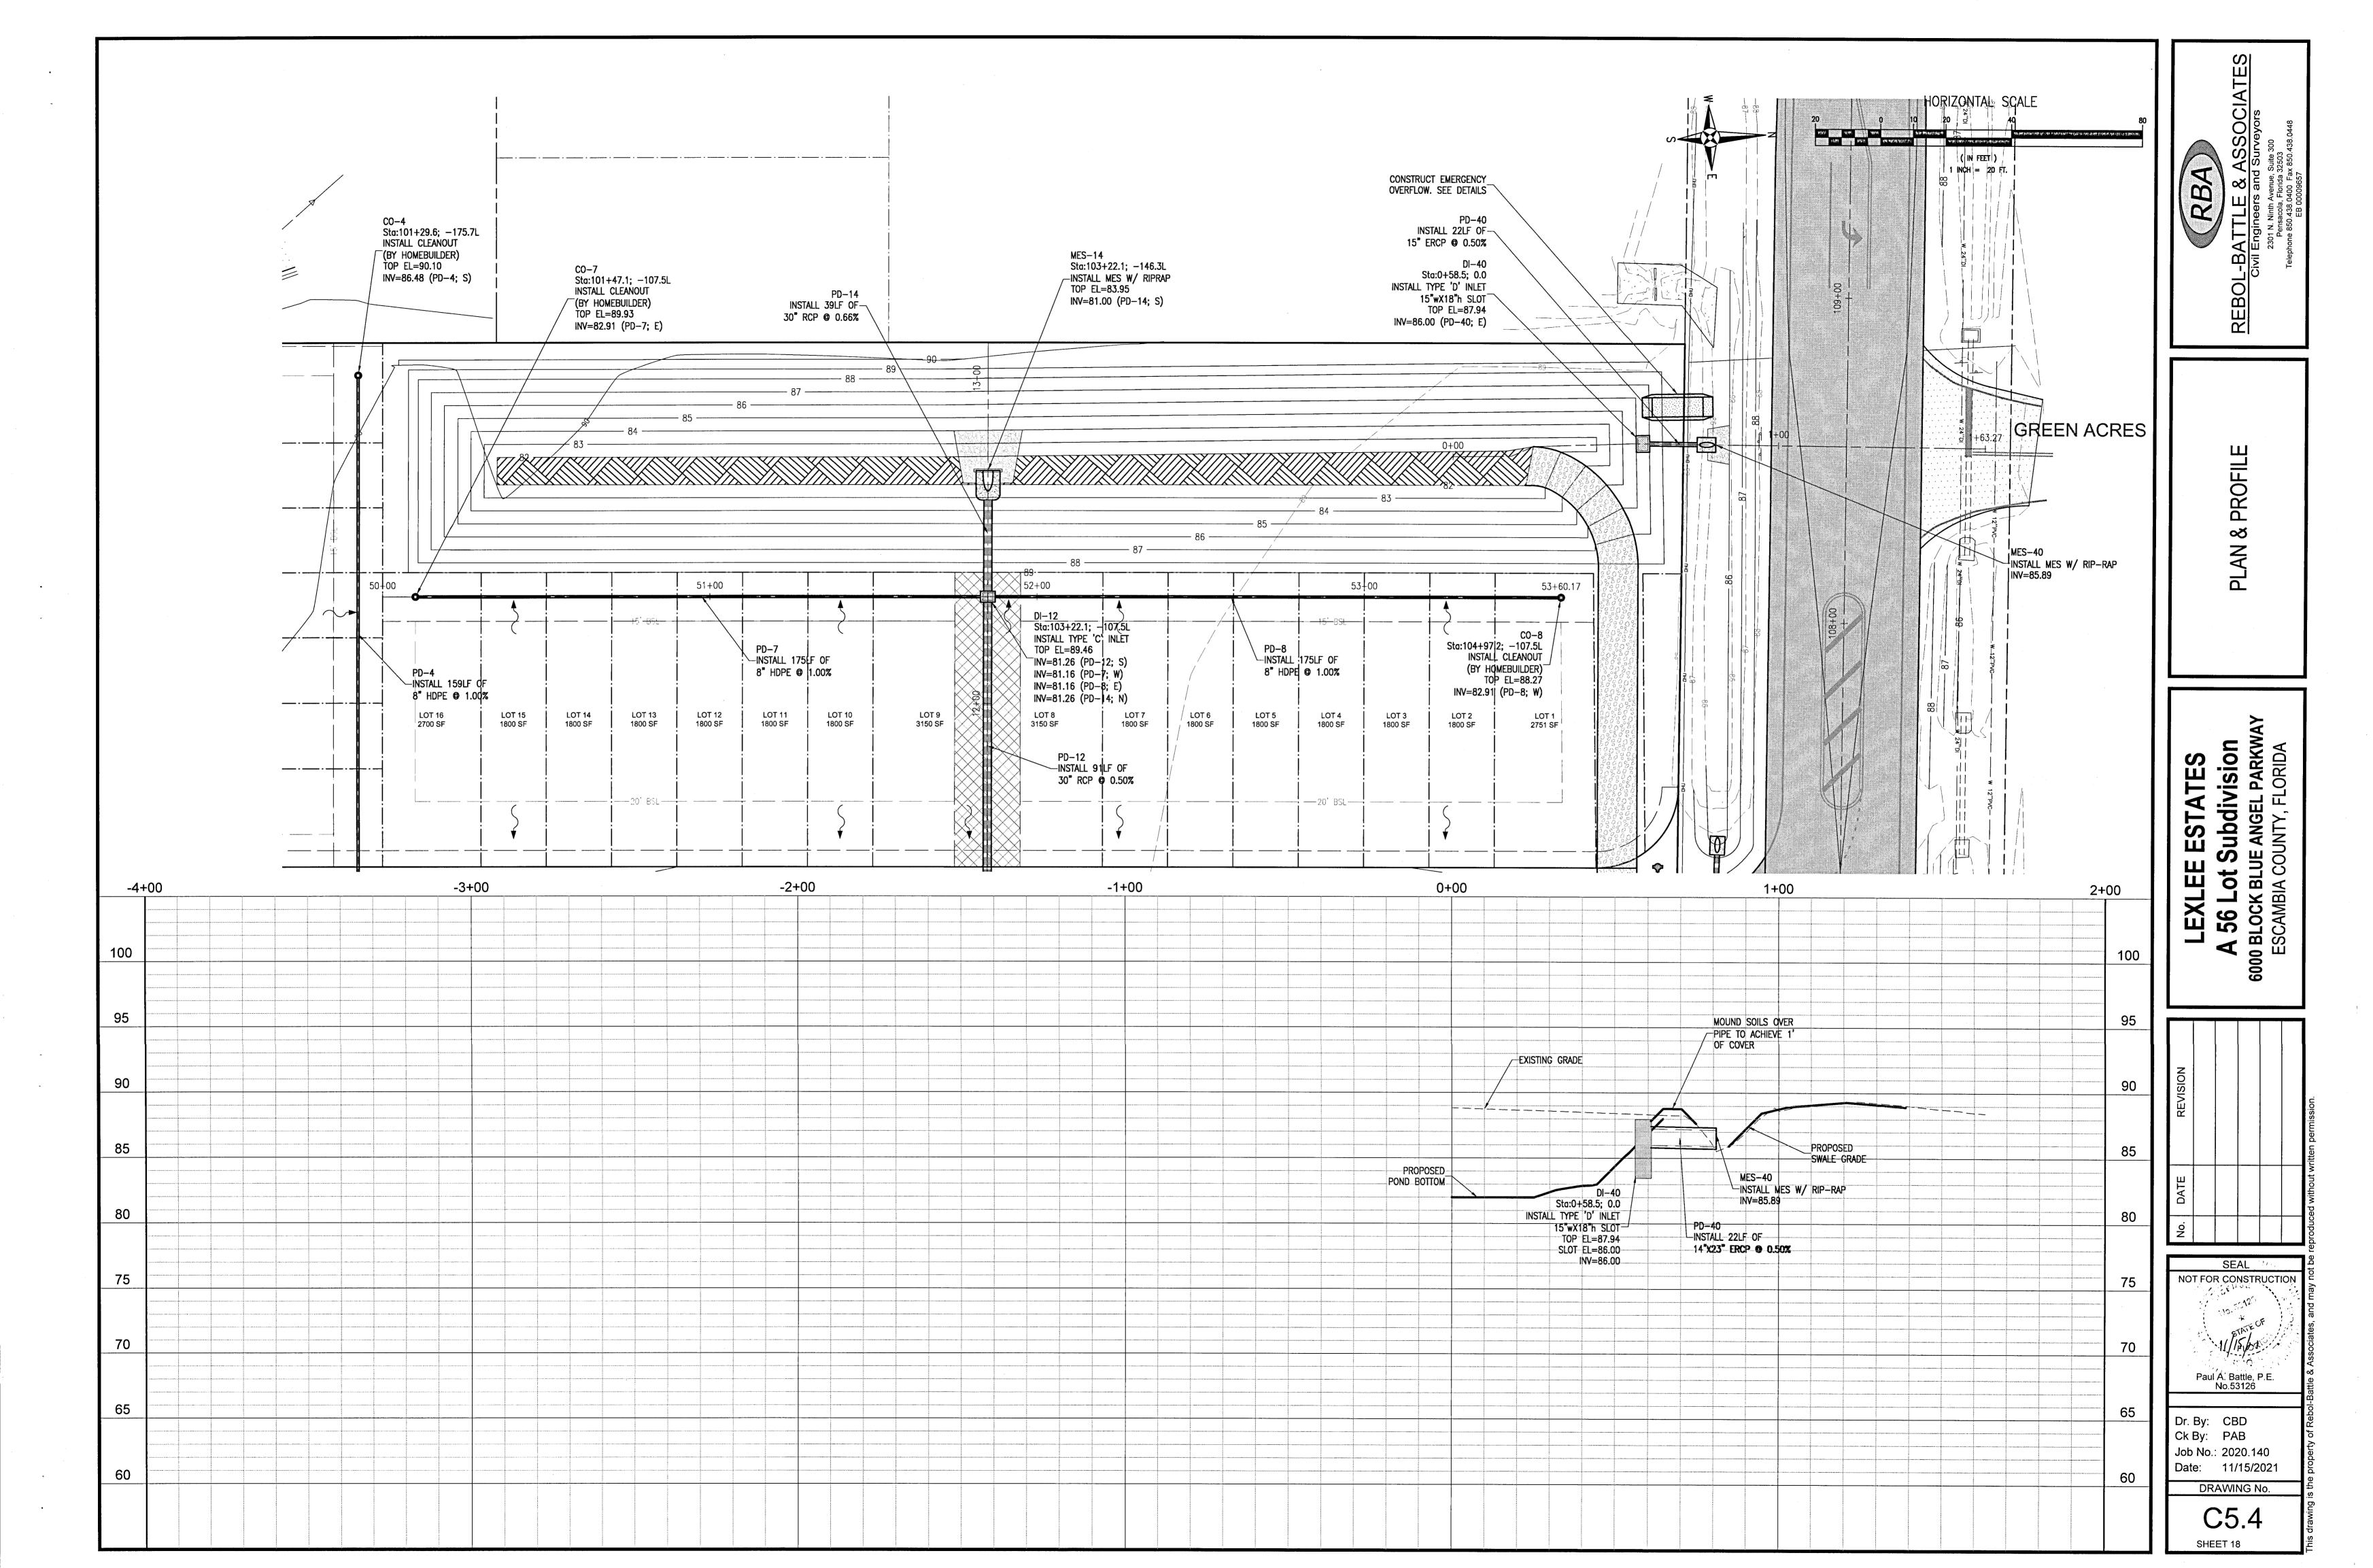


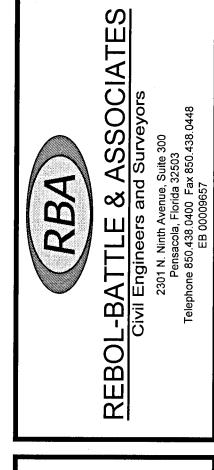


CROSS SECTIONS

LEXLEE ESTATES

A 56 Lot Subdivision
6000 BLOCK BLUE ANGEL PARKWAY
ESCAMBIA COUNTY, FLORIDA

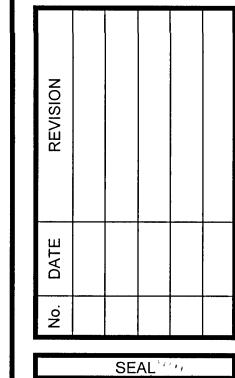

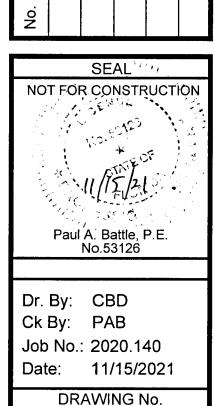

C6.0
SHEET 19


80 60 -50 -40 -30 -20 -10 0 10 20 30 40 50 60 HORIZONTAL SCALE: 1"=20"

LEXLEE BOULEVARD - Sta 106+00

CROSS SECTIONS


Dr. By: CBD Ck By: PAB Job No.: 2020.140 Date: 11/15/2021 DRAWING No.

C6.1

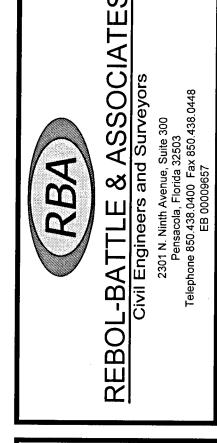

CROSS SECTIONS


LEXLEE ESTA
A 56 Lot Subdi
6000 BLOCK BLUE ANGE
ESCAMBIA COUNTY,

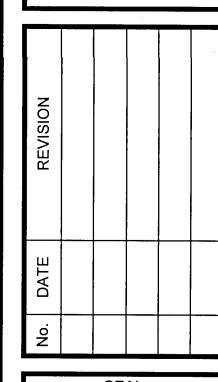


NOT FOR CONSTRUCTION Paul A. Battle, P.E. No.53126

Dr. By: CBD Ck By: PAB Job No.: 2020.140 Date: 11/15/2021 DRAWING No.

C6.2

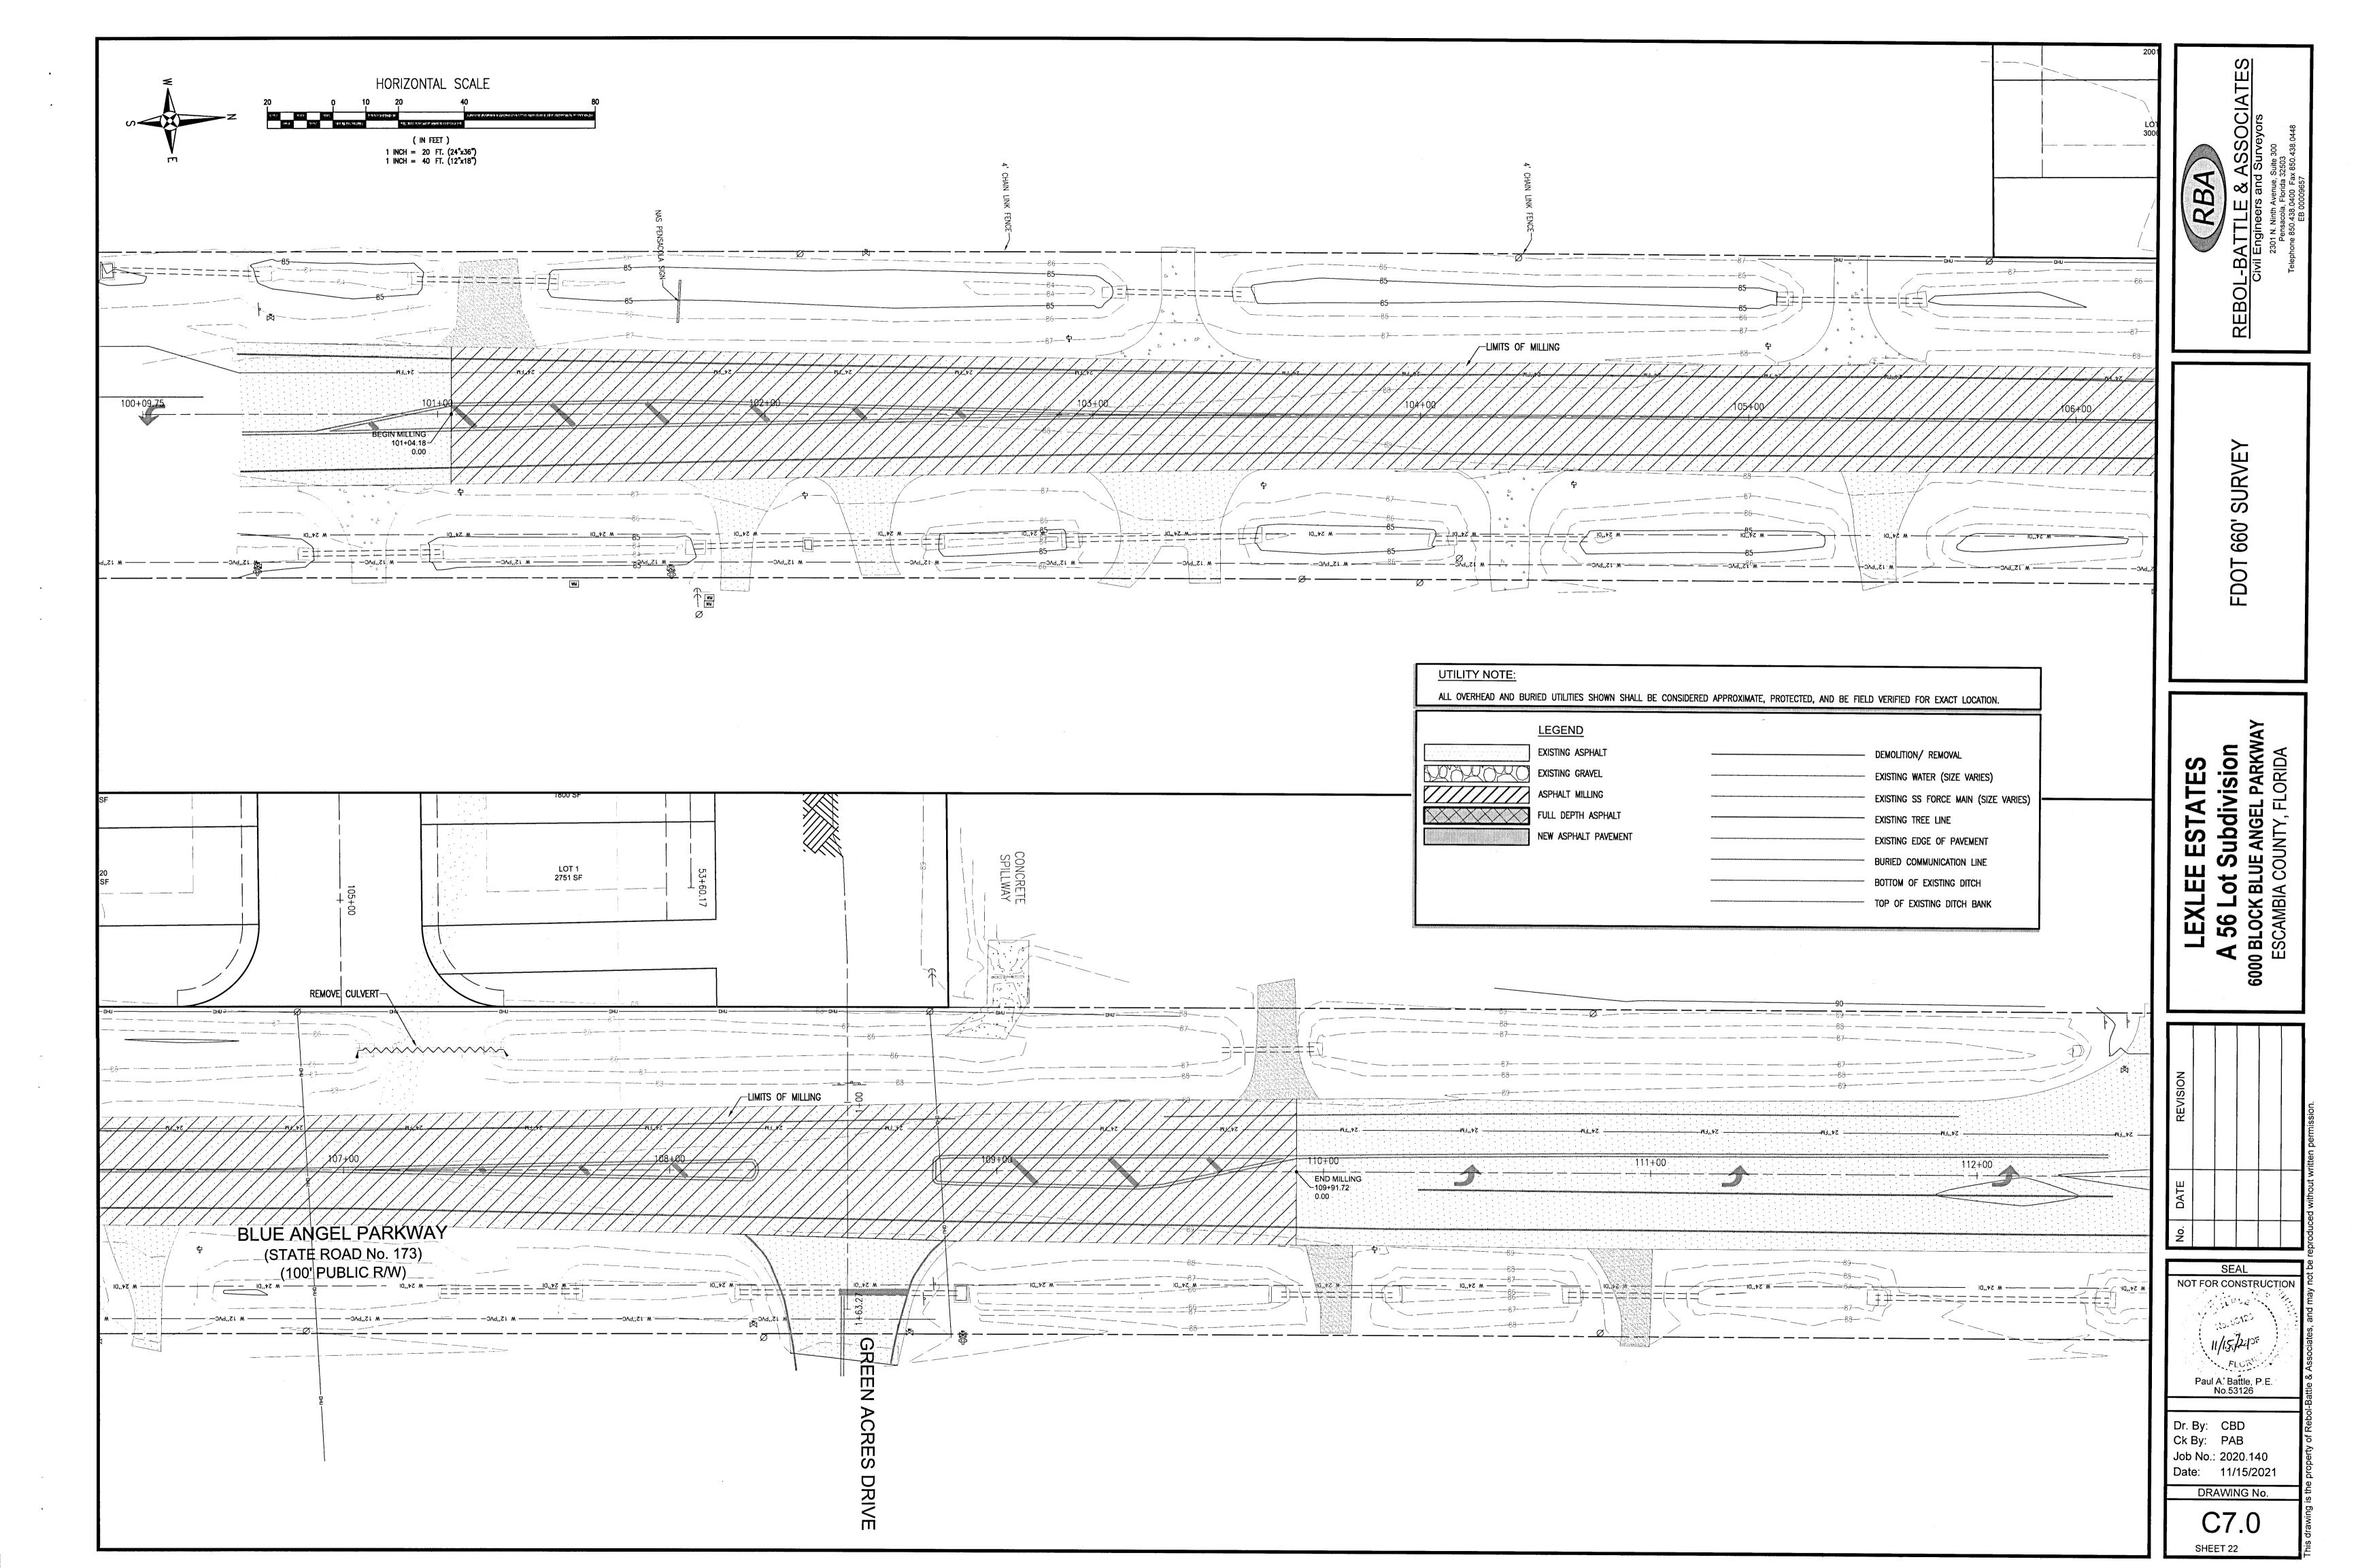

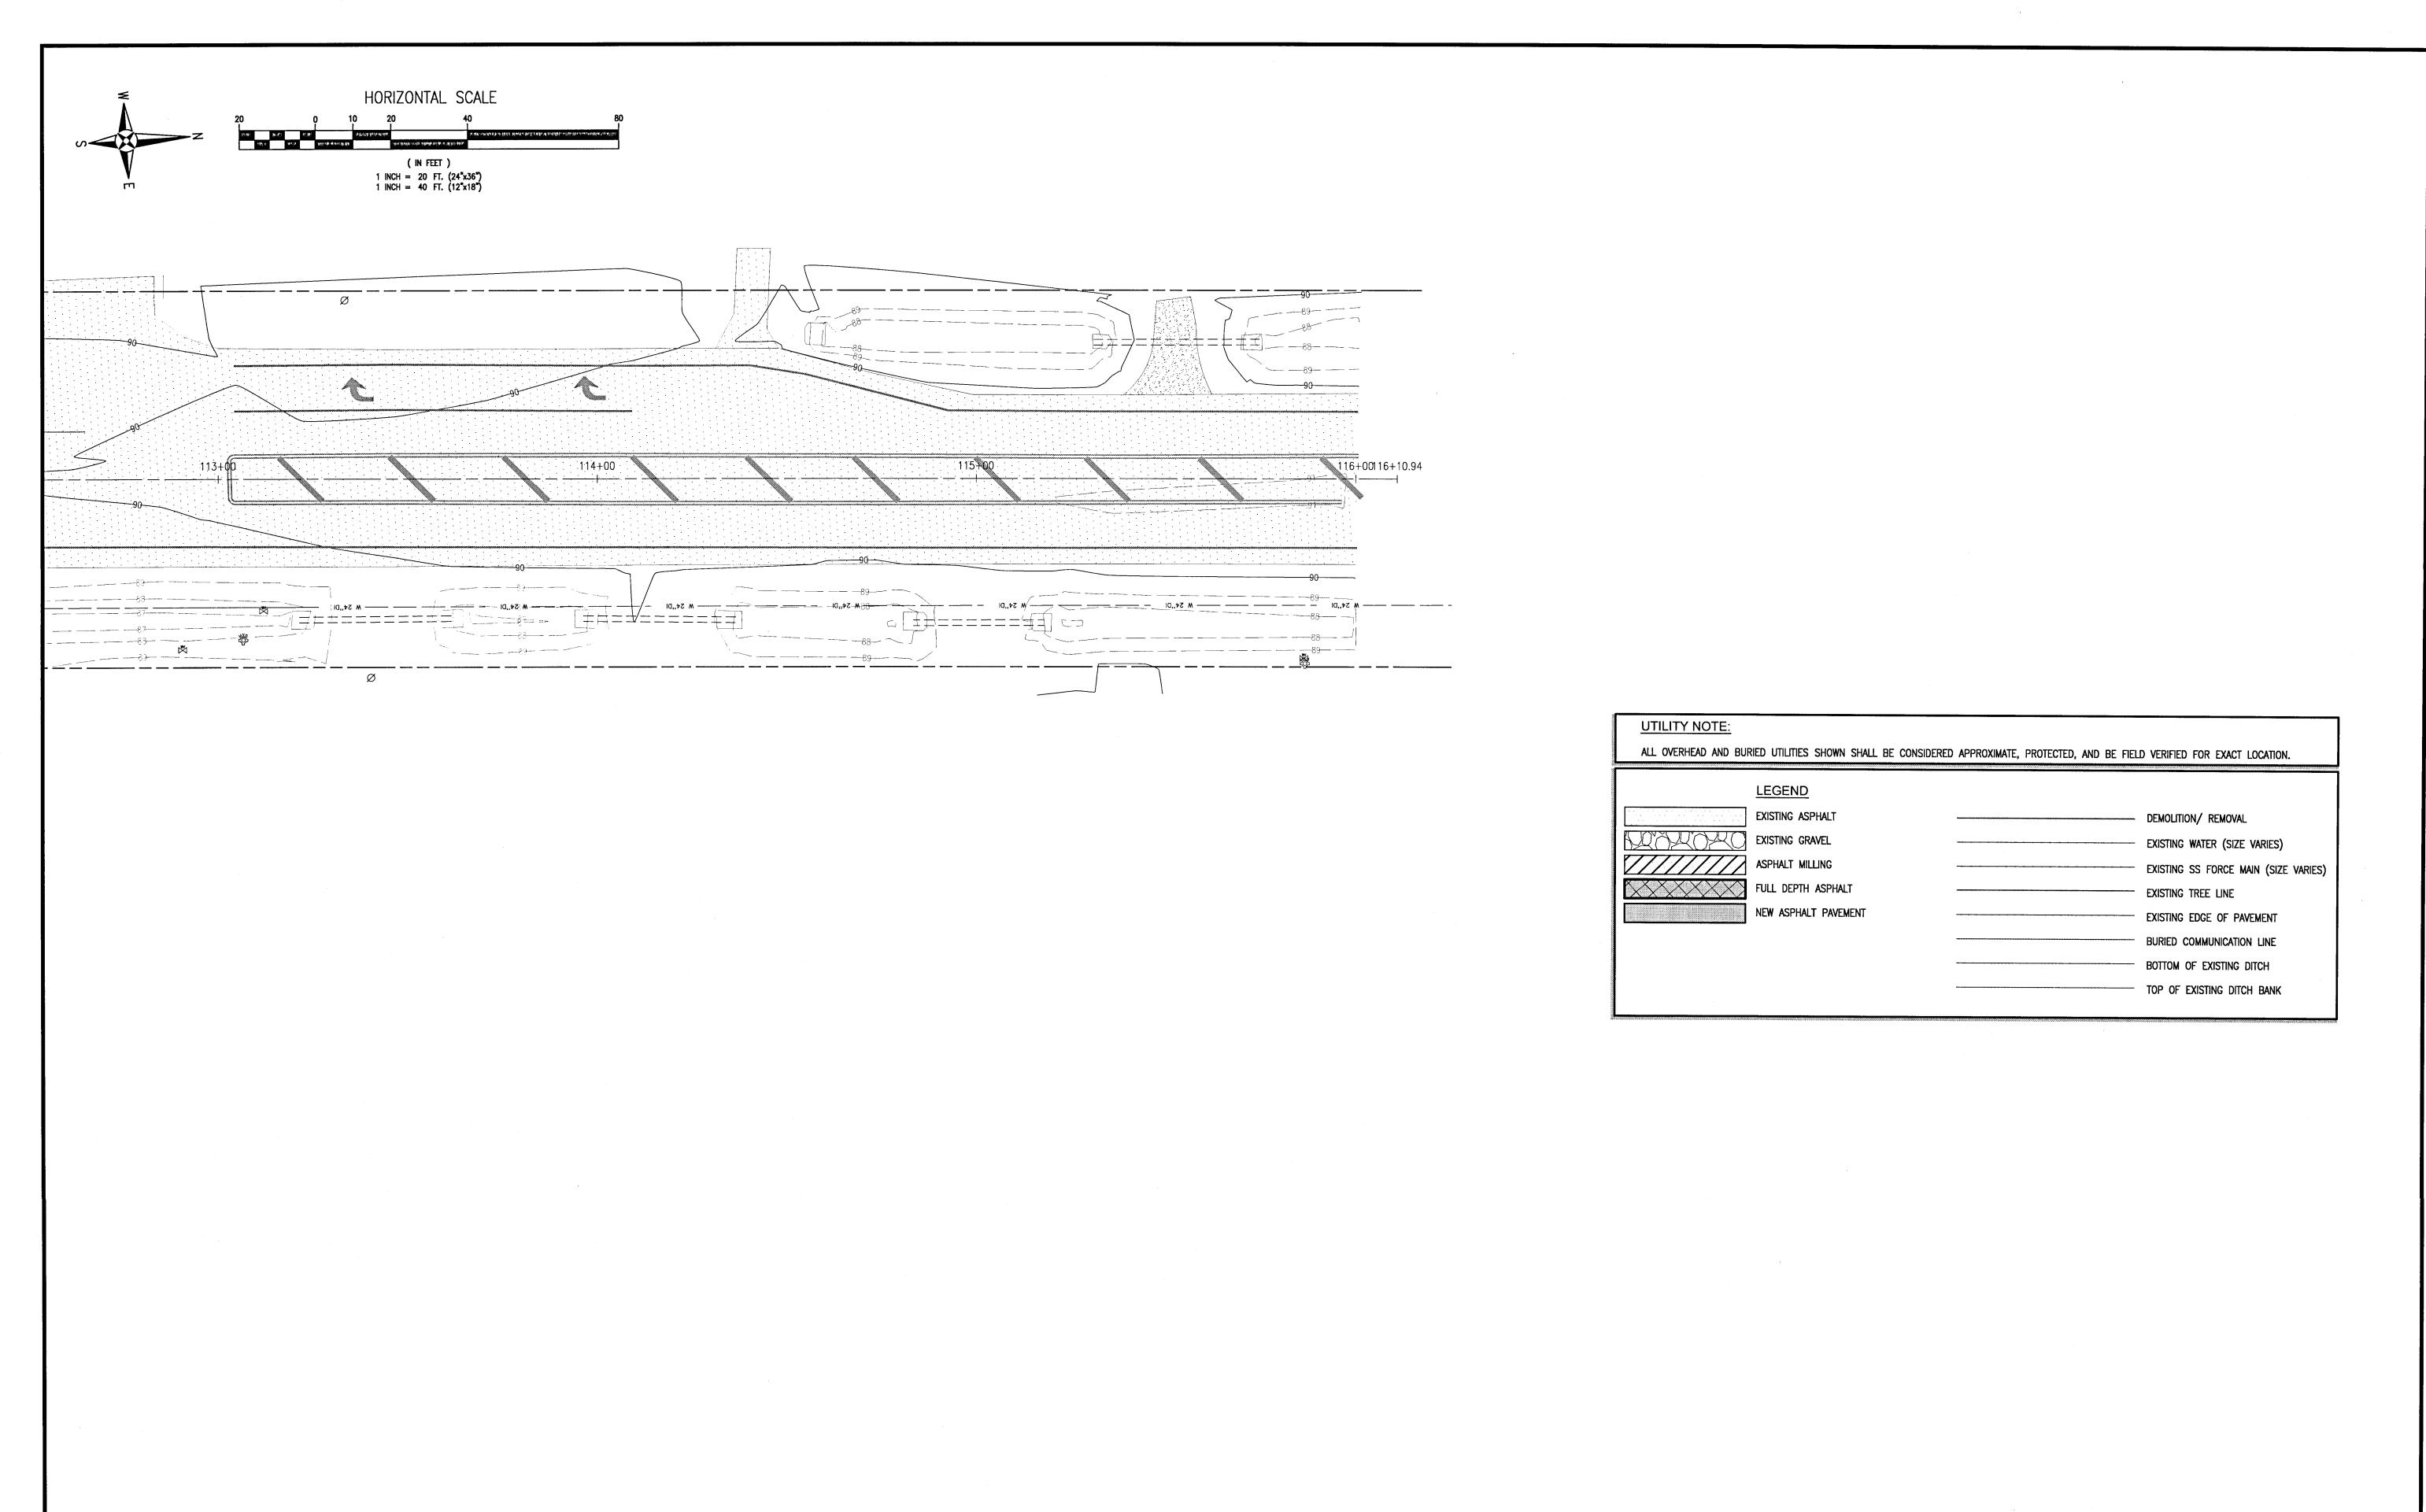

OL-BATTLE & ASSC Civil Engineers and Survey, 2301 N. Ninth Avenue, Suite 300 Pensacola, Florida 32503 Telephone 850.438.0400 Fax 850.438.044

FDOT 660' SURVEY

LEXLEE ESTATES

A 56 Lot Subdivision
6000 BLOCK BLUE ANGEL PARKWAY
ESCAMBIA COUNTY, FLORIDA

'				
	REVISION			
	DATE			
	No.			


SEAL
NOT FOR CONSTRUCTION


Paul A. Battle, P.E.
No.53126

Dr. By: CBD Ck By: PAB Job No.: 2020.140 Date: 11/15/2021


DRAWING No.

C7.1

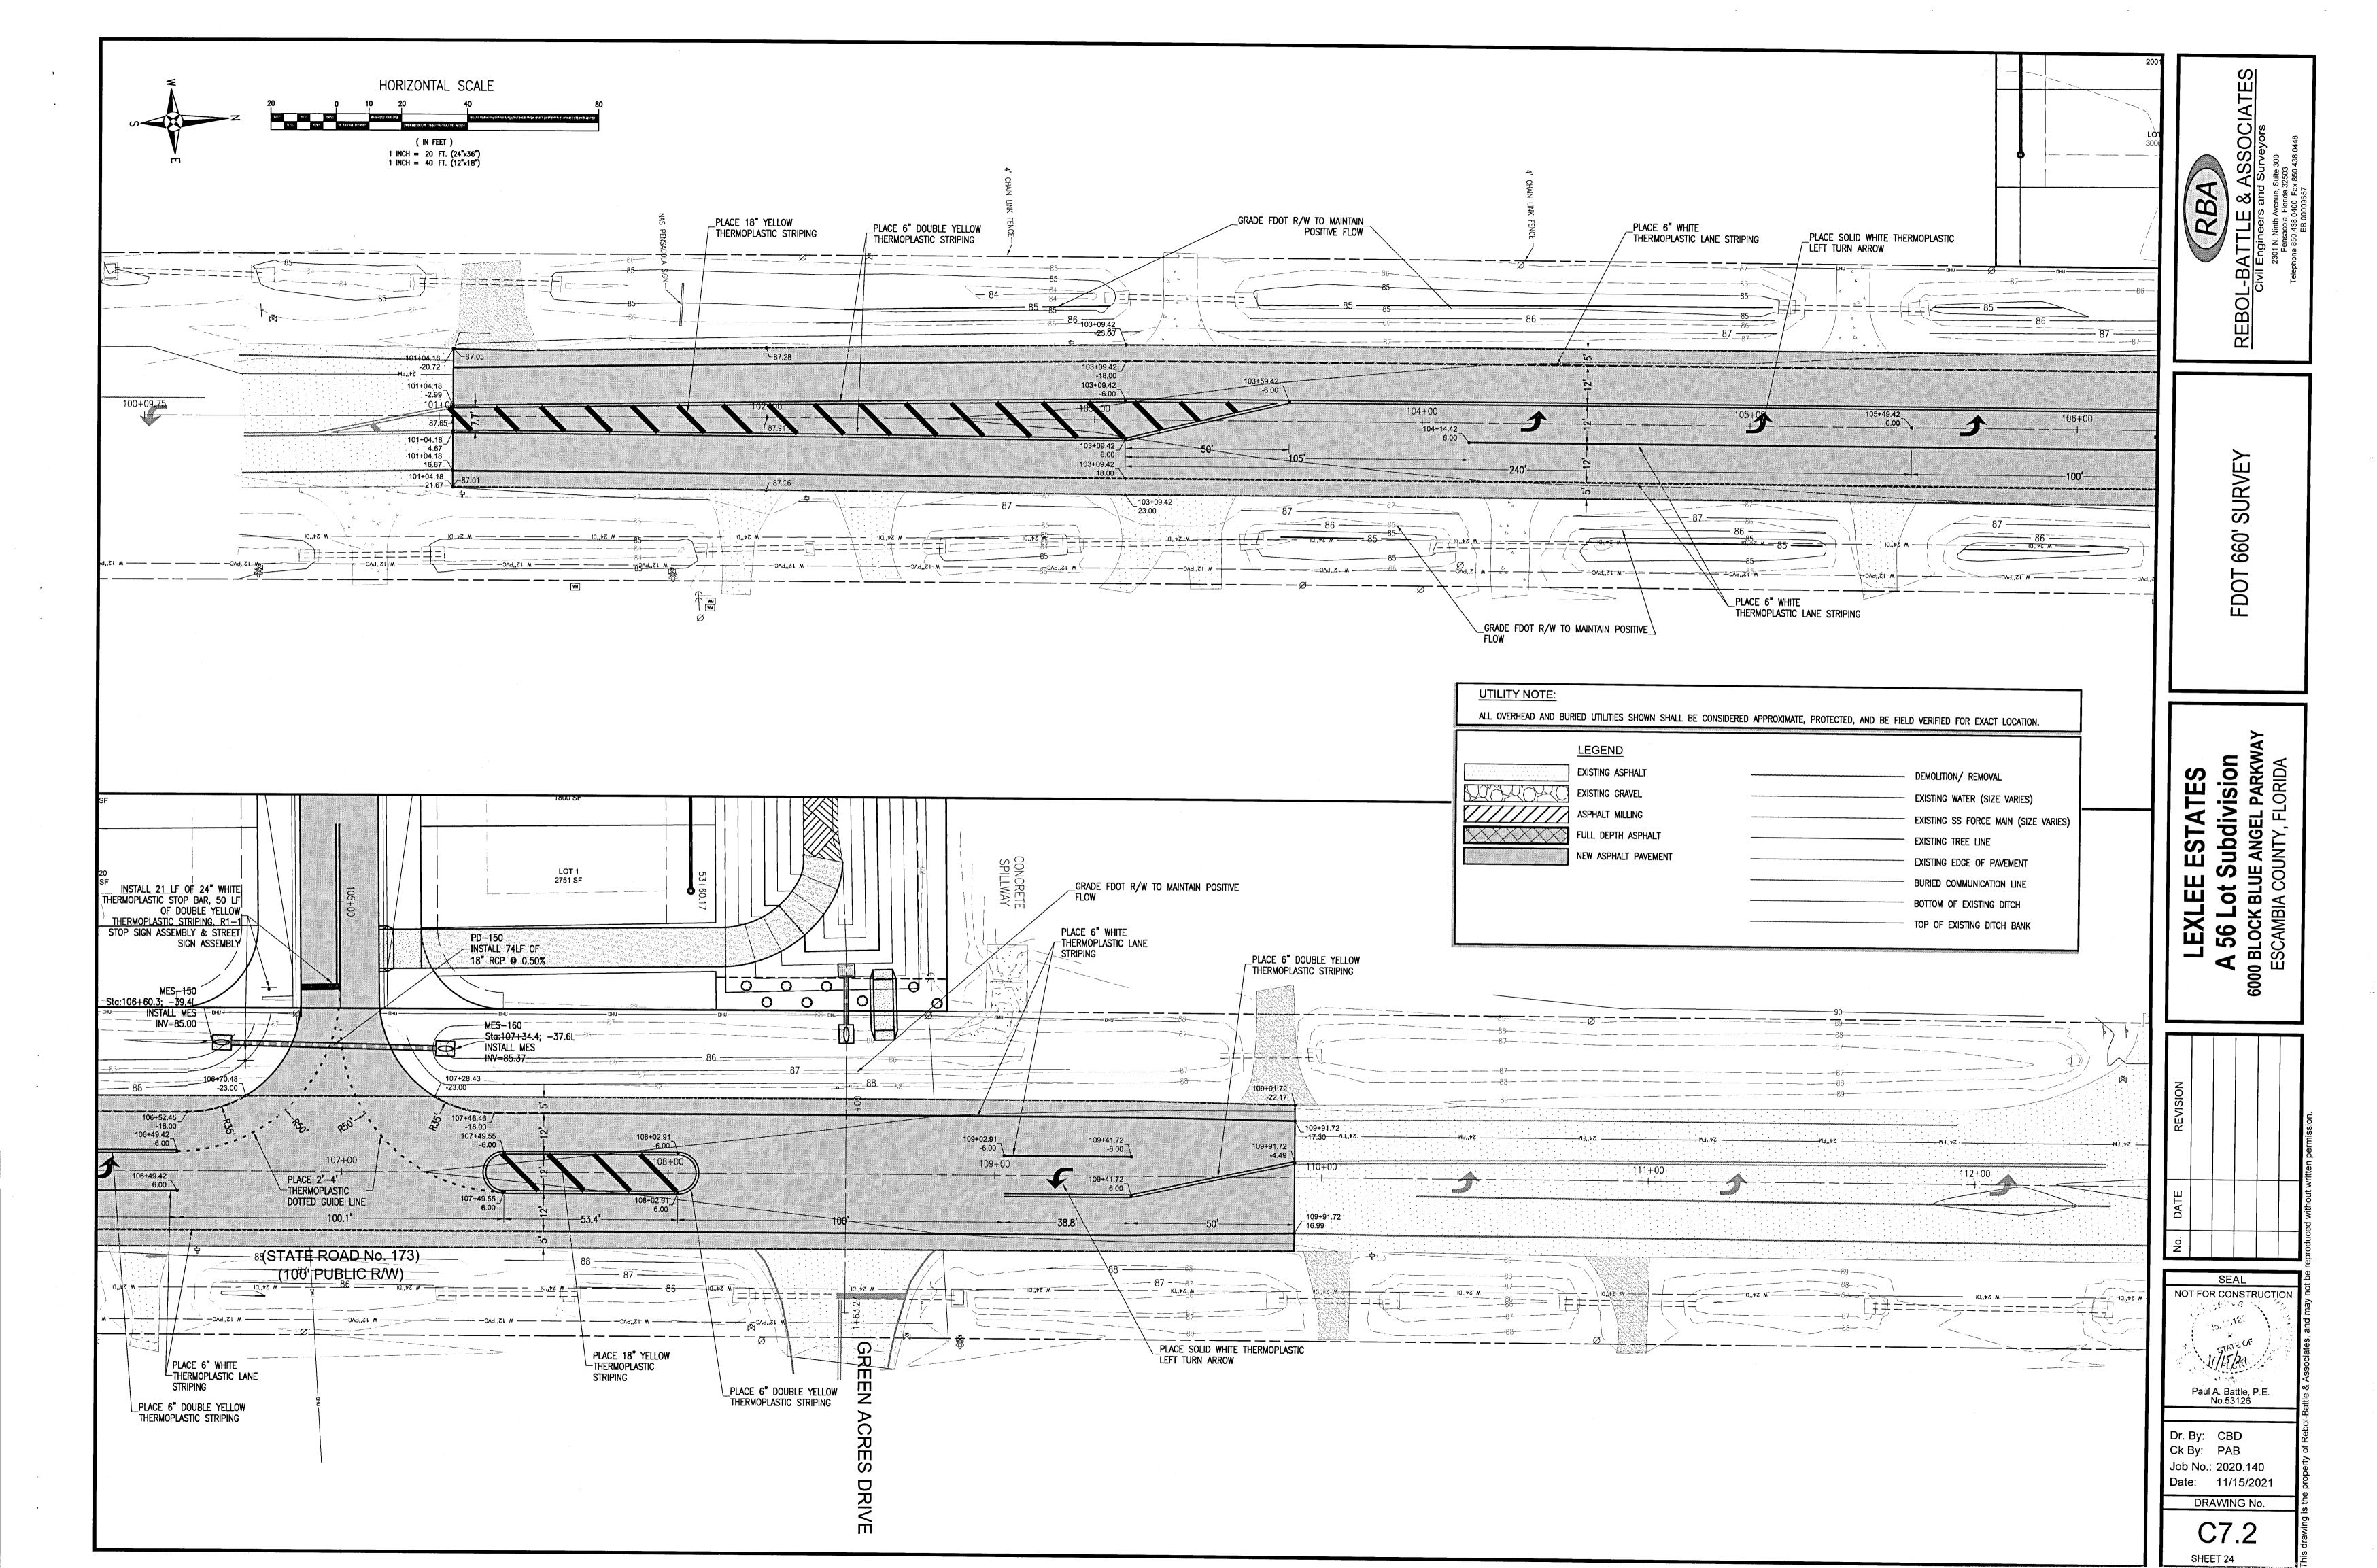

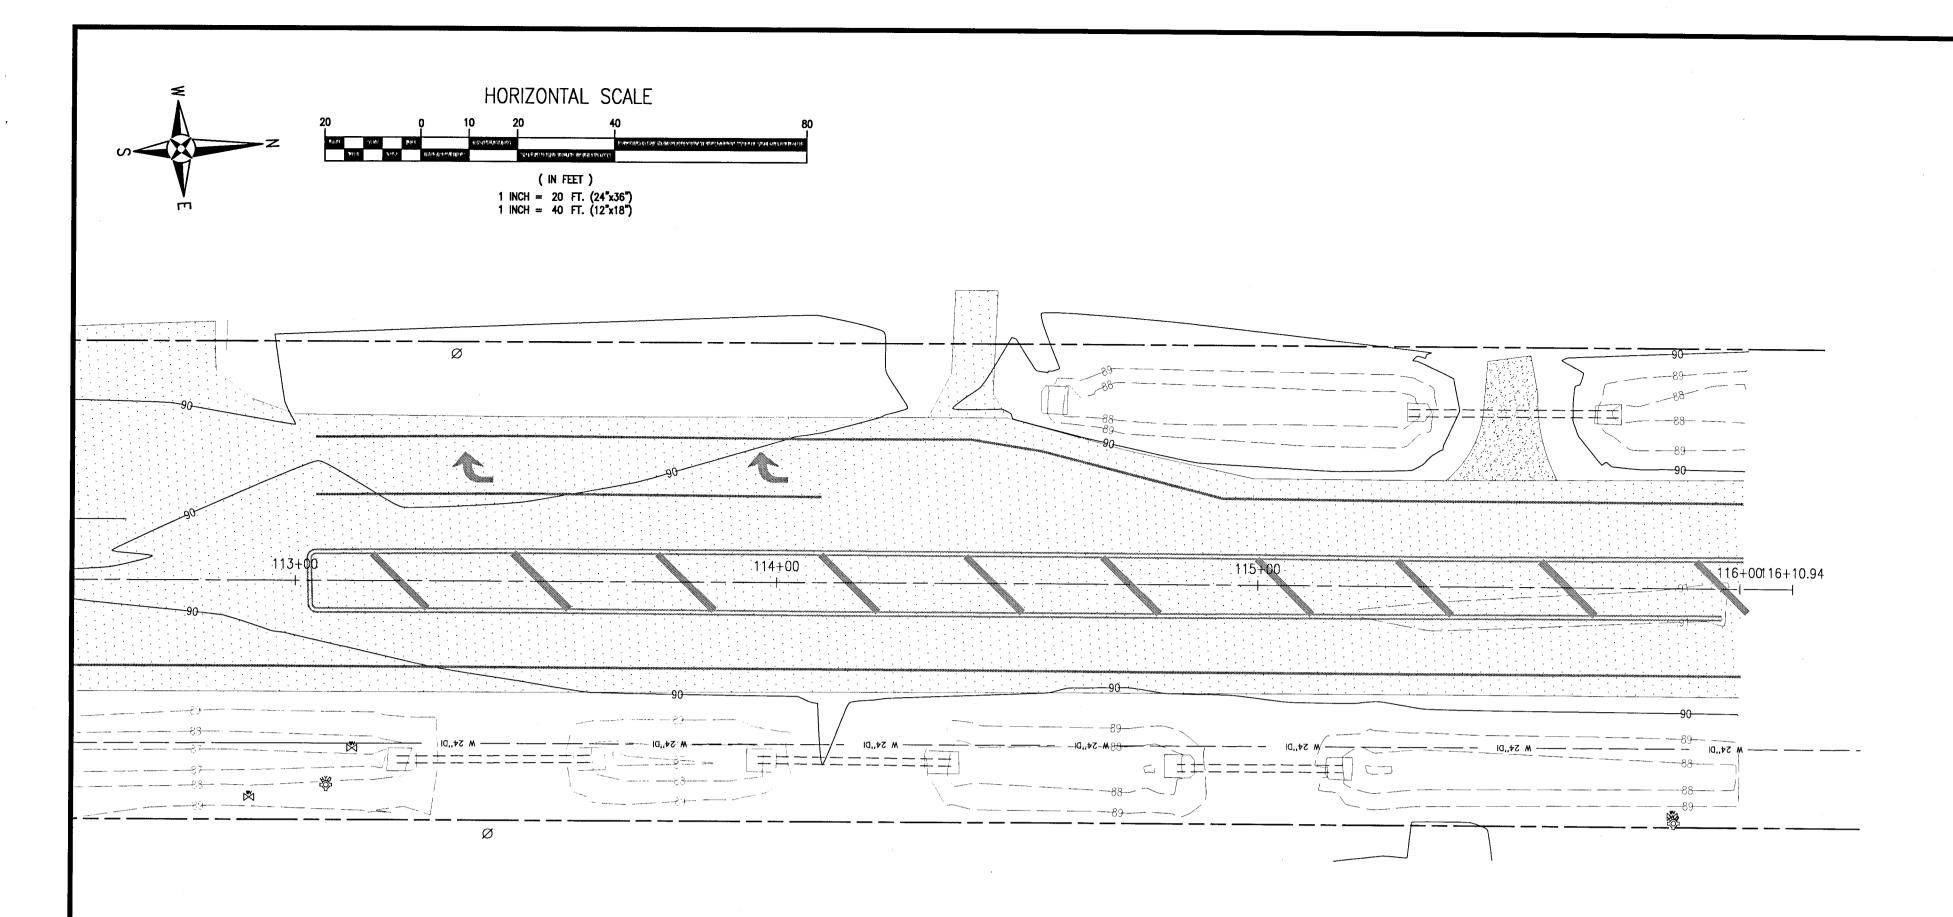

R1-1 30"X30"

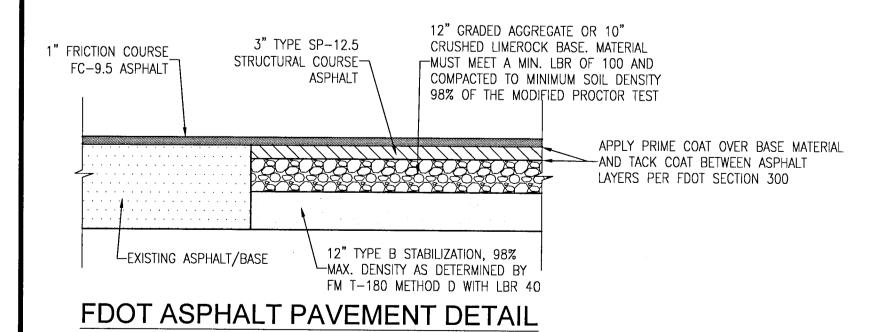

GENERAL NOTE:


THE DEPARTMENT WILL REVIEW ALL LANE/SIDEWALK CLOSURE, DETOUR, AND LANE SHIFT REQUESTS SEPARATELY FROM THE PERMIT PROCESS. FDOT APPROVAL IS REQUIRED BEFORE COMMENCEMENT OF WORK INVOLVING THE CLOSURE, DETOUR, OR LANE SHIFT FOR WORK ALONG THE STATE HIGHWAY SYSTEM.

LITUITY NOTE:			
UTILITY NOTE: ALL OVERHEAD AND BUI	RIED UTILITIES SHOWN SHALL BE CONSIDERE	ED APPROXIMATE, PROTECTED, AND BE I	FIELD VERIFIED FOR EXACT LOCATION.
	LEGEND		
	EXISTING ASPHALT		DEMOLITION/ REMOVAL
JOHO HO	EXISTING GRAVEL		EXISTING WATER (SIZE VARIES)
	ASPHALT MILLING		EXISTING SS FORCE MAIN (SIZE VAR
	FULL DEPTH ASPHALT		EXISTING TREE LINE
	NEW ASPHALT PAVEMENT		EXISTING EDGE OF PAVEMENT
			BURIED COMMUNICATION LINE
			BOTTOM OF EXISTING DITCH
			TOP OF EXISTING DITCH BANK

660' SURVEY FDOT

LEXLEE ESTATES

A 56 Lot Subdivision
6000 BLOCK BLUE ANGEL PARKWA
ESCAMBIA COUNTY, FLORIDA

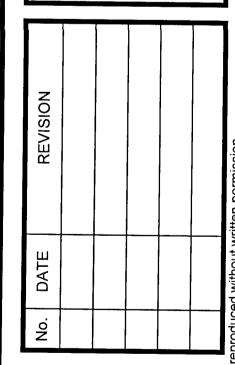


NOT FOR CONSTRUCTION 11/15/25 Paul A. Battle, P.E. No.53126 Dr. By: CBD Ck By: PAB Job No.: 2020.140 Date: 11/15/2021


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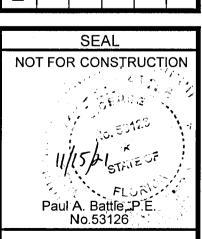
C7.3

SHEET 25

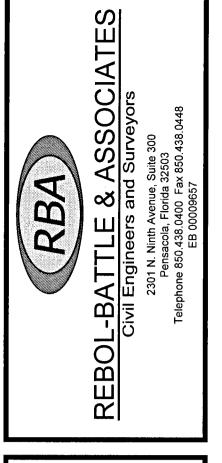


FDOT 660' SURVEY



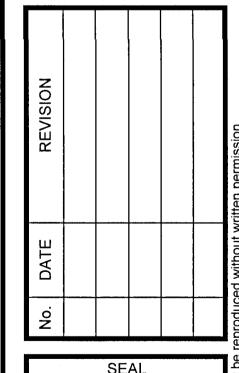


Dr. By: CBD Ck By: PAB Job No.: 2020.140 Date: 11/15/2021 DRAWING No.


C7.4

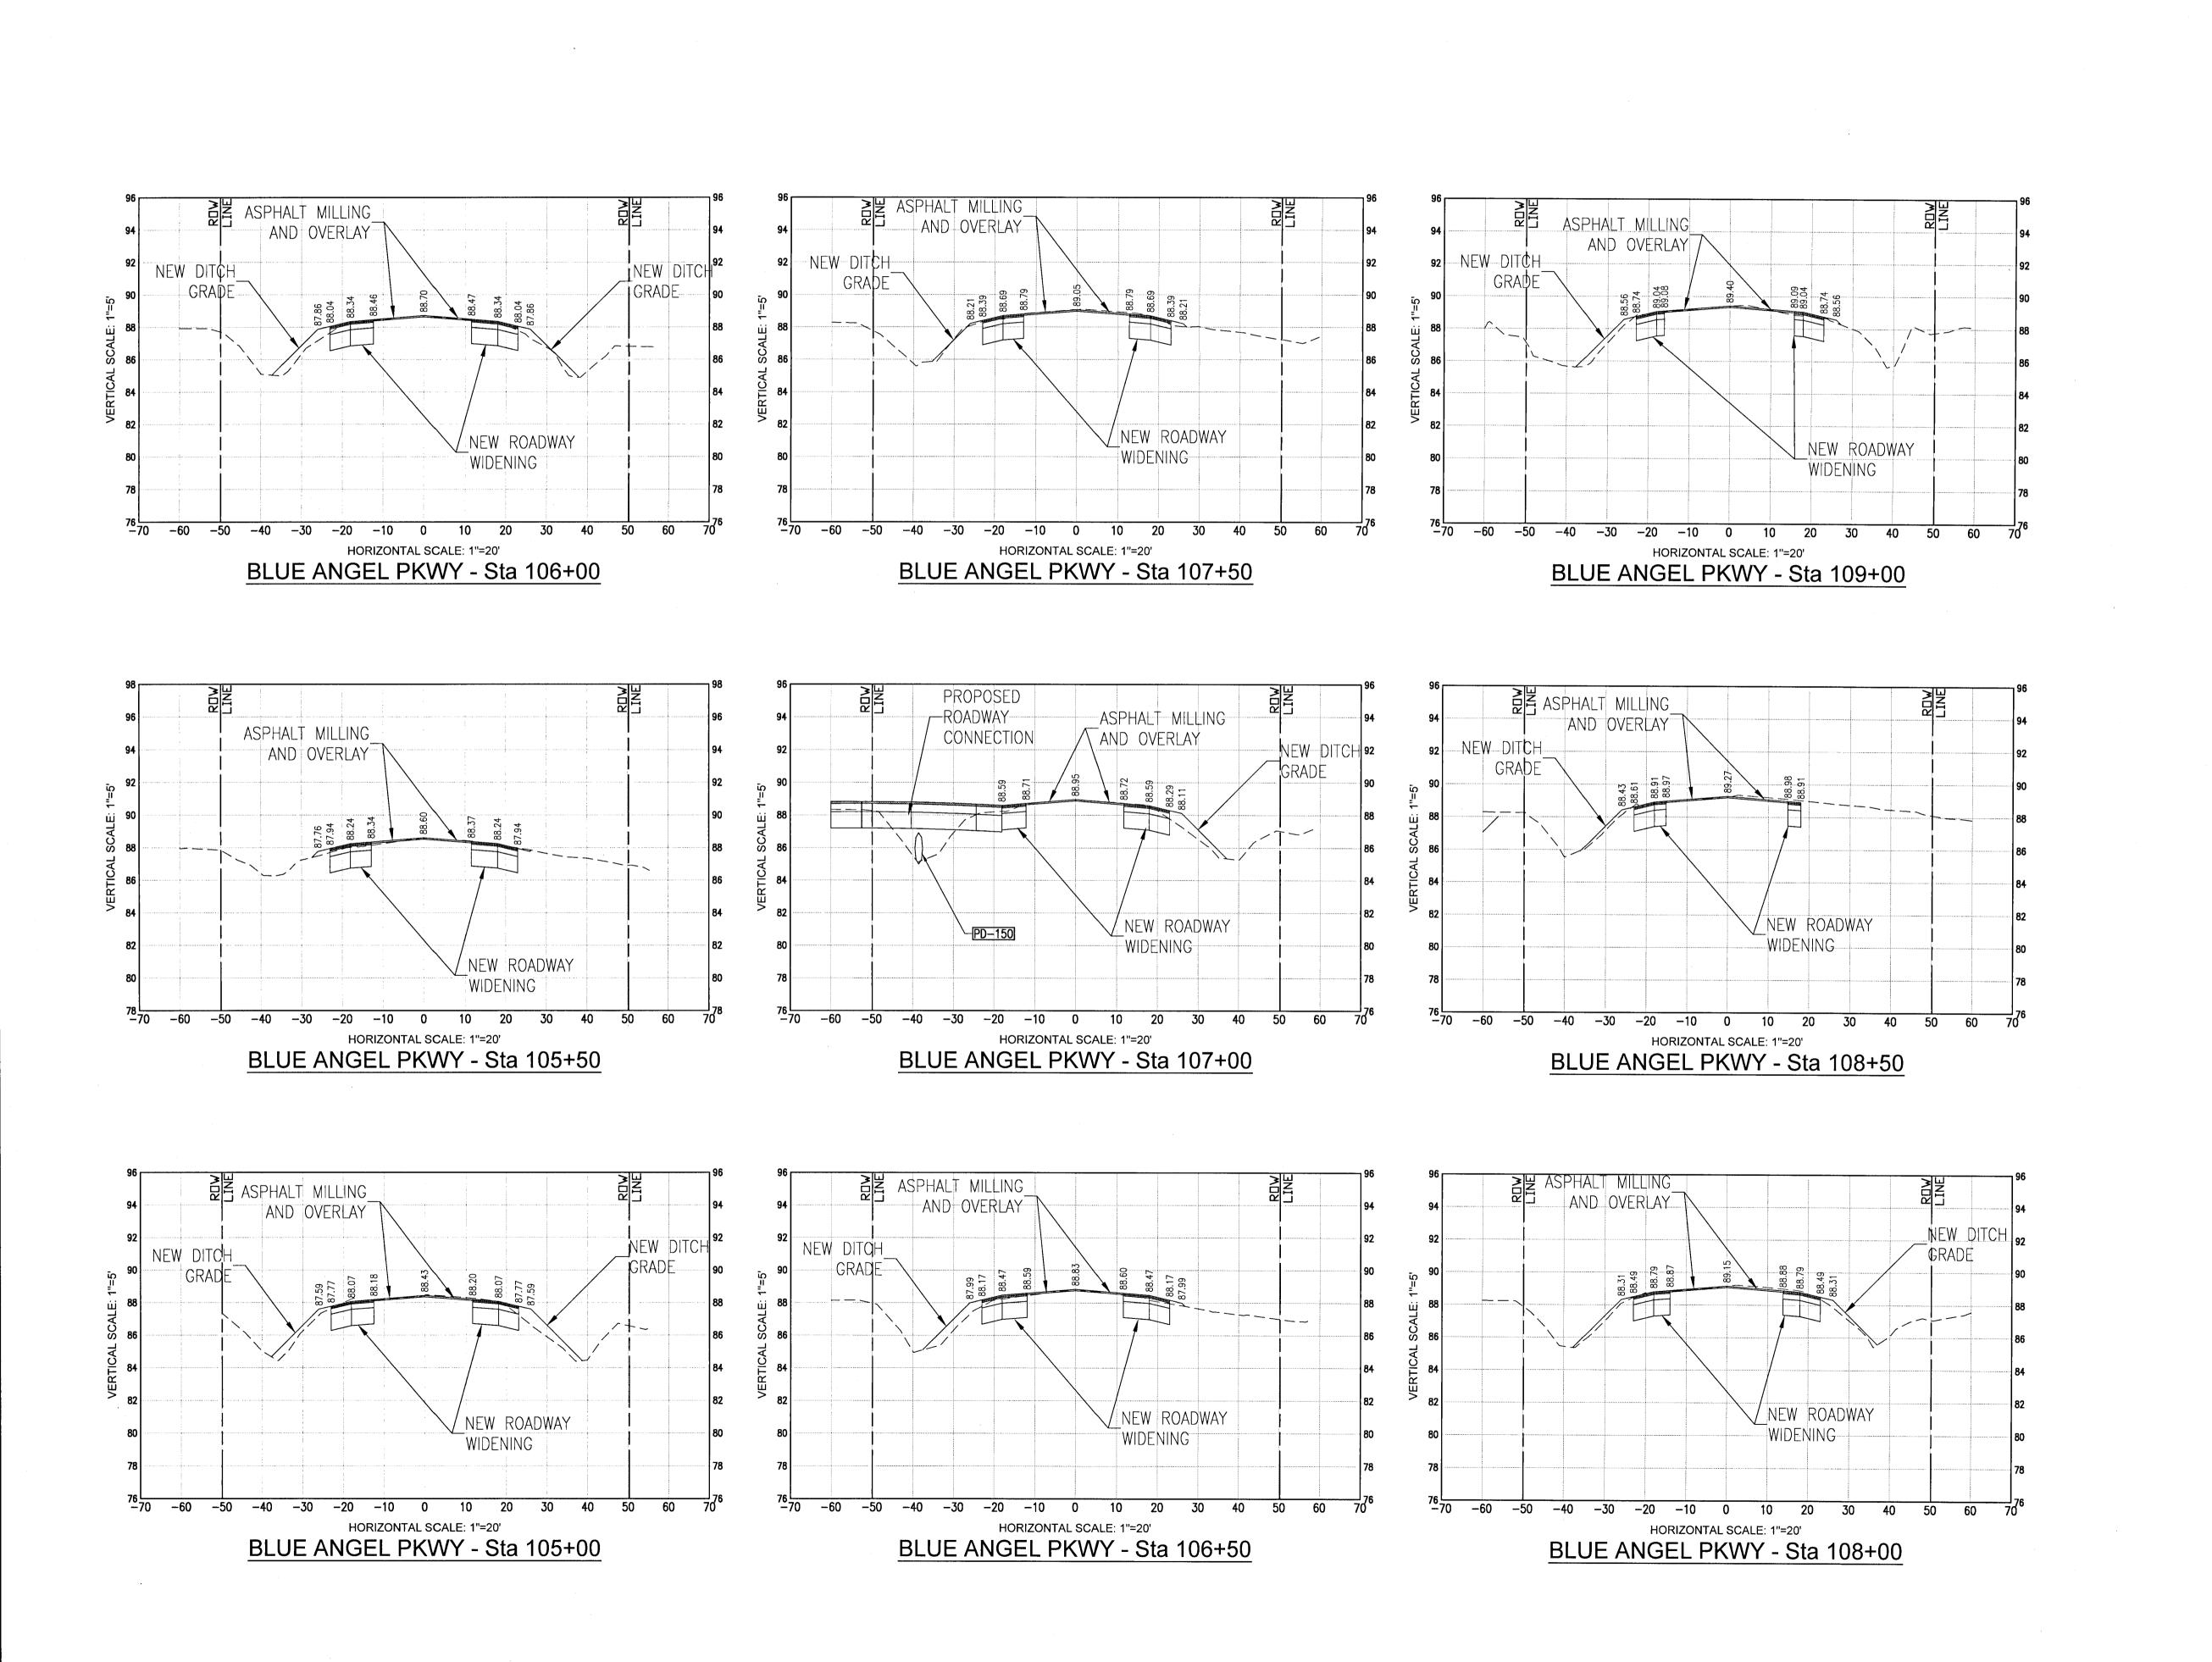

FDOT 660' SURVEY

A 56 Lot Subdi 6000 BLOCK BLUE ANGE ESCAMBIA COUNTY, R

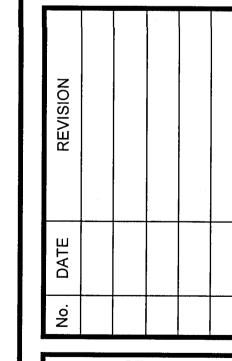


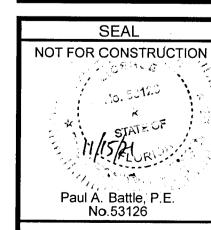

Dr. By: CBD Ck By: PAB Job No.: 2020.140 Date: 11/15/2021 DRAWING No.

C7.5


SHEET 27

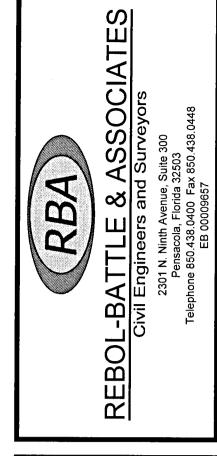


FDOT 660' SURVEY

A 56 Lot Subdivision

BLOCK BLUE ANGEL PARKWAY

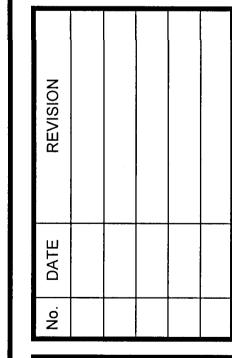

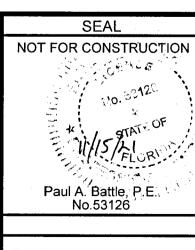


Dr. By: CBD Ck By: PAB Job No.: 2020.140 Date: 11/15/2021

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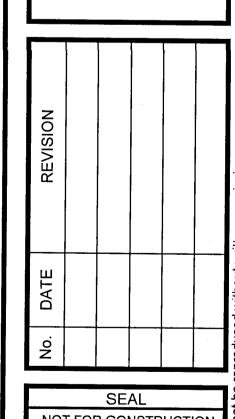
C7.6

HORIZONTAL SCALE: 1"=20'
BLUE ANGEL PKWY - Sta 115+50

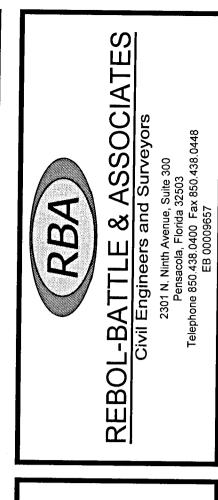

FDOT 660' SURVEY

A 56 Lot Subdivence BLOCK BLUE ANGELESCAMBIA COUNTY, FI



NOT FOR CONSTRUCTION Paul A. Battle, P.E. No.53126

Dr. By: CBD Ck By: PAB Job No.: 2020.140 Date: 11/15/2021

DRAWING No.

SHEET 29